RESIDENTIAL DEVELOPMENT AT 11 STOREY AVENUE, HAMPTON

DRAWING LIST

COVER SHEET GENERAL NOTES DEMOLITION PLAN SITE PLAN SITE CUT PLAN SLAB SETOUT PLAN GROUND FLOOR PLAN FIRST FLOOR PLAN **ROOF PLAN**


OUTDOOR LIVING AREA PLAN FRONT GARDEN PLAN GROUND FLOOR RCP FIRST FLOOR RCP NORTH & EAST ELEVATIONS SOUTH & WEST ELEVATIONS


SECTION

LONGITUDINAL SECTION + TYPICAL DETAILS

CANTILEVER DETAILS WINDOW & DOOR SCHEDULE



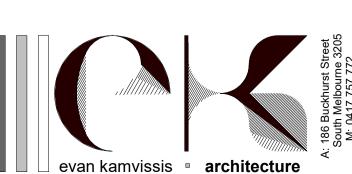

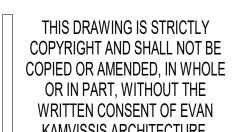

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REV	DATE	DETAILS	SHEET
*	11/06/2021	ISSUE FOR BUILDING PERMIT	COVERS

PROJECT
PROPOSED RESIDENTIAL DEVELOPMENT AT 11 STOREY AVENUE, HAMPTON
CLIENT NAME: CORINNA & BOB NEILL

DATE:	JULY 2020	
SCALE:	1:50 AT A1 / 1:100 AT A3	
DWG No.:	2013	\
SHEET No	.: A000 REVISION:	



PROJECT DEVELOPMENT DESCRIPTION

· BUILDER SHALL COMPLY WITH LOCAL AUTHORITIES, MUNICIPAL BY-LAWS, BUILDING REGULATIONS AND THE BUILDING CODE OF AUSTRALIA.

TOWN PLANNING: BAYSIDE CITY COUNCIL APPLICATION NO: N/A

- CLASSIFICATION OF BUILDING: CLASS 1A SINGLE RESIDENTIAL DWELLING
- · STOREYS: TWO (2)
- · RISE IN STOREYS: 3.45 (GROUND FLOOR TO FIRST FLOOR)
- · EFFECTIVE HEIGHT: 7.0 MAX. FROM NGL
- \cdot FIRE SAFETY SYSTEMS:-A) INSTALLATION OF A SMOKE ALARM/ DETECTION SYSTEM.
- EGRESS FACILITIES: *
- · ALL LEVELS ARE TO REFER TO EXISTING LEVELS ON DWELLING & SITE SURVEY. NOTE LEVELS ARE TO AHD. ALL LEVELS TO BE CONFIRMED ON SITE.

LEVEL LEGEND

- RL: REDUCED LEVEL
- EL: EXISTING LEVEL
- SFL: STRUCTURAL FLOOR LEVEL
- FFL: FINISHED FLOOR LEVEL
- \cdot Flood Level: Building has been identified as not being in a flood prone area.
- · LEGAL POINT OF DISCHARGE- REFER TO INFORMATION FROM LOCAL COUNCIL FOR DISCHARGE POINT & CIVIL ENGINEER DOCS.
- A THESE PLANS SHALL BE READ IN CONJUNCTION WITH ANY STRUCTURAL OR CIVIL ENGINEERING COMPUTATIONS & DRAWINGS. DO NOT SCALE DRAWINGS, USE WRITTEN DIMENSIONS ONLY
- **B** THE OWNER AND ALL SUBCONTRACTORS SHALL VERIFY ALL DIMENSIONS, LEVELS, SETBACKS & SPECIFICATIONS PRIOR TO COMMENCING ANY WORKS OR ORDERING MATERIALS & SHALL BE RESPONSIBLE FOR ENSURING THAT ALL BUILDING WORKS CONFORM TO THE NATIONAL CONSTRUCTION CODE OF AUSTRALIA WITH ITS RELEVANT REFERENCED AND CORRESPONDING AUSTRALIAN STANDARDS (CURRENT EDITIONS), STATE BASED BUILDING REGULATIONS, LOCAL PLANNING REQUIREMENTS AND BY-LAWS.

REPORT ALL DISCREPANCIES TO THIS OFFICE FOR CLARIFICATION.

C THIS DOCUMENTATION HAS BEEN PREPARED FOR THE EXCLUSIVE USE OF THE CHATHAM HOMES. ANY OTHER PERSON WHO USES OR RELIES ON THESE PLANS WITHOUT 'EVAN KAMVISSIS ARCHITECTURE' WRITTEN CONSENT DOES SO AT THEIR OWN RISK & NO RESPONSIBILITY IS ACCEPTED BY CHATHAM FOR SUCH USE AND/OR RELIANCE. THESE NOTES ARE NEITHER EXHAUSTIVE NOR A SUBSTITUTE FOR REGULATIONS, STATUTORY REQUIREMENTS, BUILDING

PRACTICE OR CONTRACTUAL OBLIGATIONS & UNLESS EXPRESSLY STATED OTHERWISE, ARE PROVIDED ONLY AS GUIDELINES.

- D ALL WALL AND CEILING DIMENSIONS ARE STRUCTURAL SIZES ONLY.
- DIMENSIONS ARE NOMINAL UNLESS OTHERWISE STATED. DIMENSIONS DO NOT INCLUDE FLOOR, CLADDING, LININGS OR FINISHES, INTERNAL SIZES WILL VARY WHEN FINISH MATERIALS ARE TAKEN INTO ACCOUNT.
- F TIMBER CONSTRUCTION IS TO CONFORM TO THE REQUIREMENTS OF AS1684 & AS1720. ALL TIMBER SPECIFIED ON THE DRAWINGS IS TO HAVE FOLLOWING MINIMUM STRESS GRADES UNLESS OTHERWISE

MGP12

UNSEASONED HARDWOOD... SEASONED OR KILN DRIED HARDWOOD..... F17 LAMINATED PINE.. RADIATA PINE... DOUGLAS FIR.. MACHINE GRADED PINE.


NOTED:-

MACHINE GRADED PINE.

F EXHAUST SYSTEM TO DISCHARGE INTO ROOF SPACE WHERE NOT ABLE TO DISCHARGE TO OUTDOOR AIR. IF DISCHARGE IS TO ROOF SPACE, VENTILATION IN THE ROOF SPACE TO COMPLY WITH NCC 2019 VOL.2 CLAUSE 3.8.7.4.

- **G** ALL WORKS SHALL COMPLY WITH BUT NOT BE LIMITED TO THE FOLLOWING AUSTRALIAN AND NEW ZEALAND STANDARDS AS REFERENCED IN THE NATIONAL CONSTRUCTION CODE OF AUSTRALIA AND/OR THE NEW ZEALAND BUILDING CODE AS APPLICABLE:-
- AUSTRALIA
- AS 1056-1991 STORAGE WATER HEATERS
- AS 1273-1991 UNPLASTICIZED UPVC DOWNPIPE AND FITTINGS FOR RAINWATER
- AS 1288-2006 GLASS IN BUILDINGS SELECTION & INSTALLATION
- AS 1289-1997 METHODS OF TESTING SOILS FOR ENGINEERING PURPOSES
- AS 1397-2011 CONTINUOUS HOT DIP METALLIC COATED SHEET STEEL AND STRIP.
- AS 1657-1992 FIXED PLATFORMS, WALKWAYS, STAIRWAYS AND LADDER
- AS 1668-2009 MECHANICAL VENTILATION & AIR-CON IN BUILDINGS
- AS 1684-2010 NATIONAL TIMBER FRAMING CODE AS 1720-2010 TIMBER STRUCTURES
- AS 1926-2012 SWIMMING POOL SAFETY
- AS 2047-1999 WINDOWS IN BUILDINGS-SELECTION & INSTALLATION
- AS 2049-2002 ROOF TILES
- AS 2050-2002 INSTALLATION OF ROOFING TILES
- AS 2159-2009 PILING DESIGN AND INSTALLATION
- AS 2327-2003 COMPOSITE STRUCTURES
- AS 2870-2011 RESIDENTIAL SLABS & FOOTINGS CONSTRUCTION
- AS 3600-2009 CONCRETE STRUCTURES
- AS 3660-2000 PROTECTION OF BUILDINGS AGAINST SUBTERRANEAN TERMITES AS 3700-2011 MASONRY STRUCTURES
- AS 3740-2010 WATERPROOFING OF WET AREAS IN RESIDENTIAL BUILDINGS
- AS 3786-1993 SMOKE ALARMS
- AS 3959-2009 CONSTRUCTION OF BUILDINGS IN BUSHFIRE-PRONE AREAS
- AS 4055-2006 WIND LOADS FOR HOUSING
- AS 4072-2005 OPENINGS IN FIRE-RESISTANT SEPARATING ELEMENTS
- AS 4100-1998 STEEL STRUCTURES
- AS 4254-1995 DUCTWORK FOR AIR-HANDLING SYSTEMS IN BUILDINGS
- AS 4552-2005 GAS FIRED WATER HEATERS AND/OR CENTRAL HEATING
- AS 4773-2010 MASONRY FOR SMALL BUILDINGS
- ISO 8336 1993E FIBRE CEMENT FLAT SHEETS
- AS/NZS 1170-2011 STRUCTURAL DESIGN ACTIONS
- AS/NZS 1276-1999 ACOUSTICS RATING OF SOUND INSTALLATION IN BUILDINGS
- AS/NZS 1428-2009 DESIGN FOR ACCESS AND MOBILITY
- AS/NZS 1530-2005METHODS FOR FIRE TESTS ON BUILDING MATERIALS
- AS/NZS 1562-2009 INSTALLATION OF METAL SHEET ROOF & WALL CLADDING
- AS/NZS 1664-1997 ALUMINIUM STRUCTURES
- AS/NZS 1748-1997 TIMBER-STRESS GRADED
- AS/NZS 2032-2006 INSTALLATION OF PVC PIPE SYSTEMS
- AS/NZS 2033-2008INSTALLATION OF PE PIPE SYSTEMS
- AS/NZS 2179-1994 SPECIFICATION FOR RAINWATER GOODS
- AS/NZS 2269-2008 PLYWOOD-STRUCTURAL
- AS/NZS 2566-2002 BURIED FLEXIBLE PIPELINES
- AS/NZS 2904-1995 DAMP-PROOF COURSES & FLASHINGS AS/NZS 2908-2000 CELLULOSE CEMENT PRODUCTS
- AS/NZS 3500-2013 PLUMBING AND DRAINAGE
- AS/NZS 3725-2007 DESIGN FOR INSTALLATION OF BURIED CONCRETE PILES
- AS/NZS 4058-2007 PRE CAST CONCRETE PIPES
- AS/NZS 4200-1994 PLIABLE BUILDING MEMBRANES & UNDERLAYS
- AS/NZS 4234-2008HEATED WATER SYSTEMS ENERGY CONSUMPTION
- AS/NZS 4256-2006 PLASTIC ROOF & WALL CLADDING MATERIAL
- AS/NZS 4600-2005 COLD-FORMED STEEL STRUCTURES
- AS/NZS 4671-2001 STEEL REINFORCING MATERIALS
- AS/NZS 4680-2006HOT-DIP GALVANISED (ZINC) COATING
- AS/NZS 4859-2002MATERIALS FOR THERMAL INSULATION OF BUILDINGS
- PROVIDE WALL TIES TO BRICKWORK @ MAX. 600mm CTRS IN EACH DIRECTION & WITHIN 300mm OF ARTICULATION JOINTS.

- AUSTRALIAN STAIR REQUIREMENTS:- (OTHER THAN SPIRAL STAIRS)
- RISERS 190mm MAX, 115mm MIN.
- · TREADS 355mm MAX, 240mm MIN. PRIVATE STAIRS & 250mm PUBLIC STAIRS
- · RISERS & TREADS TO BE CONSTANT IN SIZE THROUGHOUT FLIGHT.
- PROVIDE NON-SLIP FINISH OR SUITABLE NON-SKID STRIP NEAR EDGE OF NOSINGS.
- ENSURE MAX. GAP BETWEEN RISERS NOT TO EXCEED 125mm OR USE CLOSED RISERS
- PROVIDE CONTINUOUS HANDRAIL 1000MM MIN. HEIGHT TO BALCONIES & DECKS WHICH ARE 1000mm OR MORE ABOVE **GROUND LEVEL**
- 865mm MIN. HEIGHT HANDRAIL ABOVE STAIR NOSING & LANDINGS
- · MAX. OPENINGS BETWEEN BALUSTERS NOT TO EXCEED 125mm.
- · A SINGLE FLIGHT OF STAIRS SHALL NOT HAVE MORE THAN 18, OR LESS THAN 2 RISERS.

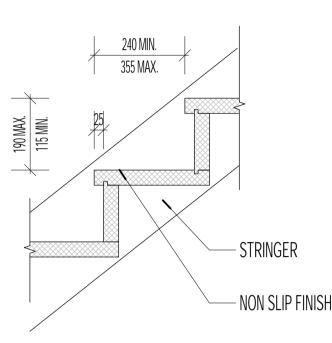

J BALUSTRADES & HANDRAILS

- \cdot Stair Handrails to be in accordance with the requirements of NCC 2019 vol.2 clause 3.9.1.
- PROVIDE BALUSTRADES WHERE CHANGE IN LEVEL EXCEEDS 1000mm ABOVE THE SURFACE BENEATH LANDINGS, RAMPS
- AND/OR TREADS. BALUSTRADES (OTHER THAN TENSIONED WIRE BALUSTRADES) TO BE:
- 1000mm MIN. ABOVE FINISHED SURFACE LEVEL OF BALCONIES, LANDINGS OR THE LIKE, AND
- 865mm MIN. ABOVE FINISHED SURFACE LEVEL OF STAIR NOSING OR RAMP, AND
- VERTICAL WITH LESS THAN 125mm GAP BETWEEN, AND
- ANY HORIZONTAL ELEMENT WITHIN THE BALUSTRADE BETWEEN 150mm AND 760mm ABOVE THE FLOOR MUST NOT FACILITATE CLIMBING WHERE CHANGES IN LEVEL EXCEEDS 4000mm ABOVE THE SURFACE BENEATH LANDINGS, RAMPS AND/OR TREADS.

- REFER TO GLAZING SCHEDULE ON DRAWINGS AND ENERGY REPORT.
- ALL GLAZING TO COMPLY WITH AS 1288-2006 AND AS2047.
- 3mm ORDINARY GLASS & 5mm TOUGHENED GLASS WITHIN 500mm OF FLOOR. ALL HEAD HEIGHTS ARE AT 2100mm ABOVE FLOOR LEVEL UNLESS OTHERWISE NOTED. ALL SIZES ARE INDICATIVE, EXACT SIZES TO BE SPECIFIED BY WINDOW MANUFACTURER. PROVIDE 'A' GRADE SAFETY GLASS WHERE REQUIRED AS ACCORDING TO NCC 2019 VOL.2 CLAUSE 3.6.4.5 AND TABLE 3.6.5.
- · ALL MEASUREMENTS SHOWN ARE HARD SURFACE STRUCTURE TOLERANCE AND TO COMPLY WITH MANUFACTURERS ALLWANCES. SITE CHECK. SHOWER SCREENS & GLAZING WITHIN 1500mm VERTICALLY OR 500mm HORIZONTAL FROM BASE OF BATH / SHOWER SHALL BE TOUGHENED GLASS.
- · ALL LINTELS TO ENGINEERS DETAILS REFER TO ELEVATIONS FOR SASH LOCATIONS ALL STEEL ANGLE LINTELS TO BE 'HOT DIPPED GALVANIZED'
- ALL OPENING SASHES TO BE PROVIDED WITH WINDOW LOCKS, INCLUDING SLIDING DOORS.
- ALL DOORS & WINDOW SASHES TO WHOLE JOB TO HAVE SEALS ALL ROUND.
- ALL GLAZING IN BATHROOMS, ENSUITES OR THE LIKE, INCLUDING SHOWER DOORS, SHOWER SCREENS, BATH ENCLOSURES, AND ASSOCIATED WINDOWS, WHERE THE LOWEST SIGHT LINE IS LESS THAN 2.0m ABOVE THE HIGHEST ABUTTING FIHISHES LEVEL OF THE FLOOR, BOTTOM OF BATH, OR SHOWER BASE MUST BE PROVIDED WITH GRADE A SAFETY GLAZING IN ACCORDANCE WITH NCC 2019 VOL.2 CLAUSE 3.6.4.5 AND TABLE 3.6.5

THERMAL INSULATION

- \cdot SHALL BE INSTALLED STRICTLY IN ACCORDANCE WITH "CLIENT ENGAGED ENERGY CONSULTANT"
- · PROPOSED BUILDINGS MUST ACHIEVE MINIMUM 6 STAR RATING OR BETTER
- · ALL OPENING WINDOW SASHES ARE FITTED WITH DRAUGHT PROOF SEALS
- · ALL EXHAUST FANS TO BE SELF CLOSING AT OUTLET DUCT
- · GAPS BETWEEN WINDOW AND DOOR FRAMES AND THE BUILDING FABRIC TO BE DRAUGHT PROOF SEALED
- · ALL EXTERNAL DOORS AND WINDOWS ARE TO BE WEATHER SEALED
- · ALL SISALATION TO BE TAPED, SEALED AND TEARS PATCHED
- · ALL PENETRATION, GAPS, CONDECK RIDGES, SERVICE PIPES AND THE LIKE BETWEEN TOWNHOUSES AND PASSAGES TO TOWNHOUSES TO BE ACOUSTICALLY CAULKED AND SEALED
- · THE BUILDER SHALL PROVIDE ACOUSTIC. THERMAL AND FIRE RATING COMPLIANCE CERTIFICATES AT PRACTICAL COMPLETION

M SMOKE DETECTORS:

SD.- DENOTES HARDWIRED AND INTERCONNECTED SMOKE ALARMS COMPLYING WITH AS 3786-2014, CEILING MOUNTED WHERE INDICATED ON DESIGNER'S DRAWINGS.

N BATHROOM/ENSUITE/POWDER ROOM HINGE DOORS:

ALL DOORS SERVING TOILETS ARE TO BE PROVIDED WITH LIFT OFF HINGES WHERE THE DOOR SWING (MEASURED FROM HINGE) IS WITHIN 1.2m OF THE PAN OF THE TOILET. DOOR TO BE ADJUSTED ACCORDINGLY.

• WET AREAS / BATHROOM & ENSUITE FLOORS:

· WET AREAS TO BE WATERPROOFED IN ACCORDANCE WITH AS3740.

 \cdot WET AREA WALL & FLOOR FINISHES TO COMPLY WITH 'WET AREAS' PART 3.8.1, VOL.2 OF THE BCA.

· CERAMIC OR STONE TILES OVER 15mm THICK 'HARDIES' COMPRESSED FIBRE CEMENT SHEET SUBSTRATE LINING TO FIRST FLOOR.

WALLS AND HOBS: SELECTED CERAMIC OR STONE TILES OVER 10mm THICK W.R. GRADE 'BORAL' OR 'GYPROCK' PLASTERBOARD SHEET SUBSTRATE LINING. SHOWER AND BATH RECESS.

P VENTILATION NOTES:

VENTILATION SHALL BE PROVIDED BY OPENABLE WINDOWS TO ALL ROOMS. OPENABLE AREA TO BE EQUIVALENT TO 5% OF THE FLOOR AREA OR GREATER. AS REQUIRED BY THE BUILDING CODE OF AUSTRALIA.

· PROVIDE MECHANICAL VENTILATION TO BATHROOMS AT A RATE OF 10m/HOUR WHERE NO NATURAL VENTILATION CAN BE PROVIDED DISCHARGING TO THE OPEN AIR CONNECTED TO THE LIGHT SWITCH AS PER BUILDING CODE OF AUSTRALIA AND AUSTRALIAN STANDARD REQUIREMENTS.

· BATHROOM, POWDER ROOM & ENSUITE MECHANICAL VENTILATION OF A MINIMUM 25L/S DUCTED OUTSIDE AIR IN ACCORDANCE WITH AS1668/1991. OR BE VENTILATED DIRECTLY OUTSIDE.

· KITCHEN OR LAUNDRY MECHANICAL VENTILATION OF A MINIMUM 40L/S DUCTED OUTSIDE AIR IN ACCORDANCE WITH · EXHAUST FROM A BATHROOM, SANITARY COMPARTMENT, OR LAUNDRY MUST BE DISCHARGED DIRECTLY OR VIA SHAFT

OR DUCT TO OUTDOOR AIR: OR TO A ROOF SPACED THAT IS VENTILATED IN ACCORDANCE WITH 3.8.7.4.

Q HUMAN IMPACT SAFETY REQUIREMENTS TO COMPLY WITH NCC 2019 VOL.2 CLAUSE 3.6.4.

· DOORS IN ACCORDANCE WITH 3.6.4.1.

• DOOR SIDE PANELS IN ACCORDANCE WITH 3.6.4.2.

• FULL HEIGHT GLASS PANELS IN ACCORDANCE WITH 3.6.4.3. GLAZED PANELS, OTHER THAN DOORS OR SIDE PANELS, ON THE PERIMETER OF ROOMS IN ACCORDANCE WITH 3.6.4.4.

 BATHROOMS, ENSUITE AND SPA ROOM GLAZING IN ACCORDANCE WITH 3.6.4.5. VISIBILITY OF GLAZING IN ACCORDANCE WITH 3.6.4.6.

R CLADDING SYSTEMS:

ALL CLADDING SYSTEMS PROPOSED MUST BE AN ACCREDITED SYSTEM AS APPROVED ON THE FOLLOWING WEBSITES: http://www.abcb.gov.au/en/product-certification/codemark/list-of-codemark

-certified-products.aspx

http://www.vba.vic.gov.au/__data/assets/pdf_file/0013/25150/Lisitng-of -accredited-products.pdf


BUILDING SHALL BE PROTECTED IN ACCORDANCE WITH AS3660-2000.

Articulation Joint

TERMITE PROTECTION

THE MUNICIPALITY OF BAYSIDE IS NOT LOCATED IN A TERMITE ZONE • TERMITE RISK MANAGEMENT TO COMPLY WITH PART 3.1.3, VOL.2 OF THE NCC BCA. WHERE AUSTRALIAN BUILDING (OTHER THAN A CLASS 10A) IS LOCATED IN A DESIGNATED TERMITE INFESTATION AREA THE

GENERAL LEGEND		SYMBOL LEGEND		
TW1 DP	Wall type Downpipe	W25	Window number	
RHW Fw	Rainwater head Floor waste	D.04	Door number	
0 F	Openable window Fixed window	FALL ———	Direction of fall in slab or roof	
Col	Column	timber direction	Direction of timber flooring/decking	

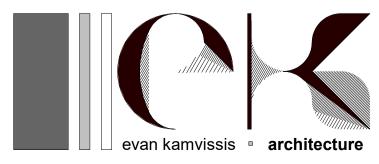


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COPYRIGHT AND SHALL NOT BE COPIED OR AMENDED. IN WHOLE OR IN PART, WITHOUT THE WRITTEN CONSENT OF EVAN KAMVISSIS ARCHITECTURE.

DETAILS 11/06/2021 | ISSUE FOR BUILDING PERMIT

SHEET NAME PROJECT GENERAL NOTES PROPOSED RESIDENTIAL DEVELOPMENT AT 11 STOREY AVENUE, HAMPTON **CLIENT NAME**: CORINNA & BOB NEILL

JULY 2020 SCALE: 1:50 AT A1 / 1:100 AT A3 DWG No.: 2013 SHEET No.: A001 REVISION:

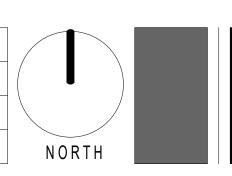

EXCAVATION, SITEWORK & DRAINAGE

- GRUB OUT ORGANIC MATTER AND SURFACE VEGETATION WITHIN BUILDING AREA.
- STORMWATER DRAINAGE TO COMPLY WITH AS 3500.3: PLUMBING AND DRAINAGE PART 3.
 STORMWATER DRAINAGE.
- STORMWATER TO DISCHARGE TO EXISTING STROMWATER DRAINAGE SYSTEM. THE
 APPOINTED LICENSED PLUMBER IS TO SITE CHECK & LOCATE ALL SERVICES ON SITE PRIOR
 TO PROCEEDING WITH THE WORKS.
- INSTALL MIN. ____DIA UPVC STROMWATER DRAIN AND SEWR TO MIN. 1 IN 100 FALL. SEWER TO BE SEWER GRADE UPVC & CONNECTED TO EXISTING SEWER SYSTEM TO THE RELEVANT AUTHORITIES APPROVAL.
- ALLOW FOR INSPECTION OPENINGS AT ALL BENDS AND/OR AT MAX. 9000mm LENGTHS.
- ALL SURFACE DRAINAGE WORKS SHALL BE INSTALLED IN ACCORDANCE WITH THE ENGINEERS DESIGN DETAIL FOR THE SELECTED FOOTING SYSTEM AND SOIL CLASSIFICATION AND IN ACCORDANCE WITH CLAUSE 5.6.3, DRAINAGE REQUIREMENTS OF AS2870-2011. WHEREIN FOR BUILDINGS ON MODERATELY, HIGHLY AND REACTIVE SITES SURFACE DRAINAGE SHALL BE CONTROLLED THROUGHOUT CONSTRUCTION AND BE COMPLETED BY THE FINISH OF CONSTRUCTION. THE BASE TRENCHES SHALL SLOPE AWAY FROM THE BUILDING. WHERE PIPES PASS UNDER THE FOOTING SYSTEMS CLAY PLUGS MUST BE ADOPTED TO PREVENT THE INGRESS OF WATER.
- FOR BUILDINGS ON HIGHLY REACTIVE SITES, THE PLUMBER / DRAINER SHALL PROVIDE
 ARTICULATION TO ALL STORMWATER, SANITARY PLUMBING DRAINS AND DISCHARGE PIPES IN
 ACCORDANCE WITH CLAUSE 5.6.4. PLUMBING REQUIREMENTS, WHEREIN FLEXIBLE JOINTS
 IMMEDIATELY OUTSIDE THE FLOORING AND COMMENCING WITHIN 1.0m AT THE BUILDING
 PERIMETER ARE REQUIRED TO ACCOMMODATE THE REQUIRED DIFFERENTIAL MOVEMENT
 BASED ON THE SOIL CLASSIFICATION.
- NEW STORMWATER DRAINS TO BE CONNECTED TO EXISTING STORMWATER DRAINS AND DISCHARGED TO THE LEGAL POINT OF DISCHARGE TO THE RELEVANT AUTHORITIES REQUIREMENTS.
- ALL WASTE FIXTURES TO BE CONNECTED TO SEWERAGE SYSTEM IN ACCORDANCE WITH THE RELEVANT WATER AUTHORITY.
- SURFACE WATER MUST BE DIVERTED AWAY FROM THE BUILDING AND GRADED AWAY FROM ALL FOUNDATIONS TO GIVE A SLOPE OF NOT LESS THAN 50mm OVER THE FIRST 1000mm FROM THE DWELLING.
- SUBSURFACE DRAINS TO REMOVE GROUND OR TABLE WATER SHALL BE DETAILED BY THE
 DESIGN ENGINEER. FURTHERMORE, DAMP-PROOFING MEMBRANE IN ACCORDANCE WITH CLAUSE
 5.3.3 SHALL BE INSTALLED FOR GROUND WATER OR AGGRESSIVE SOILS.
- EXISTING DRAINAGE PIT IS TO BE MODIFIED / RECONSTRUCTED TO THE SATISFACTION OF THE
- RESPONSIBLE AUTHORITY.

 STORM WATER DRAINAGE TO BE CONNCECTED TO THE LEGAL POINT OF DISCHARGE AS PER

THE REQUIREMENTS OF THE GOVERNING BODIES.

- IT IS THE RESPONSIBILITY OF THE PLUMBER TO ENSURE PROPOSED PIPES DON'T ENCROACH THE
- TITLE BOUNDARIES.


 WHERE SITE CUT IS NECESSARY TO ACHIEVE APPROPRIATE F.G.L & F.F.L AGGI DRAINS SHALL BE
- CONNECTED TO THE STORM WATER DRAIN VIA SILT PITS.

 PROPOSED SERVICE PIPES TO BE SUSPENDED UNDER FLOOR & TO BE CONNECTED TO
- EASEMENT.


 IT IS THE RESPONSIBILITY OF THE QUALIFIED PLUMBER/CONTRACTOR TO SITE CHECK


STORM WATER DRAIN. PLUMBER TO ENSURE NEW SERVICES DO NOT ENCROACH


IT IS THE RESPONSIBILITY OF THE QUALIFIED PLUMBER/CONTRACTOR TO SITE CHECK EXISTING LOCATIONS OF DRAIL/SEWER TO ENSURE THAT WORKS ARE CONDUCTED IN ACCORDANCE TO THE ANGLE OF REPOSE AND GUIDELINES SET OUT BY THE LOCAL AUTHORITIES.

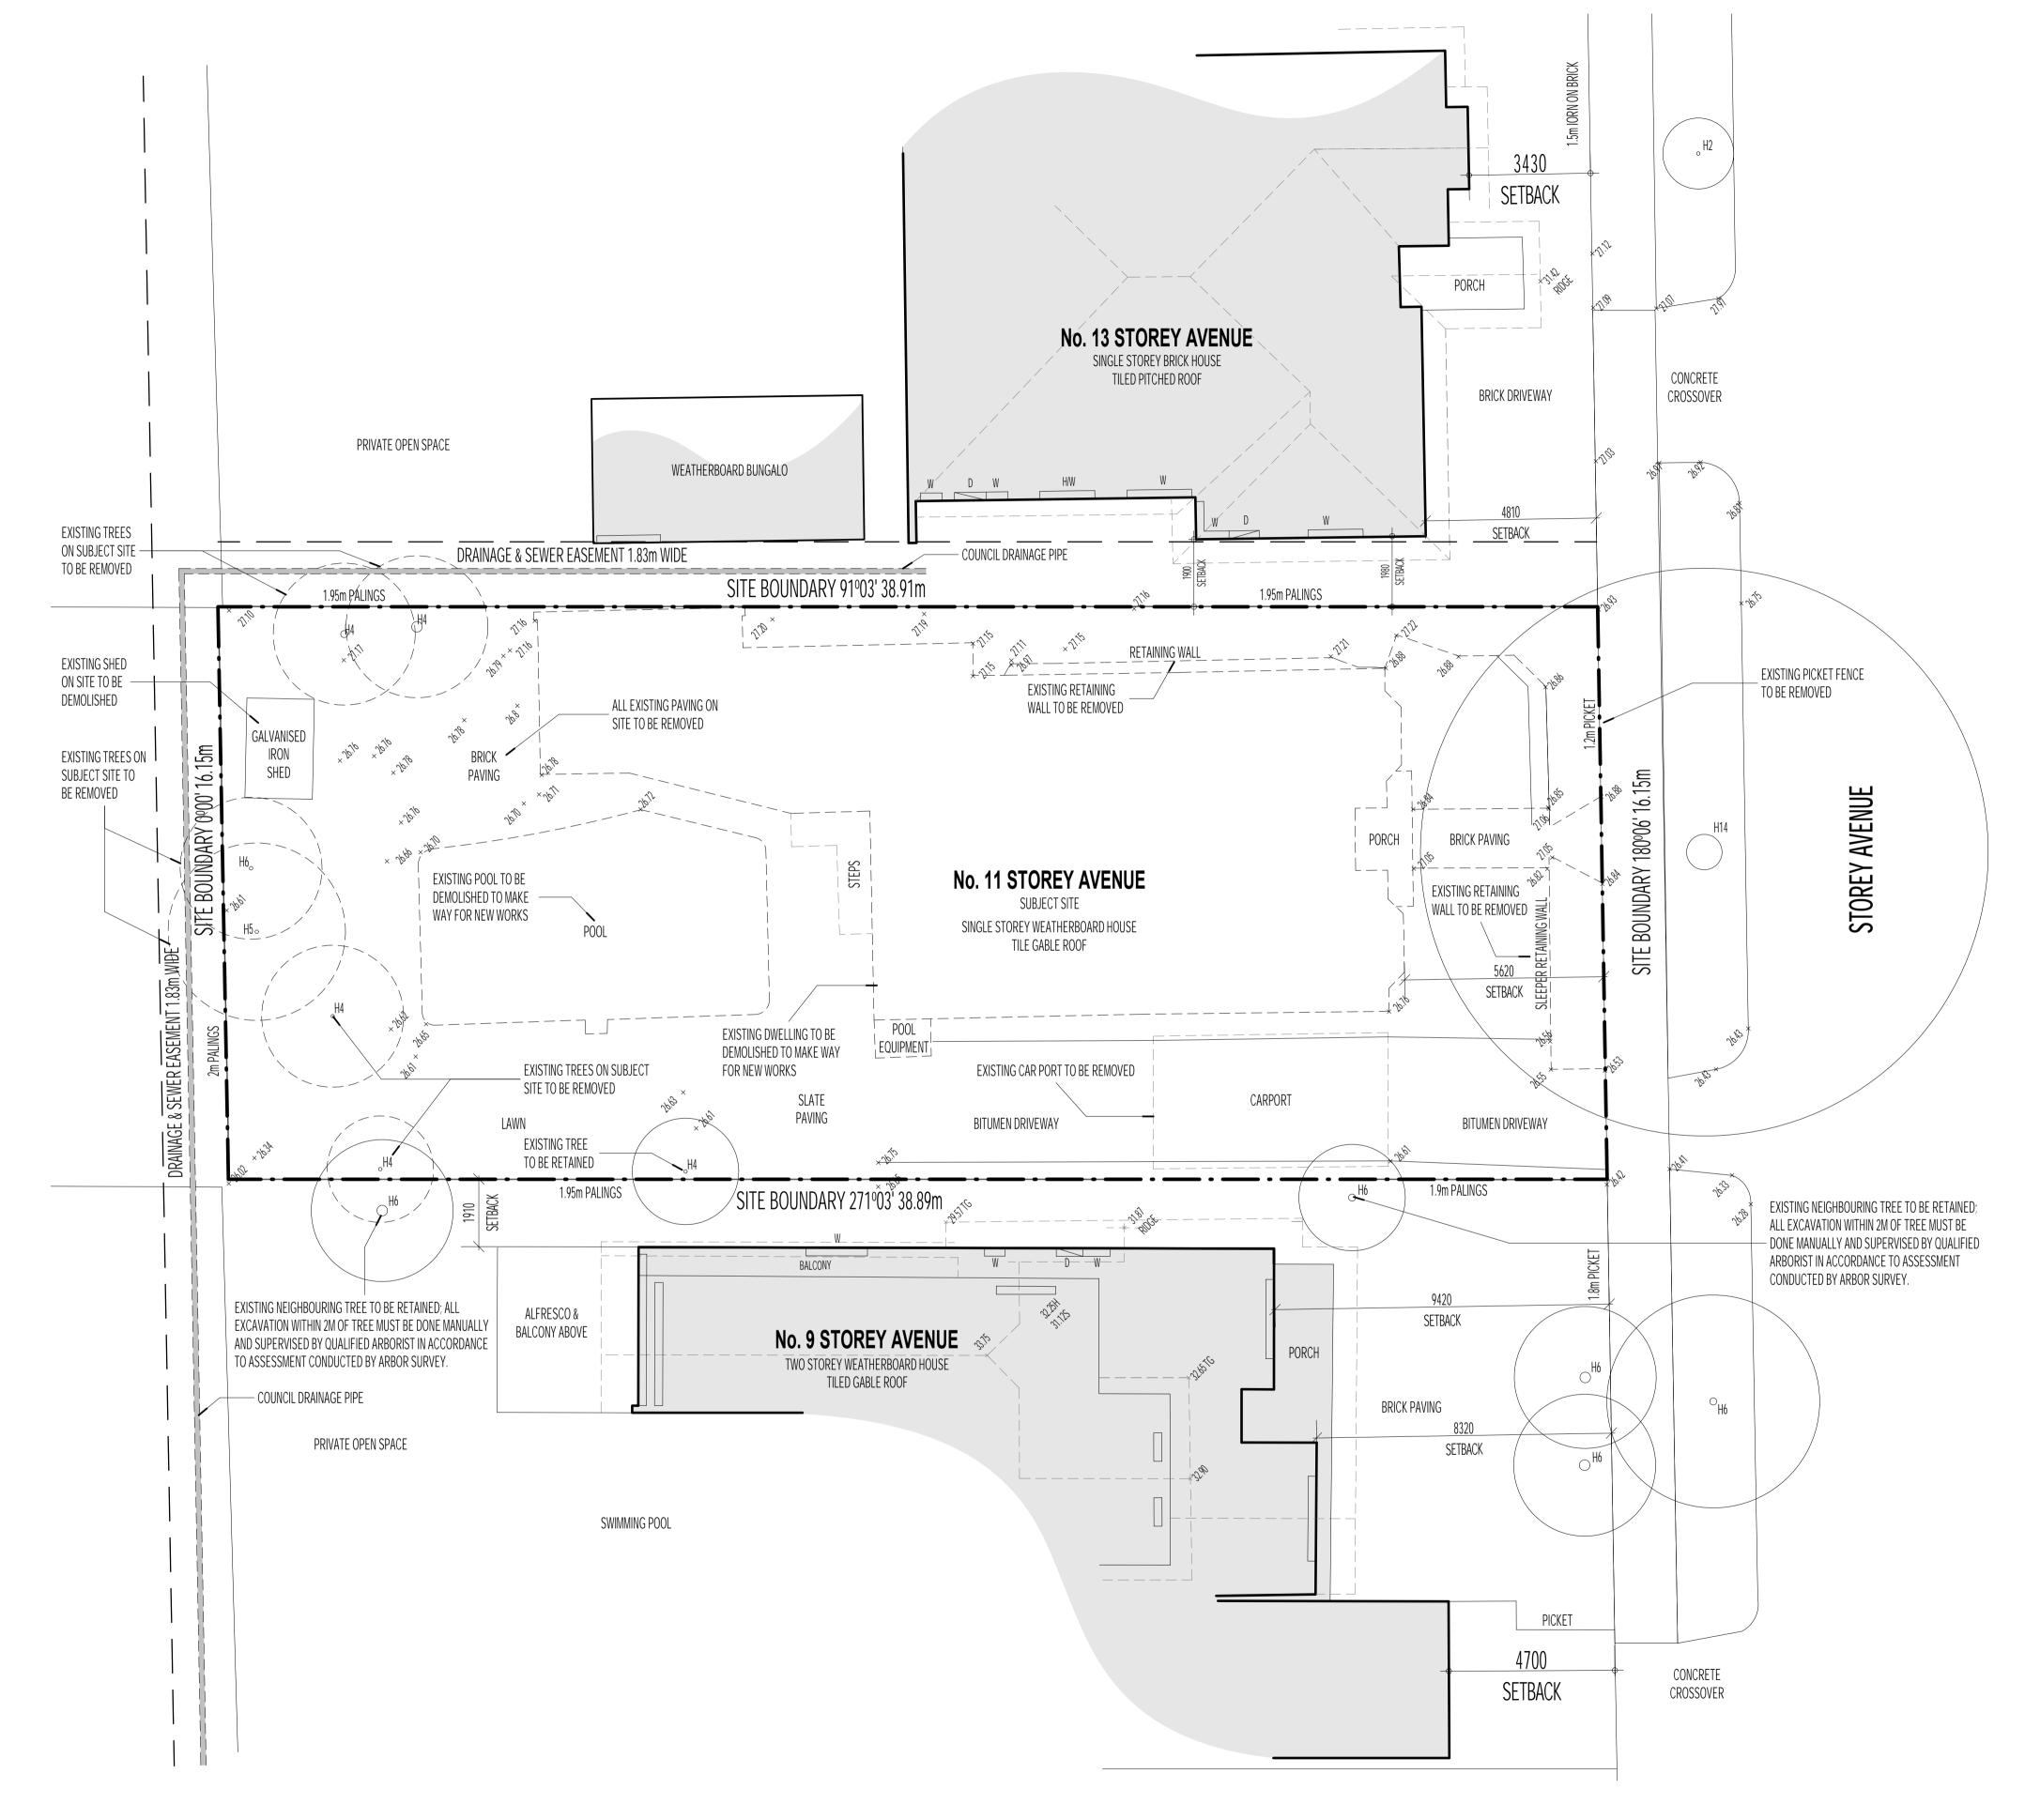



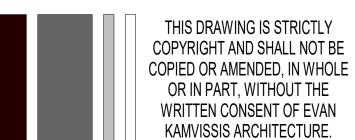


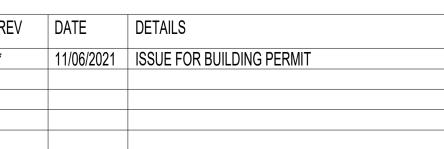

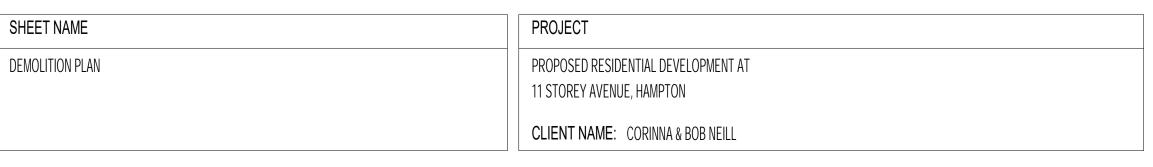



SHEET No.: A100 REVISION:

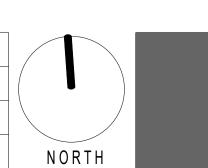

THE BUILDER SHALL TAKE ALL THE STEPS NECESSARY TO ENSURE THE STABILITY AND GENERAL WATER TIGHTNESS OF NEW AND/OR EXISTING STRUCTURES DURING ALL WORKS

THE OWNER/BUILDER, SUBCONTRACTOR SHALL VERIFY ALL DIMENSIONS, LEVELS, SETBACKS, SPECIFICATIONS AND ALL OTHER RELEVANT DOCUMENTATION PRIOR TO COMMENCING ANY WORKS OR ORDERING MATERIALS AND SHALL BE RESPONSIBLE FOR ENSURING THAT ALL BUILDING WORKS CONFORM TO THE BUILDING CODE OF AUSTRALIA, AUSTRALIAN STANDARDS, BUILDING REGULATIONS, LOCAL BY-LAWS & TOWN PLANNING REGULATIONS.

THESE DRAWINGS SHALL BE READ IN CONJUNCTION WITH ALL RELEVANT STRUCTURAL

AND ALL OTHER CONSULTANTS DRAWINGS/DETAILS AND WITH ANY OTHER WRITTEN

INSTALLATION OF ALL SERVICES SHALL COMPLY WITH THE RESPECTIVE SUPPLY AURTHORITIES REQUIREMENTS.

ARCHITECTURAL GENERAL NOTES

INSTRUCTIONS ISSUED IN THE COURSE OF THE CONTRACT.

THE APPROVAL BY THIS OFFICE OF A SUBSTITUTE MATERIAL, WORK PRACTICE, VARIATION OR THE LIKE IS NOT AUTHORIZATION FOR THE USE OR A CONTRACT VARIATION. ANY SAID VARIATIONS MUST BE ACCEPTED BY ALL PARTIES TO THE AGREEMENT AND WHERE APPLICABLE THE RELEVANT BUILDING SURVEYOR PRIOR TO IMPLEMENTING THE SAID VARIATION.

DO NOT SCALE DRAWINGS - USE WRITTEN DIMENSIONS ONLY.

REPORT ALL DISCREPANCIES TO THIS OFFICE FOR CLARIFICATION AND APPROVAL IN WRITING.

THESE NOTES ARE NEITHER EXHAUSTIVE NOR A SUBSTITUTE FOR REGULATIONS, STATUTORY REQUIREMENTS, BUILDING PRACTICE OR CONTRACTUAL OBLIGATIONS AND UNLESS EXPRESSLY STATED OTHERWISE, ARE PROVIDED ONLY AS GUIDELINES NO RESPONSIBILITY IS ACCEPTED FOR THEIR USE.

TE:

- ALL EXPOSED STEEL WORK TO BE 316 MARINE GRADE STAINLESS STEEL UNLESS APPROVED OTHERWISE BY CLIENT.
- ALL WATERPROOFING SYSTEMS TO COMPLY WITH AS 3420 / AS 1562 / AS 2904 / SAA HB39
- EXPANSION JOINTS AT APPROPRIATE / REQUIRED LOCATION IN ACCORDANCE WITH AS3600 / 2009 IN LINE WITH WALL AND WINDOW JOINTS WHERE POSSIBLE.

EXCAVATION, SITEWORK & DRAINAGE

- GRUB OUT ORGANIC MATTER AND SURFACE VEGETATION WITHIN BUILDING AREA.
- STORMWATER DRAINAGE TO COMPLY WITH AS 3500.3: PLUMBING AND DRAINAGE PART 3. STORMWATER DRAINAGE.
- STORMWATER TO DISCHARGE TO EXISTING STROMWATER DRAINAGE SYSTEM. THE APPOINTED LICENSED PLUMBER IS TO SITE CHECK & LOCATE ALL SERVICES ON SITE PRIOR TO PROCEEDING WITH THE WORKS.
- INSTALL MIN. ____DIA UPVC STROMWATER DRAIN AND SEWR TO MIN. 1 IN 100 FALL. SEWER TO BE SEWER GRADE UPVC & CONNECTED TO EXISTING SEWER SYSTEM TO THE RELEVANT
- ALLOW FOR INSPECTION OPENINGS AT ALL BENDS AND/OR AT MAX. 9000mm LENGTHS.

ALL SURFACE DRAINAGE WORKS SHALL BE INSTALLED IN ACCORDANCE WITH THE ENGINEERS DESIGN DETAIL FOR THE SELECTED FOOTING SYSTEM AND SOIL CLASSIFICATION AND IN ACCORDANCE WITH CLAUSE 5.6.3, DRAINAGE REQUIREMENTS OF AS2870-2011. WHEREIN FOR BUILDINGS ON MODERATELY, HIGHLY AND REACTIVE SITES - SURFACE DRAINAGE SHALL BE CONTROLLED THROUGHOUT CONSTRUCTION AND BE COMPLETED BY THE FINISH OF CONSTRUCTION. THE BASE TRENCHES SHALL SLOPE AWAY FROM THE BUILDING. WHERE PIPES PASS UNDER THE FOOTING SYSTEMS CLAY PLUGS MUST BE ADOPTED TO PREVENT THE INGRESS OF WATER.

• FOR BUILDINGS ON HIGHLY REACTIVE SITES, THE PLUMBER / DRAINER SHALL PROVIDE ARTICULATION TO ALL STORMWATER, SANITARY PLUMBING DRAINS AND DISCHARGE PIPES IN ACCORDANCE WITH CLAUSE 5.6.4. PLUMBING REQUIREMENTS, WHEREIN FLEXIBLE JOINTS IMMEDIATELY OUTSIDE THE FLOORING AND COMMENCING WITHIN 1.0m AT THE BUILDING PERIMETER ARE REQUIRED TO ACCOMMODATE THE REQUIRED DIFFERENTIAL MOVEMENT BASED ON THE SOIL CLASSIFICATION.

- NEW STORMWATER DRAINS TO BE CONNECTED TO EXISTING STORMWATER DRAINS AND DISCHARGED TO THE LEGAL POINT OF DISCHARGE TO THE RELEVANT AUTHORITIES REQUIREMENTS.
- ALL WASTE FIXTURES TO BE CONNECTED TO SEWERAGE SYSTEM IN ACCORDANCE WITH THE RELEVANT WATER AUTHORITY.


SURFACE WATER MUST BE DIVERTED AWAY FROM THE BUILDING AND GRADED AWAY FROM ALL FOUNDATIONS TO GIVE A SLOPE OF NOT LESS THAN 50mm OVER THE FIRST 1000mm FROM THE DWELLING.

SUBSURFACE DRAINS TO REMOVE GROUND OR TABLE WATER SHALL BE DETAILED BY THE DESIGN ENGINEER. FURTHERMORE, DAMP-PROOFING MEMBRANE IN ACCORDANCE WITH CLAUSE 5.3.3 SHALL BE INSTALLED FOR GROUND WATER OR AGGRESSIVE SOILS.

- EXISTING DRAINAGE PIT IS TO BE MODIFIED / RECONSTRUCTED TO THE SATISFACTION OF THE RESPONSIBLE AUTHORITY.
- STORM WATER DRAINAGE TO BE CONNCECTED TO THE LEGAL POINT OF DISCHARGE AS PER THE REQUIREMENTS OF THE GOVERNING BODIES.
- IT IS THE RESPONSIBILITY OF THE PLUMBER TO ENSURE PROPOSED PIPES DON'T ENCROACH THE
- TITLE BOUNDARIES. WHERE SITE CUT IS NECESSARY TO ACHIEVE APPROPRIATE F.G.L & F.F.L AGGI DRAINS SHALL BE
- PROPOSED SERVICE PIPES TO BE SUSPENDED UNDER FLOOR & TO BE CONNECTED TO STORM WATER DRAIN. PLUMBER TO ENSURE NEW SERVICES DO NOT ENCROACH

CONNECTED TO THE STORM WATER DRAIN VIA SILT PITS.

IT IS THE RESPONSIBILITY OF THE QUALIFIED PLUMBER/CONTRACTOR TO SITE CHECK EXISTING LOCATIONS OF DRAIL/SEWER TO ENSURE THAT WORKS ARE CONDUCTED IN ACCORDANCE TO THE ANGLE OF REPOSE AND GUIDELINES SET OUT BY THE LOCAL AUTHORITIES.

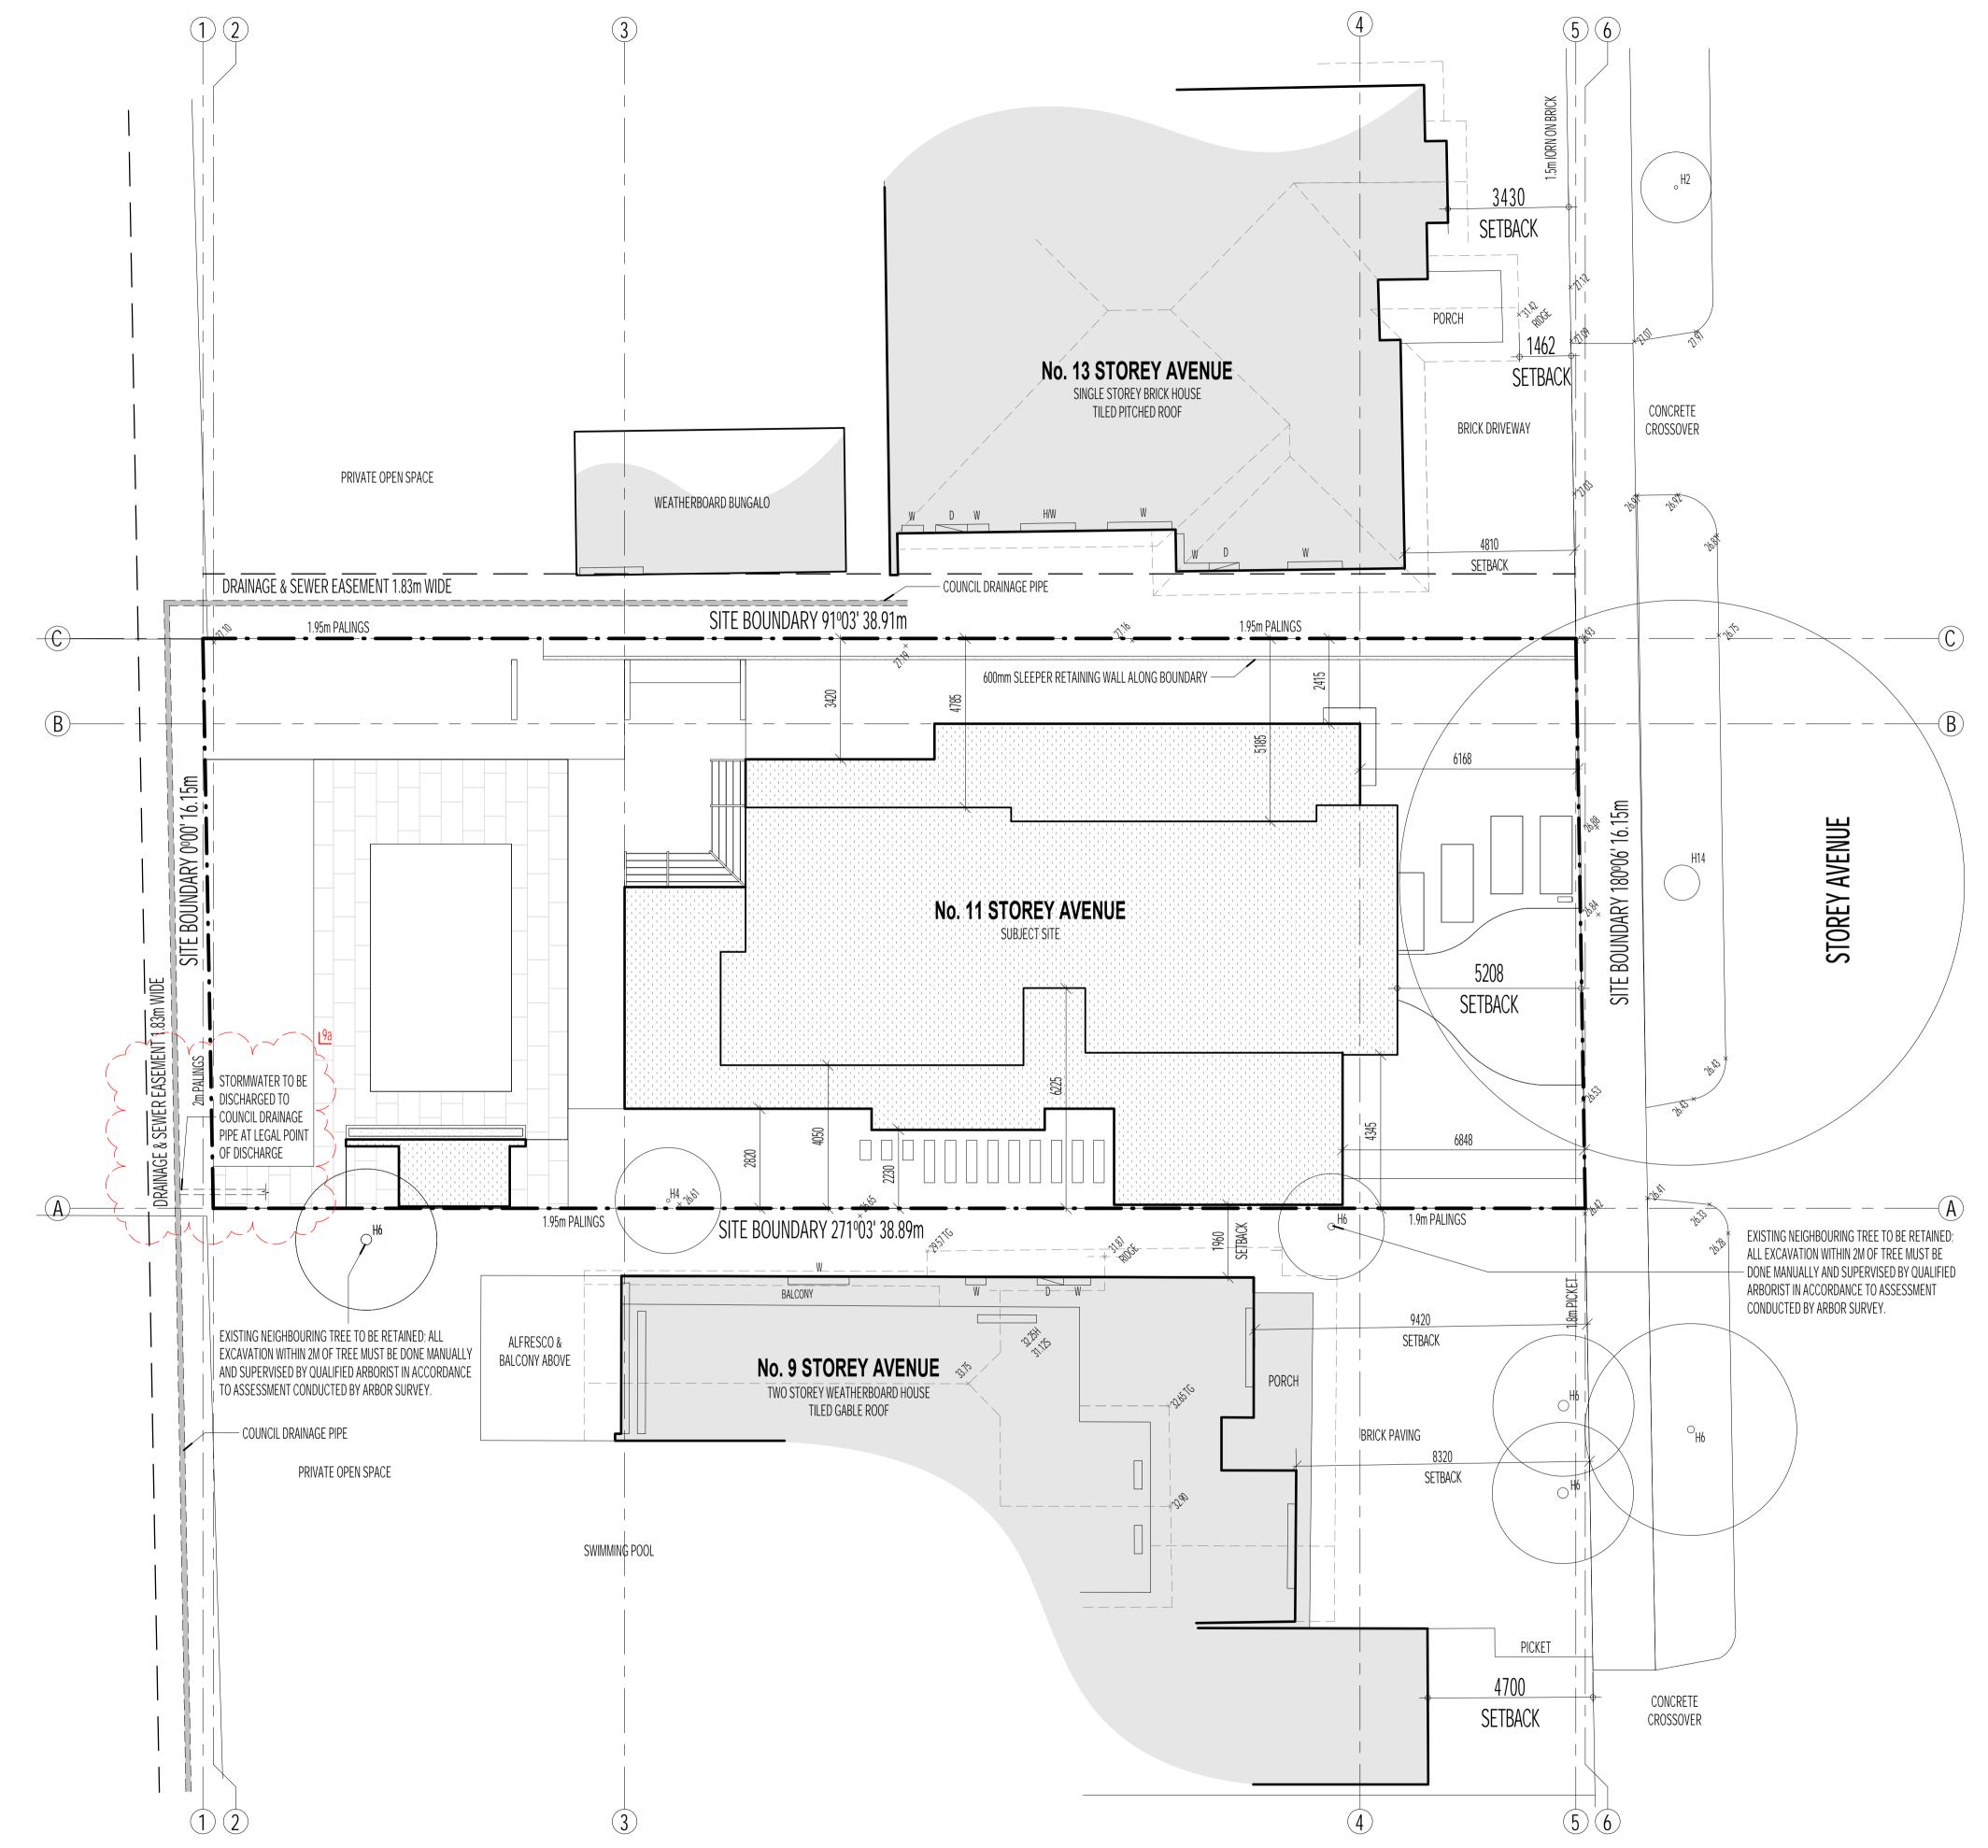

ARCHITECTURAL GENERAL NOTES

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THE BUILDER SHALL TAKE ALL THE STEPS NECESSARY TO ENSURE THE STABILITY AND GENERAL WATER TIGHTNESS OF NEW AND/OR EXISTING STRUCTURES DURING ALL

THE OWNER/BUILDER, SUBCONTRACTOR SHALL VERIFY ALL DIMENSIONS, LEVELS, SETBACKS, SPECIFICATIONS AND ALL OTHER RELEVANT DOCUMENTATION PRIOR TO COMMENCING ANY WORKS OR ORDERING MATERIALS AND SHALL BE RESPONSIBLE FOR ENSURING THAT ALL BUILDING WORKS CONFORM TO THE BUILDING CODE OF AUSTRALIA, AUSTRALIAN STANDARDS, BUILDING REGULATIONS, LOCAL BY-LAWS & TOWN PLANNING REQUIREMENTS.

INSTALLATION OF ALL SERVICES SHALL COMPLY WITH THE RESPECTIVE SUPPLY AURTHORITIES REQUIREMENTS.

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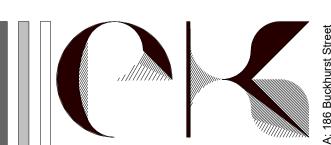
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NOTE:


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- ALL WATERPROOFING SYSTEMS TO COMPLY WITH AS 3420 / AS 1562 / AS 2904 / SAA HB39
- EXPANSION JOINTS AT APPROPRIATE / REQUIRED LOCATION IN ACCORDANCE WITH AS3600 / 2009 IN LINE WITH WALL AND WINDOW JOINTS WHERE


ELOOD ADEAC

TOTAL - 11 STOREY AVENUE, HAMPTON.	SIZE	SIZE	PERCENT
	(m²)	(Sq)	(%)
SITE AREA	626.8	67.4	100
SITE COVERAGE	223.3	24.0	35.6
GARDEN AREA	306.4	32.9	48.9
PERMEABILITY	256.6	27.6	40.9
PARTICULARS - 11 STOREY AVENUE, HAMPTON.			
GROUND LEVEL	169.8	18.2	
FIRST LEVEL	114.5	12.3	
ALFRESCO	28.2	3.0	
GARAGE	39.3	4.2	






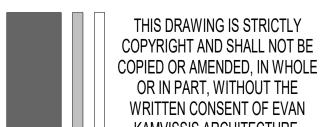


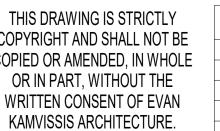


REV	DATE	DETAILS
*	11/06/2021	ISSUE FOR BUILDING PERMIT

SHEET NAME SITE PLAN

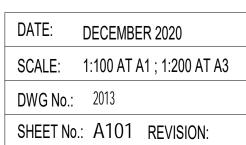

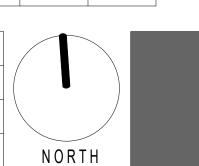

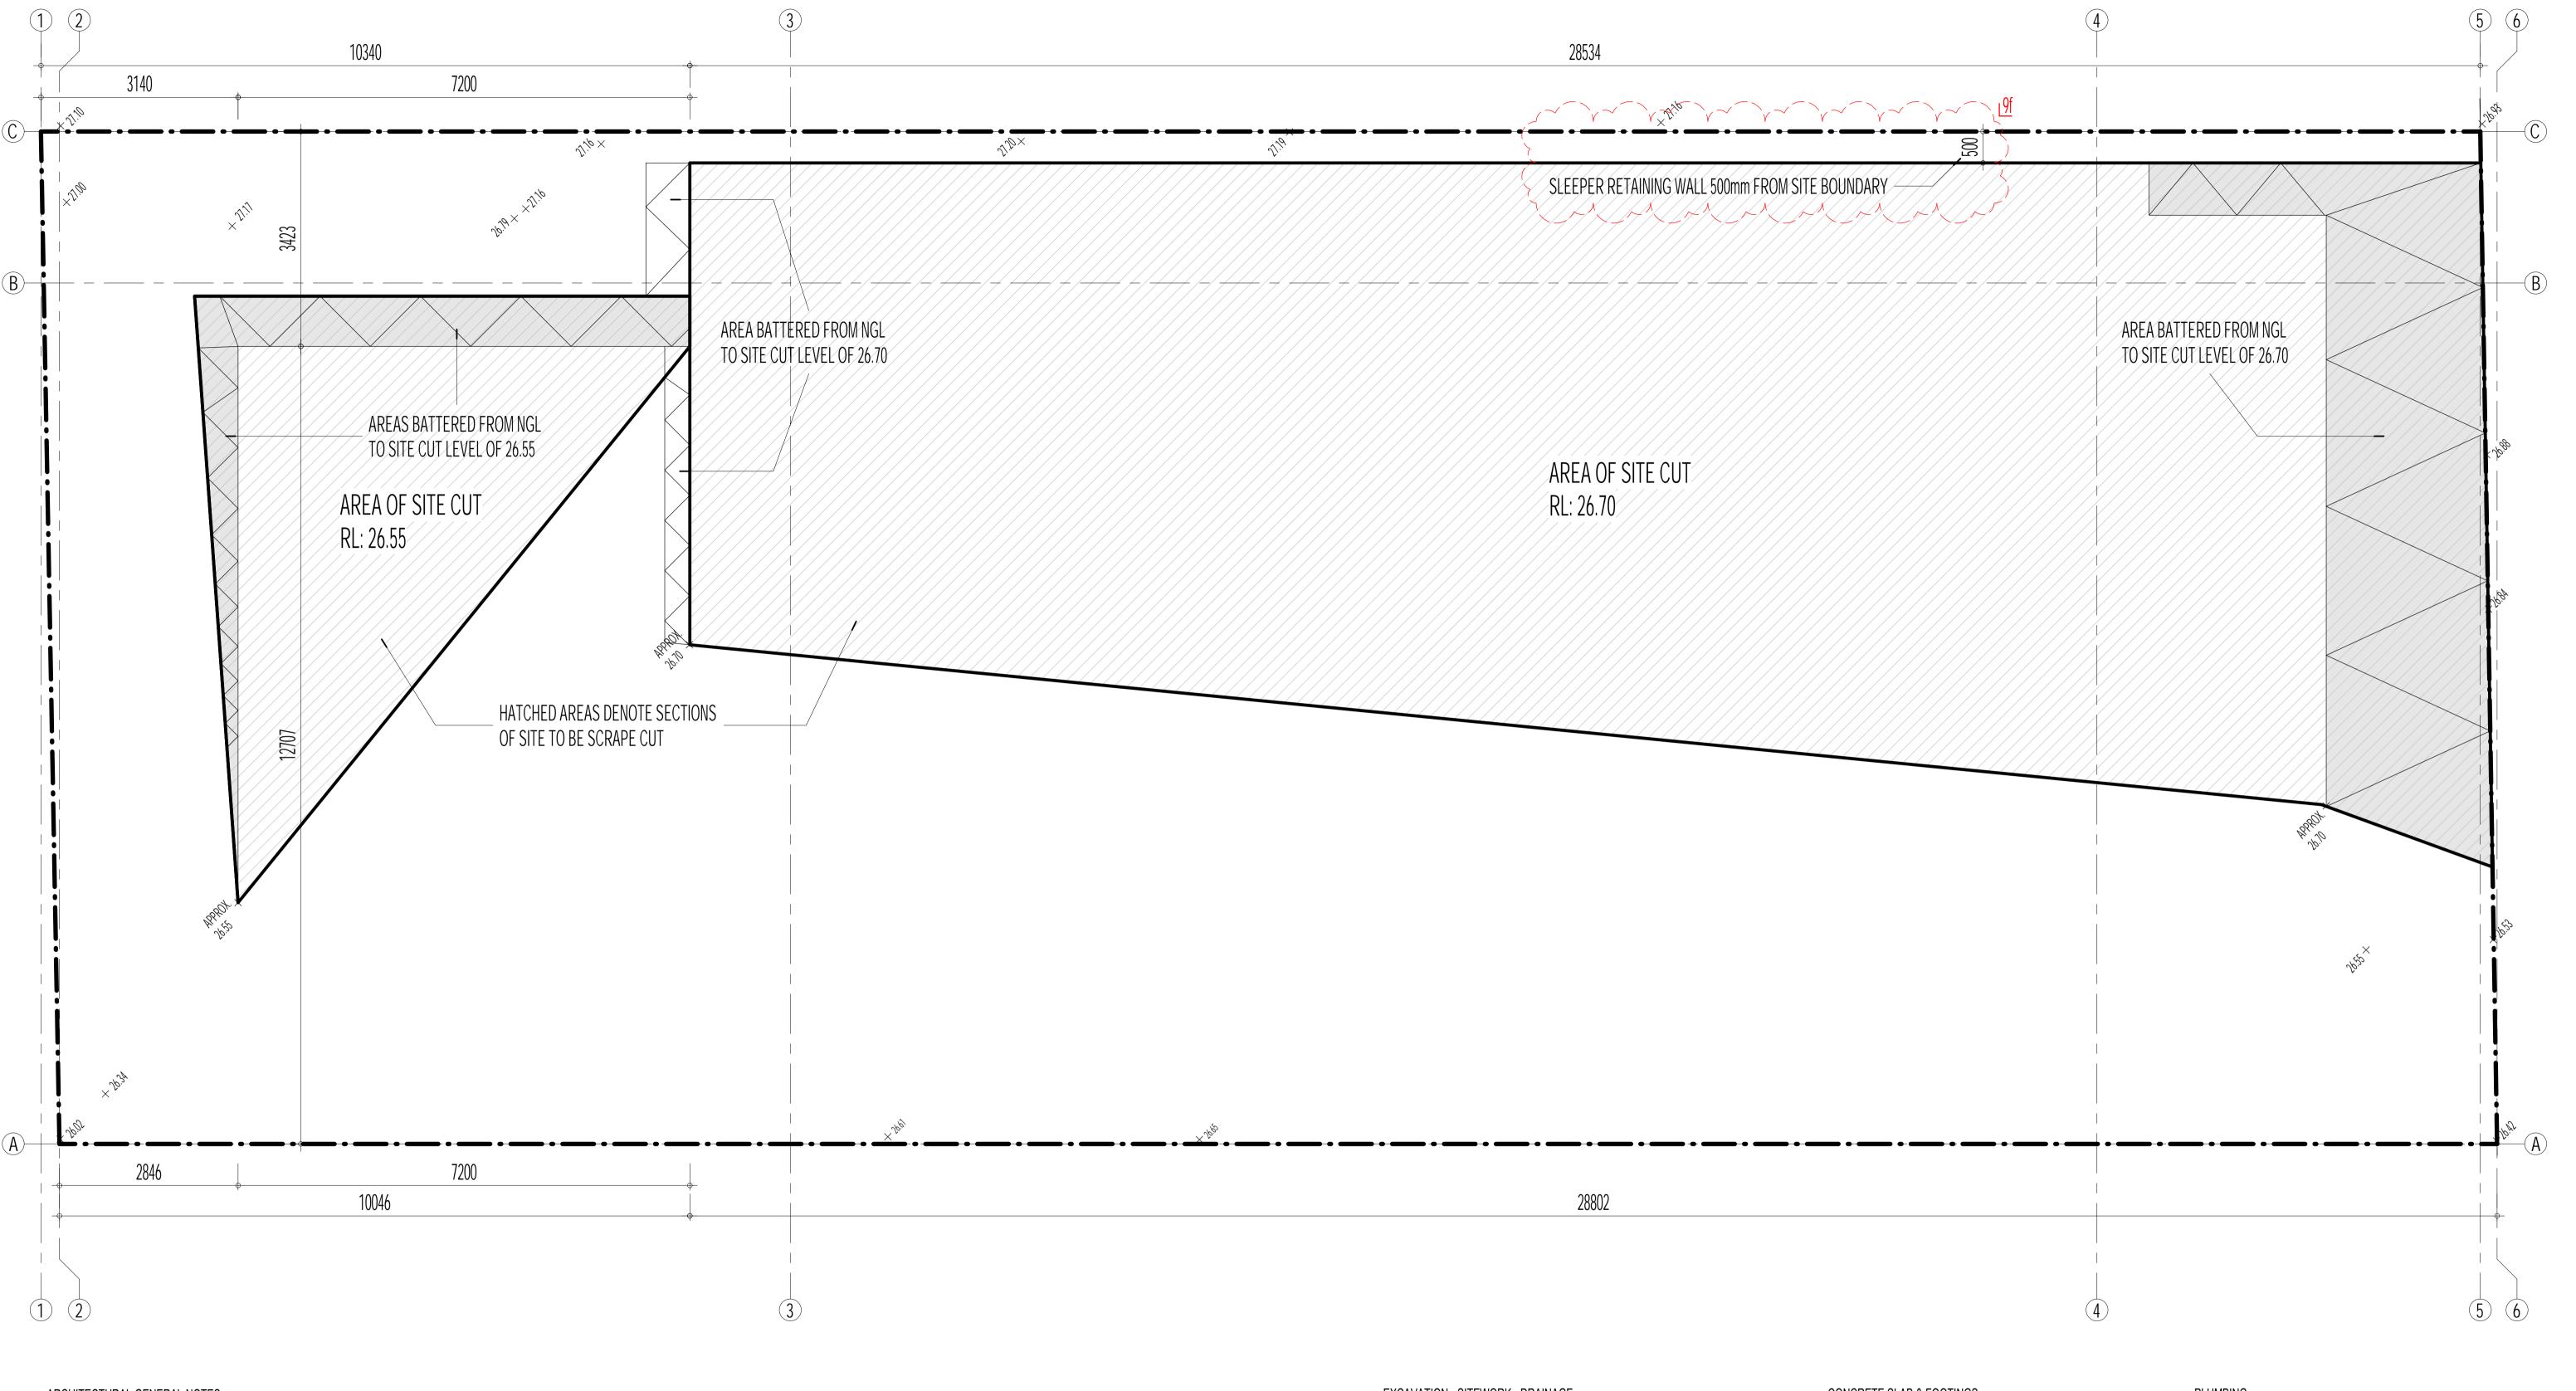

STRUCTURAL AND ALL OTHER CONSULTANTS DRAWINGS/DETAILS AND WITH LEVELS, SETBACKS, SPECIFICATIONS AND ALL OTHER RELEVANT ANY OTHER WRITTEN INSTRUCTIONS ISSUED IN THE COURSE OF THE

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EXCAVATION - SITEWORK - DRAINAGE

- GRUBB OUT ORGANIC MATTER AND SURFACE VEGETATION WITHIN BUILDING AREA. STORMWATER DRAINAGE TO COMPLY WITH AS 3500.3-2015.
- STORMWATER TO DISCHARGE TO EXISTING SYSTEM. CONTRACTOR TO VERIFY EXISTING CONDITIONS ON SITE.
- INSTALL MIN. DIA 100MM UPVC STORMWATER DRAIN AND SEWER TO MIN. 1 IN 100 FALL. (SEWER TO BE SEWER GRADE UPVC), TO
- ALLOW FOR INSPECTION OPENINGS AT ALL BENDS AND/OR MAX. 9000MM LENGTHS. NEW STORMWATER DRAINS TO BE CONNECTED TO EXISTING DTORMWATER DRAINS AND DISCHARGED TO A LEGAL POINT OF DISCHARGE IN ACCORDANCE WITH LOCAL AUTHORITY REQUIREMENTS.

CONCRETE SLAB & FOOTINGS

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SETDOWNS

• ALL TERRACES, BALCONIES AND PATIOS TO HAVE GRADED FALLS TO CAST IN OUTLETS, OVERFLOW POPS AND GRADED DISCHARGE TO CIVIL ENG.'S DWGS


PLUMBING

 PLUMBING INSTALLATION SHALL COMPLY TO AS 3500. RETICULATED PLUMBING INSTALLATION DESIGN TO SUIT. CONTRACTOR TO DISCUSS WITH OWNER AND THEIR REQUIREMENTS.







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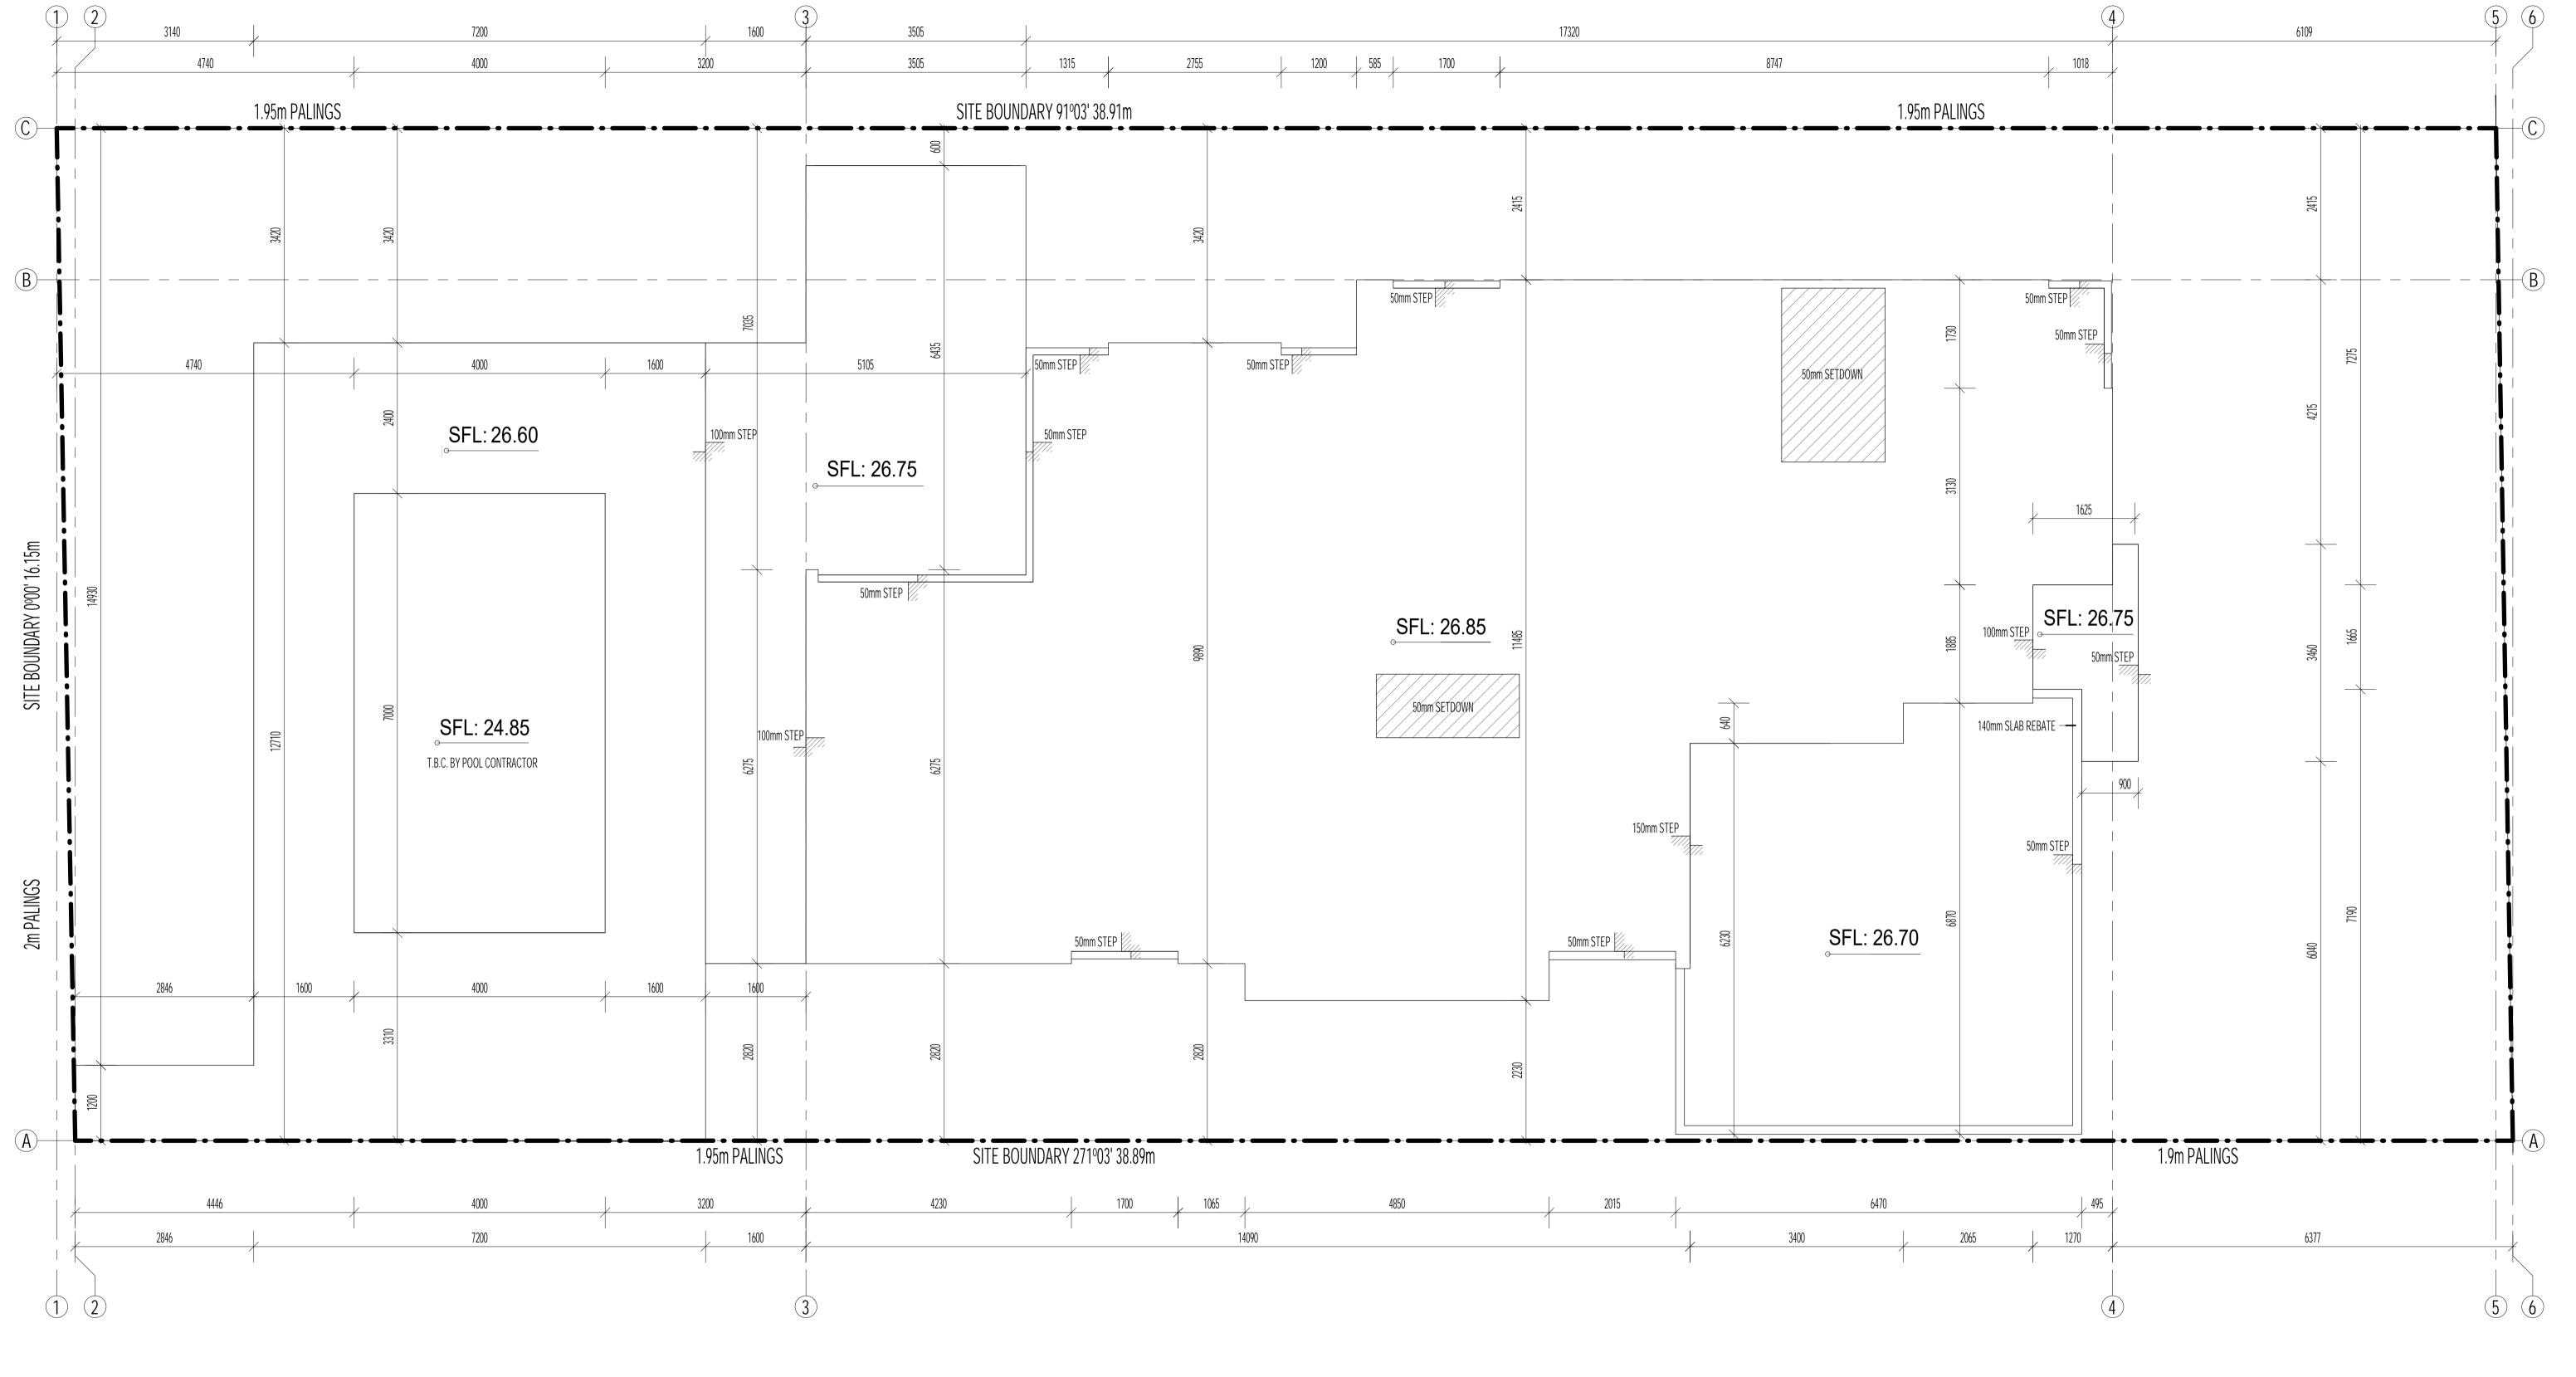


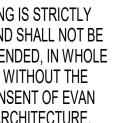REV	DATE	DETAILS
*	11/06/2021	ISSUE FOR BUILDING PERMIT

SHEET NAME SITE CUT PLAN



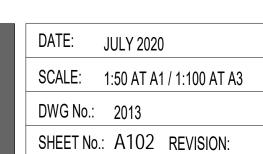

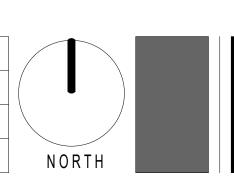

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PLUMBING

DWG No.: 2013


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SETDOWNS


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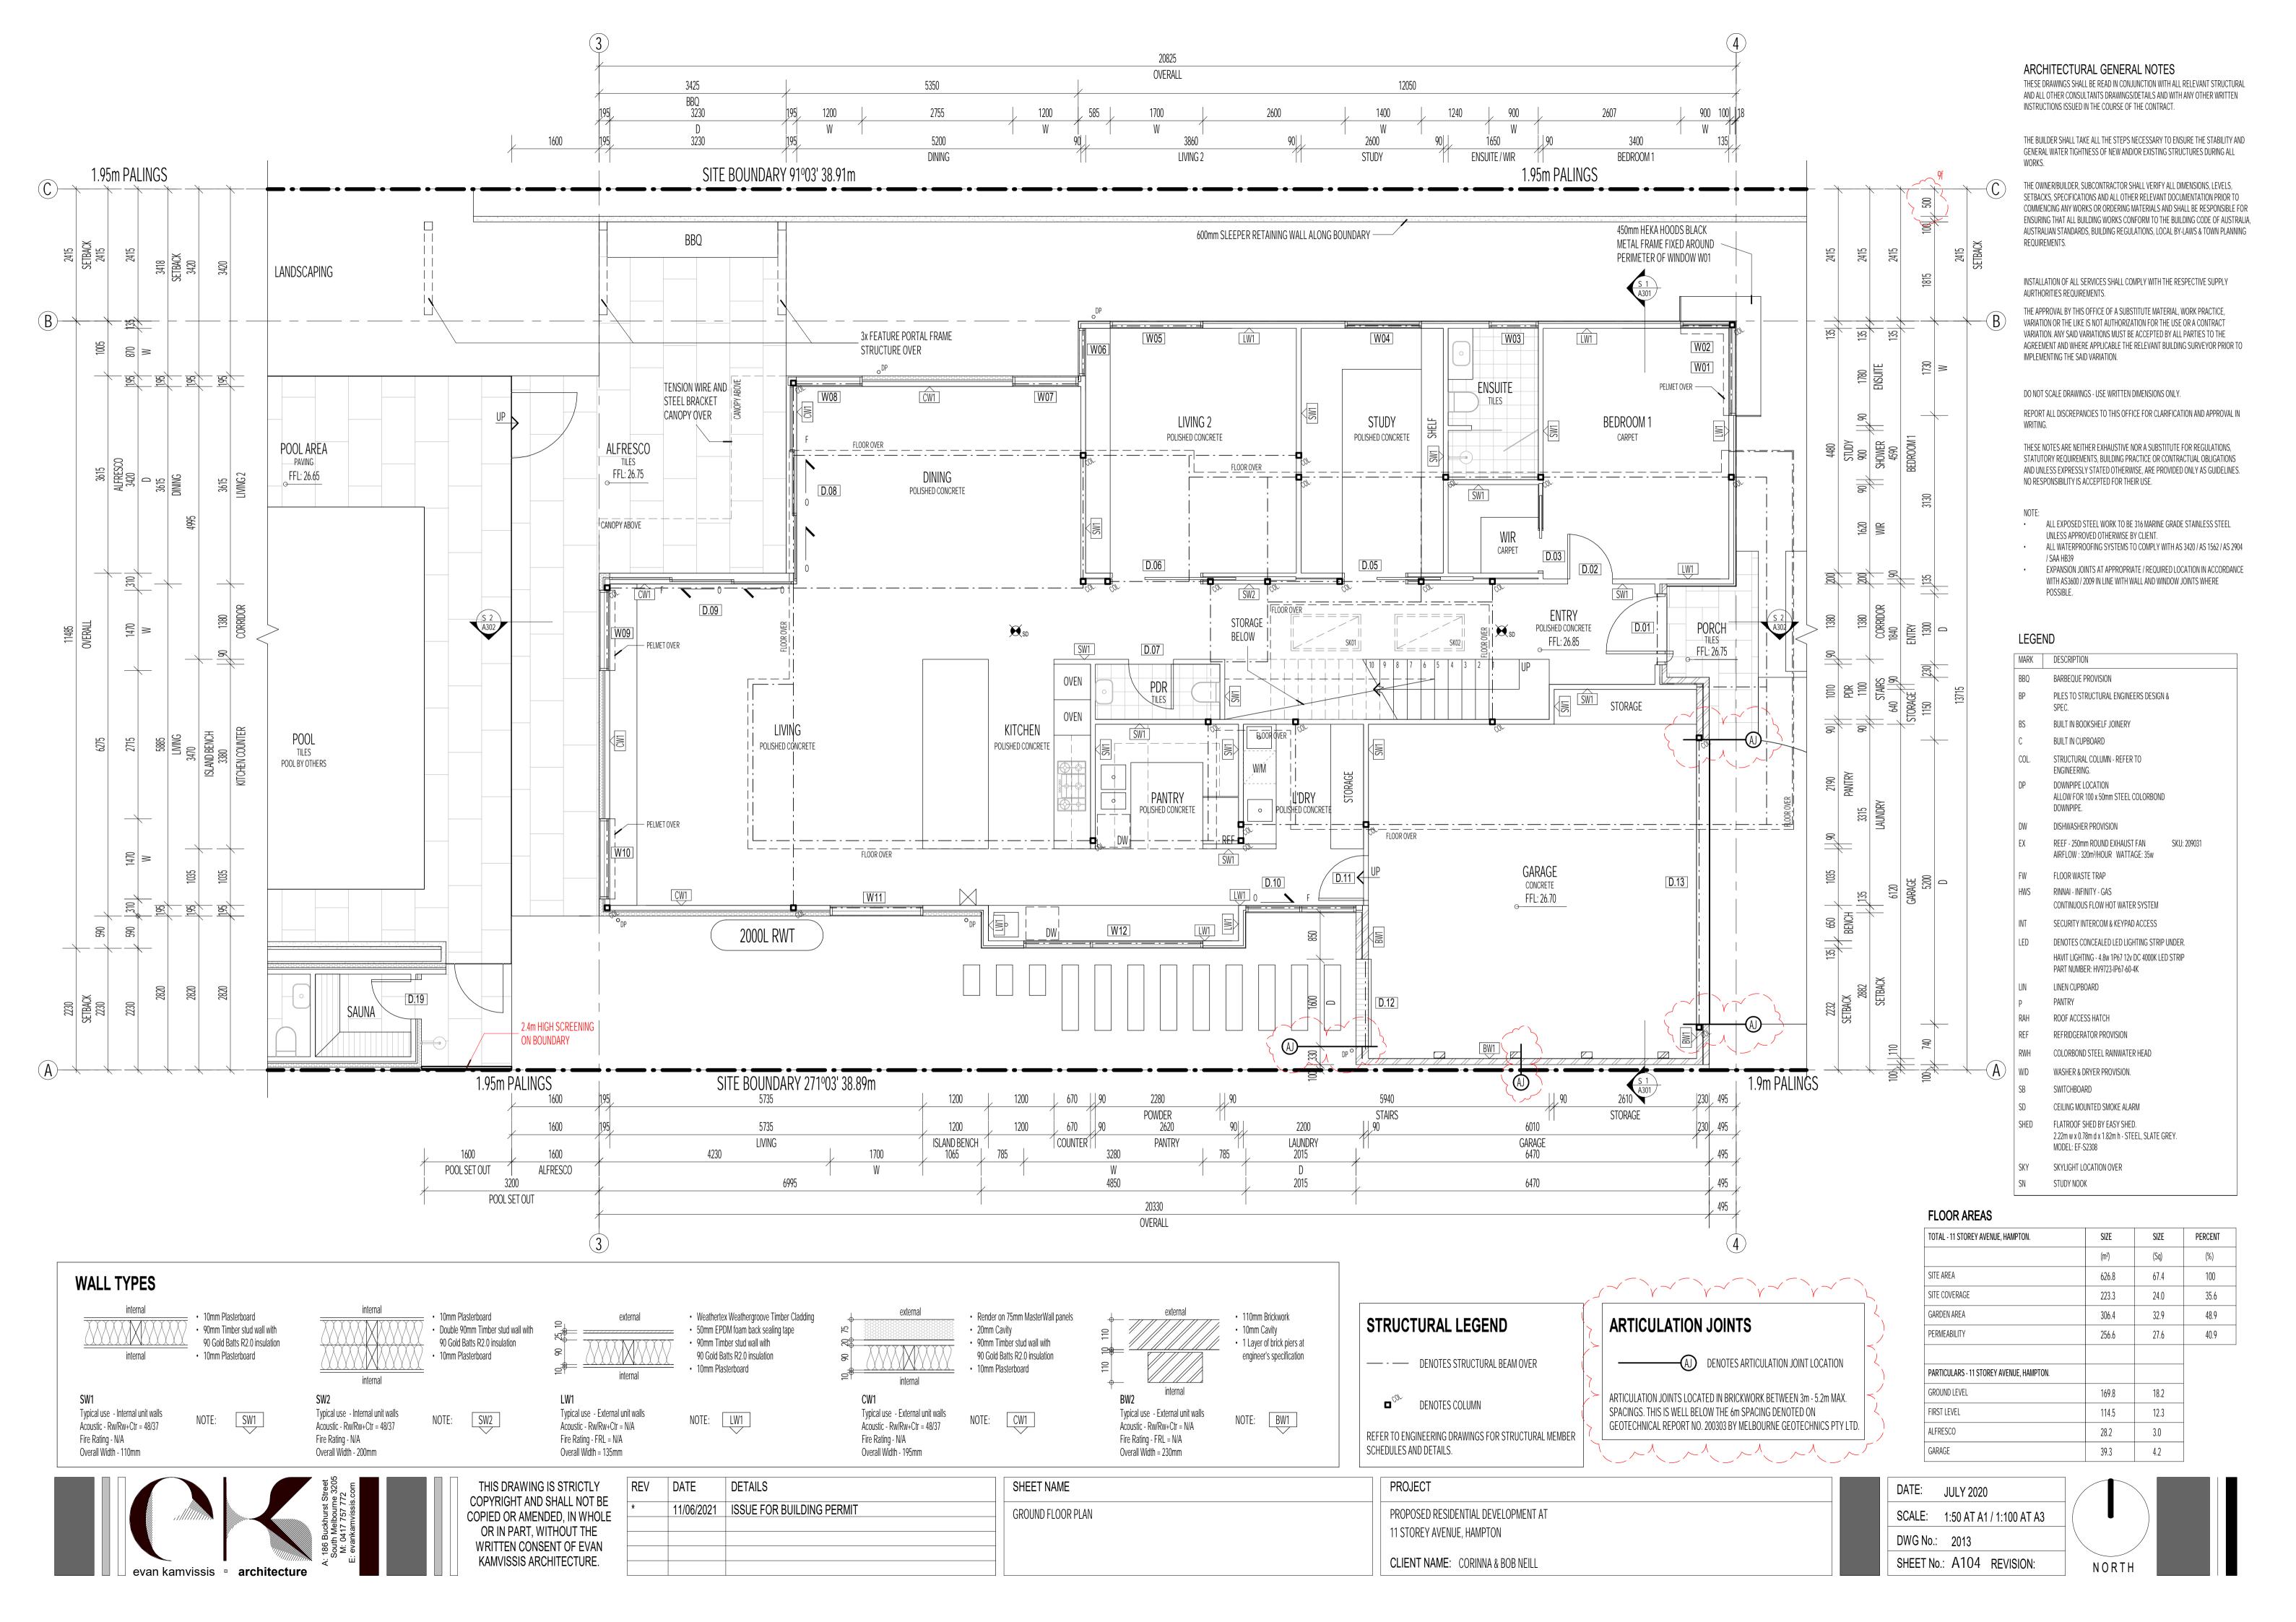
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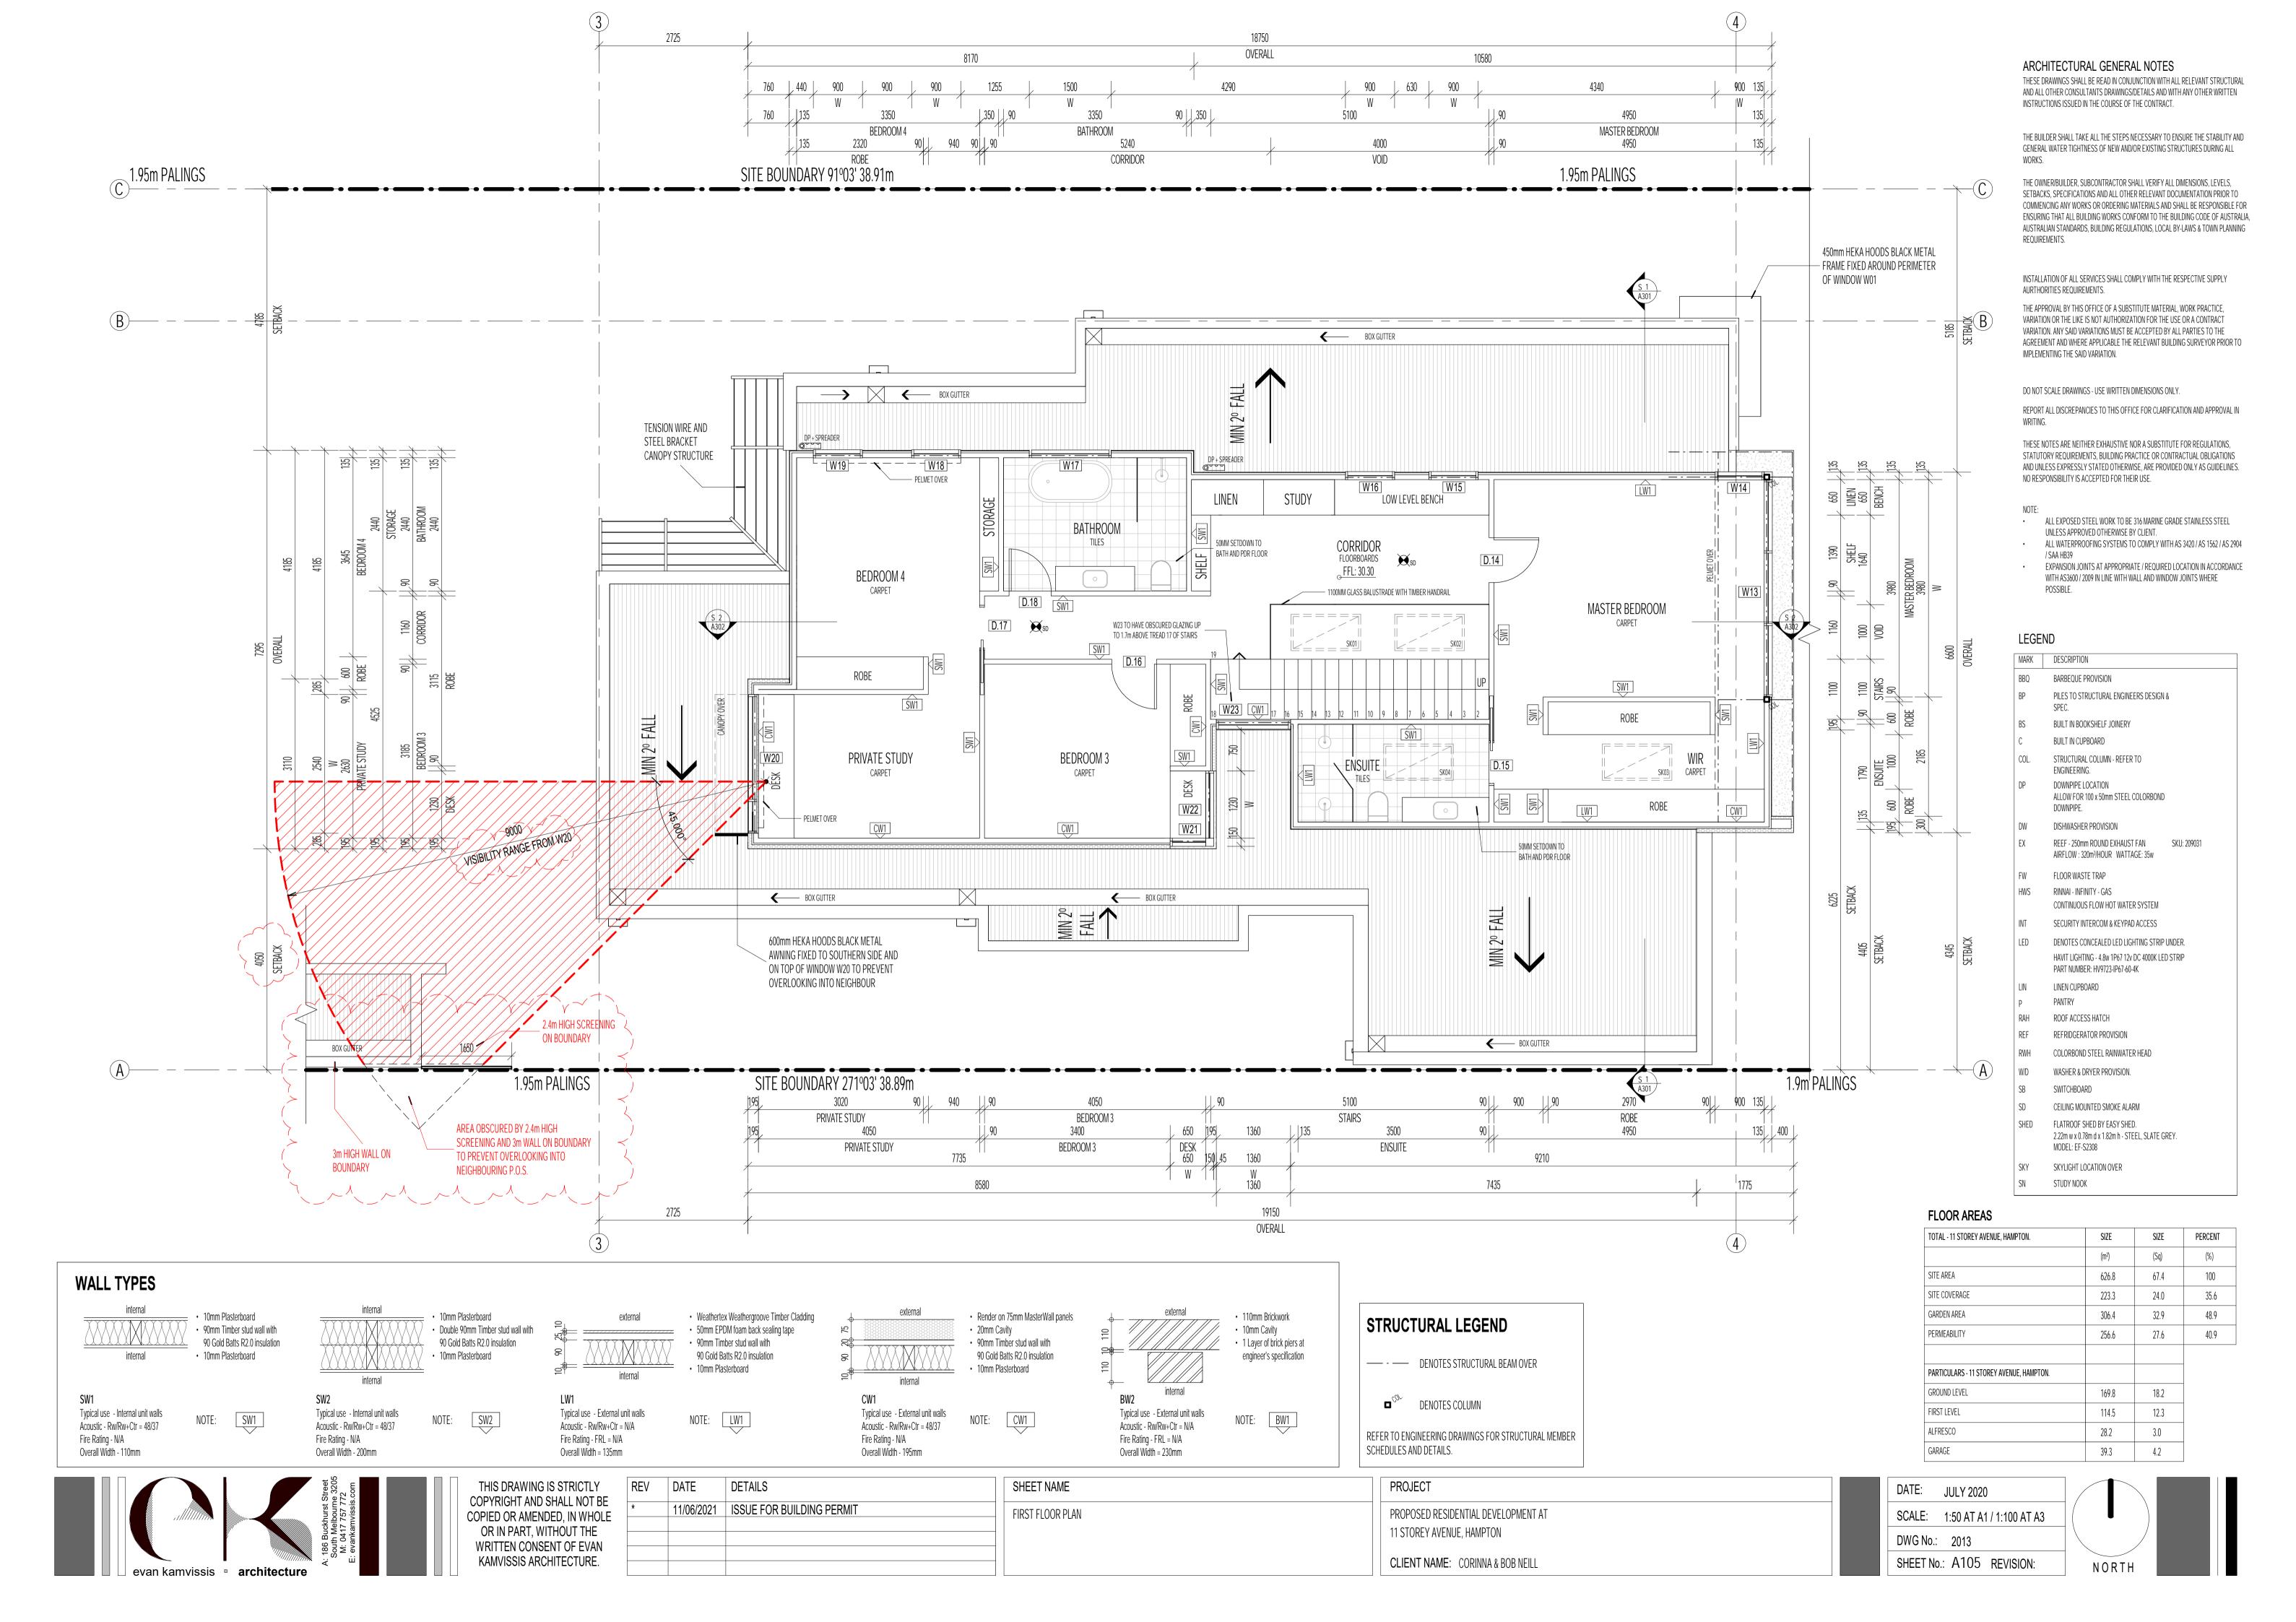



SHEET NAME SLAB SETOUT PLAN





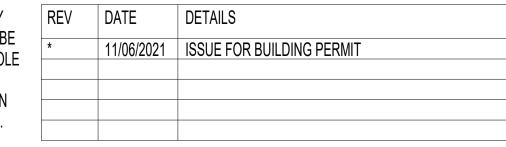

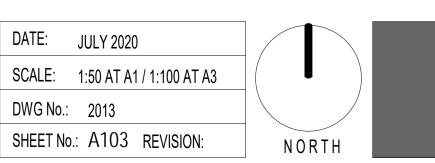

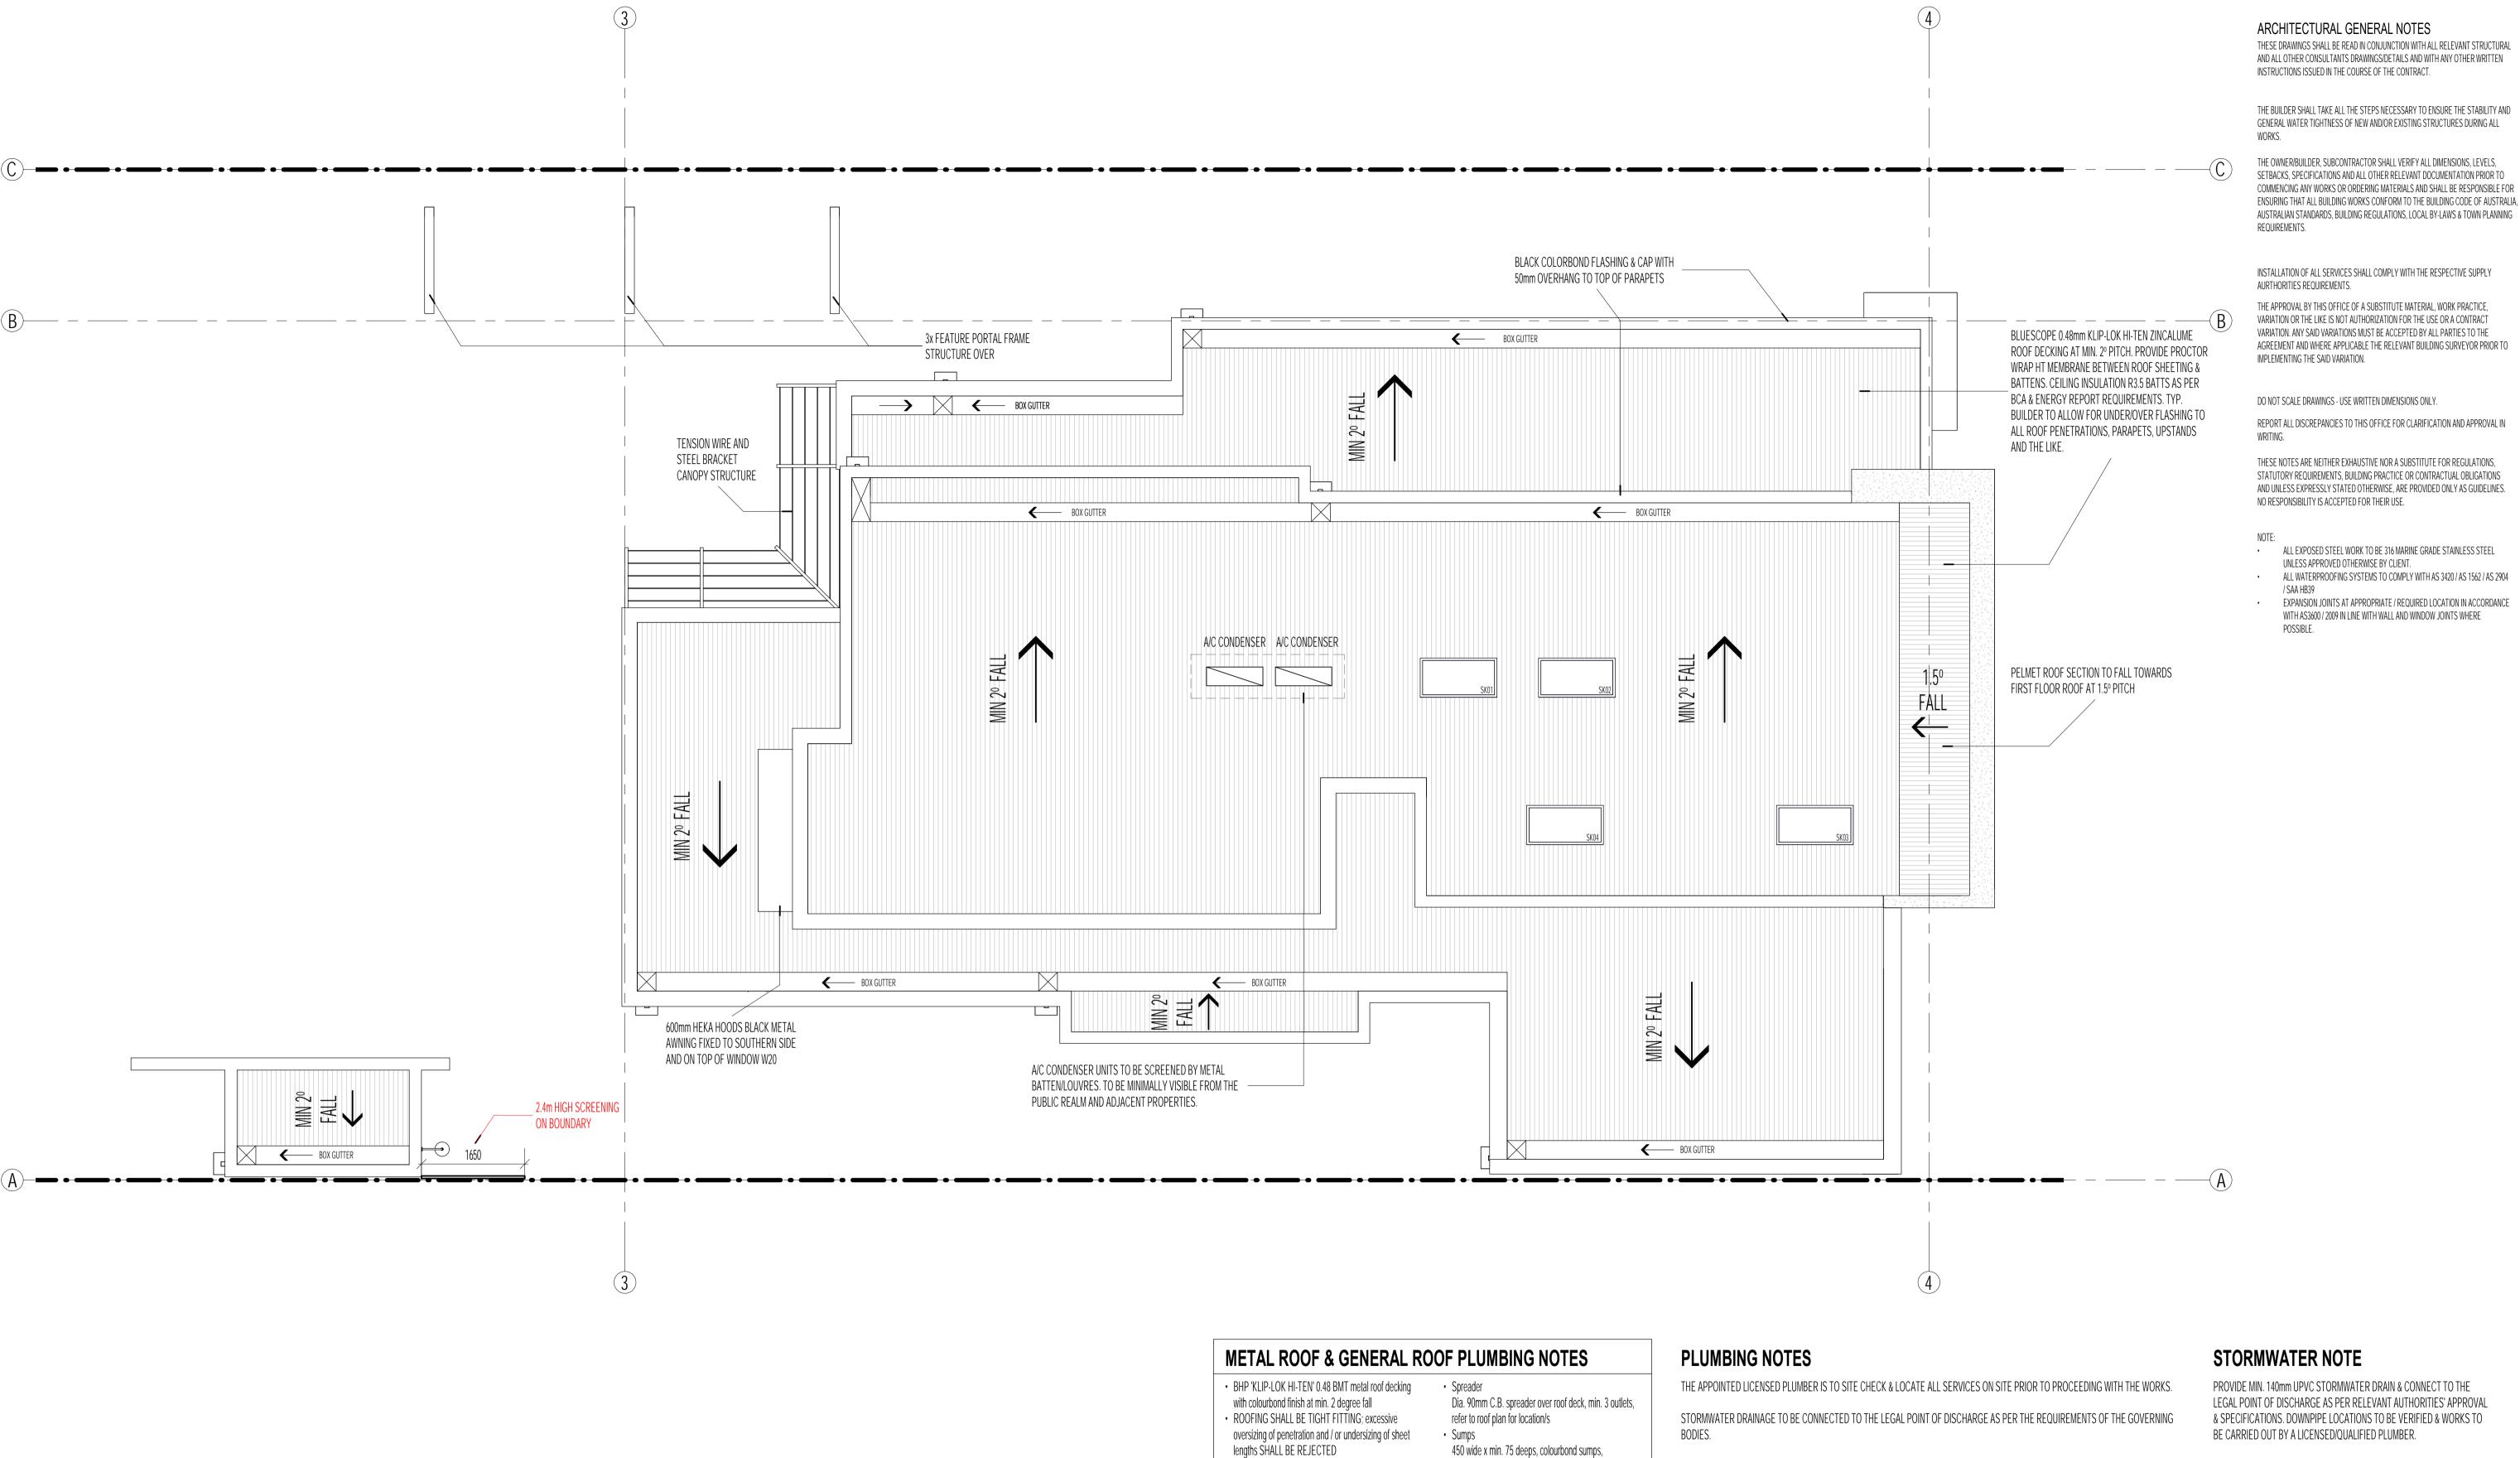

- Flash all service penetrations, such as vents, flues and the like with suitable flashings; EXCESSIVE AND OVERSIZED FLASHINGS AND CAPPINGS SHALL BE
- REJECTED Box Gutter 450 wide x min. 75 deep, colourbond box gutters, min.
- 0.55 BMT thick, set to min. 1:80 falls in directions as indicated on the roof plan. Provide 450 wide x 20mm thick continuous plywood gutter board under, supported at max. 450 ctrs
- 450 wide x min. 75 deeps, colourbond sumps,
- discharging into C.B. rainwater head with overflow pop. Installations may vary, allow to modify to suit location
- Downpipes (Dp) Dia. 90mm C.B. downpipes fixed to wall with sewer type brackets at max. 1800mm ctrs, evenly spaced unless
- noted otherwise Rainheads (Rh)
- 250 wide x 300 high x 125 deep, half round C.B. rainheads, min. 0.55 BMT, with dia. 30mm overflow pop. Installation may vary, allow to modify to suit location

IT IS THE RESPONSIBILITY OF THE PLUMBER TO ENSURE PROPOSED PIPES DO NOT ENCROACH THE TITLE BOUNDARIES.

WHERE SITE CUT IS NECESSARY TO ACHIEVE APPROPRIATE F.G.L. & F.F.L. AGGI DRAINS SHALL BE CONNECTED TO THE STORMWATER DRAIN VIA SILT PITS.

PROPOSED SERVICE PIPES TO BE SUSPENDED UNDER FLOOR & TO BE CONNECTED TO STORMWATER DRAIN. PLUMBER TO ENSURE NEW SERVICES DOES NOT ENCROACH EASEMENT.

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STORMWATER NOTE

PROVIDE MIN. 140mm UPVC STORMWATER DRAIN & CONNECT TO THE LEGAL POINT OF DISCHARGE AS PER RELEVANT AUTHORITIES' APPROVAL & SPECIFICATIONS. DOWNPIPE LOCATIONS TO BE VERIFIED & WORKS TO BE CARRIED OUT BY A LICENSED/QUALIFIED PLUMBER.



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DATE DETAILS 11/06/2021 ISSUE FOR BUILDING PERMIT


SHEET NAME **ROOF PLAN**


PROJECT PROPOSED RESIDENTIAL DEVELOPMENT AT 11 STOREY AVENUE, HAMPTON CLIENT NAME: CORINNA & BOB NEILL

DATE: DECEMBER 2020 SCALE: 1:100 AT A1; 1:200 AT A3

DWG No.: 2013



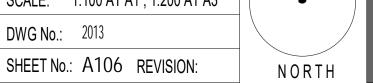

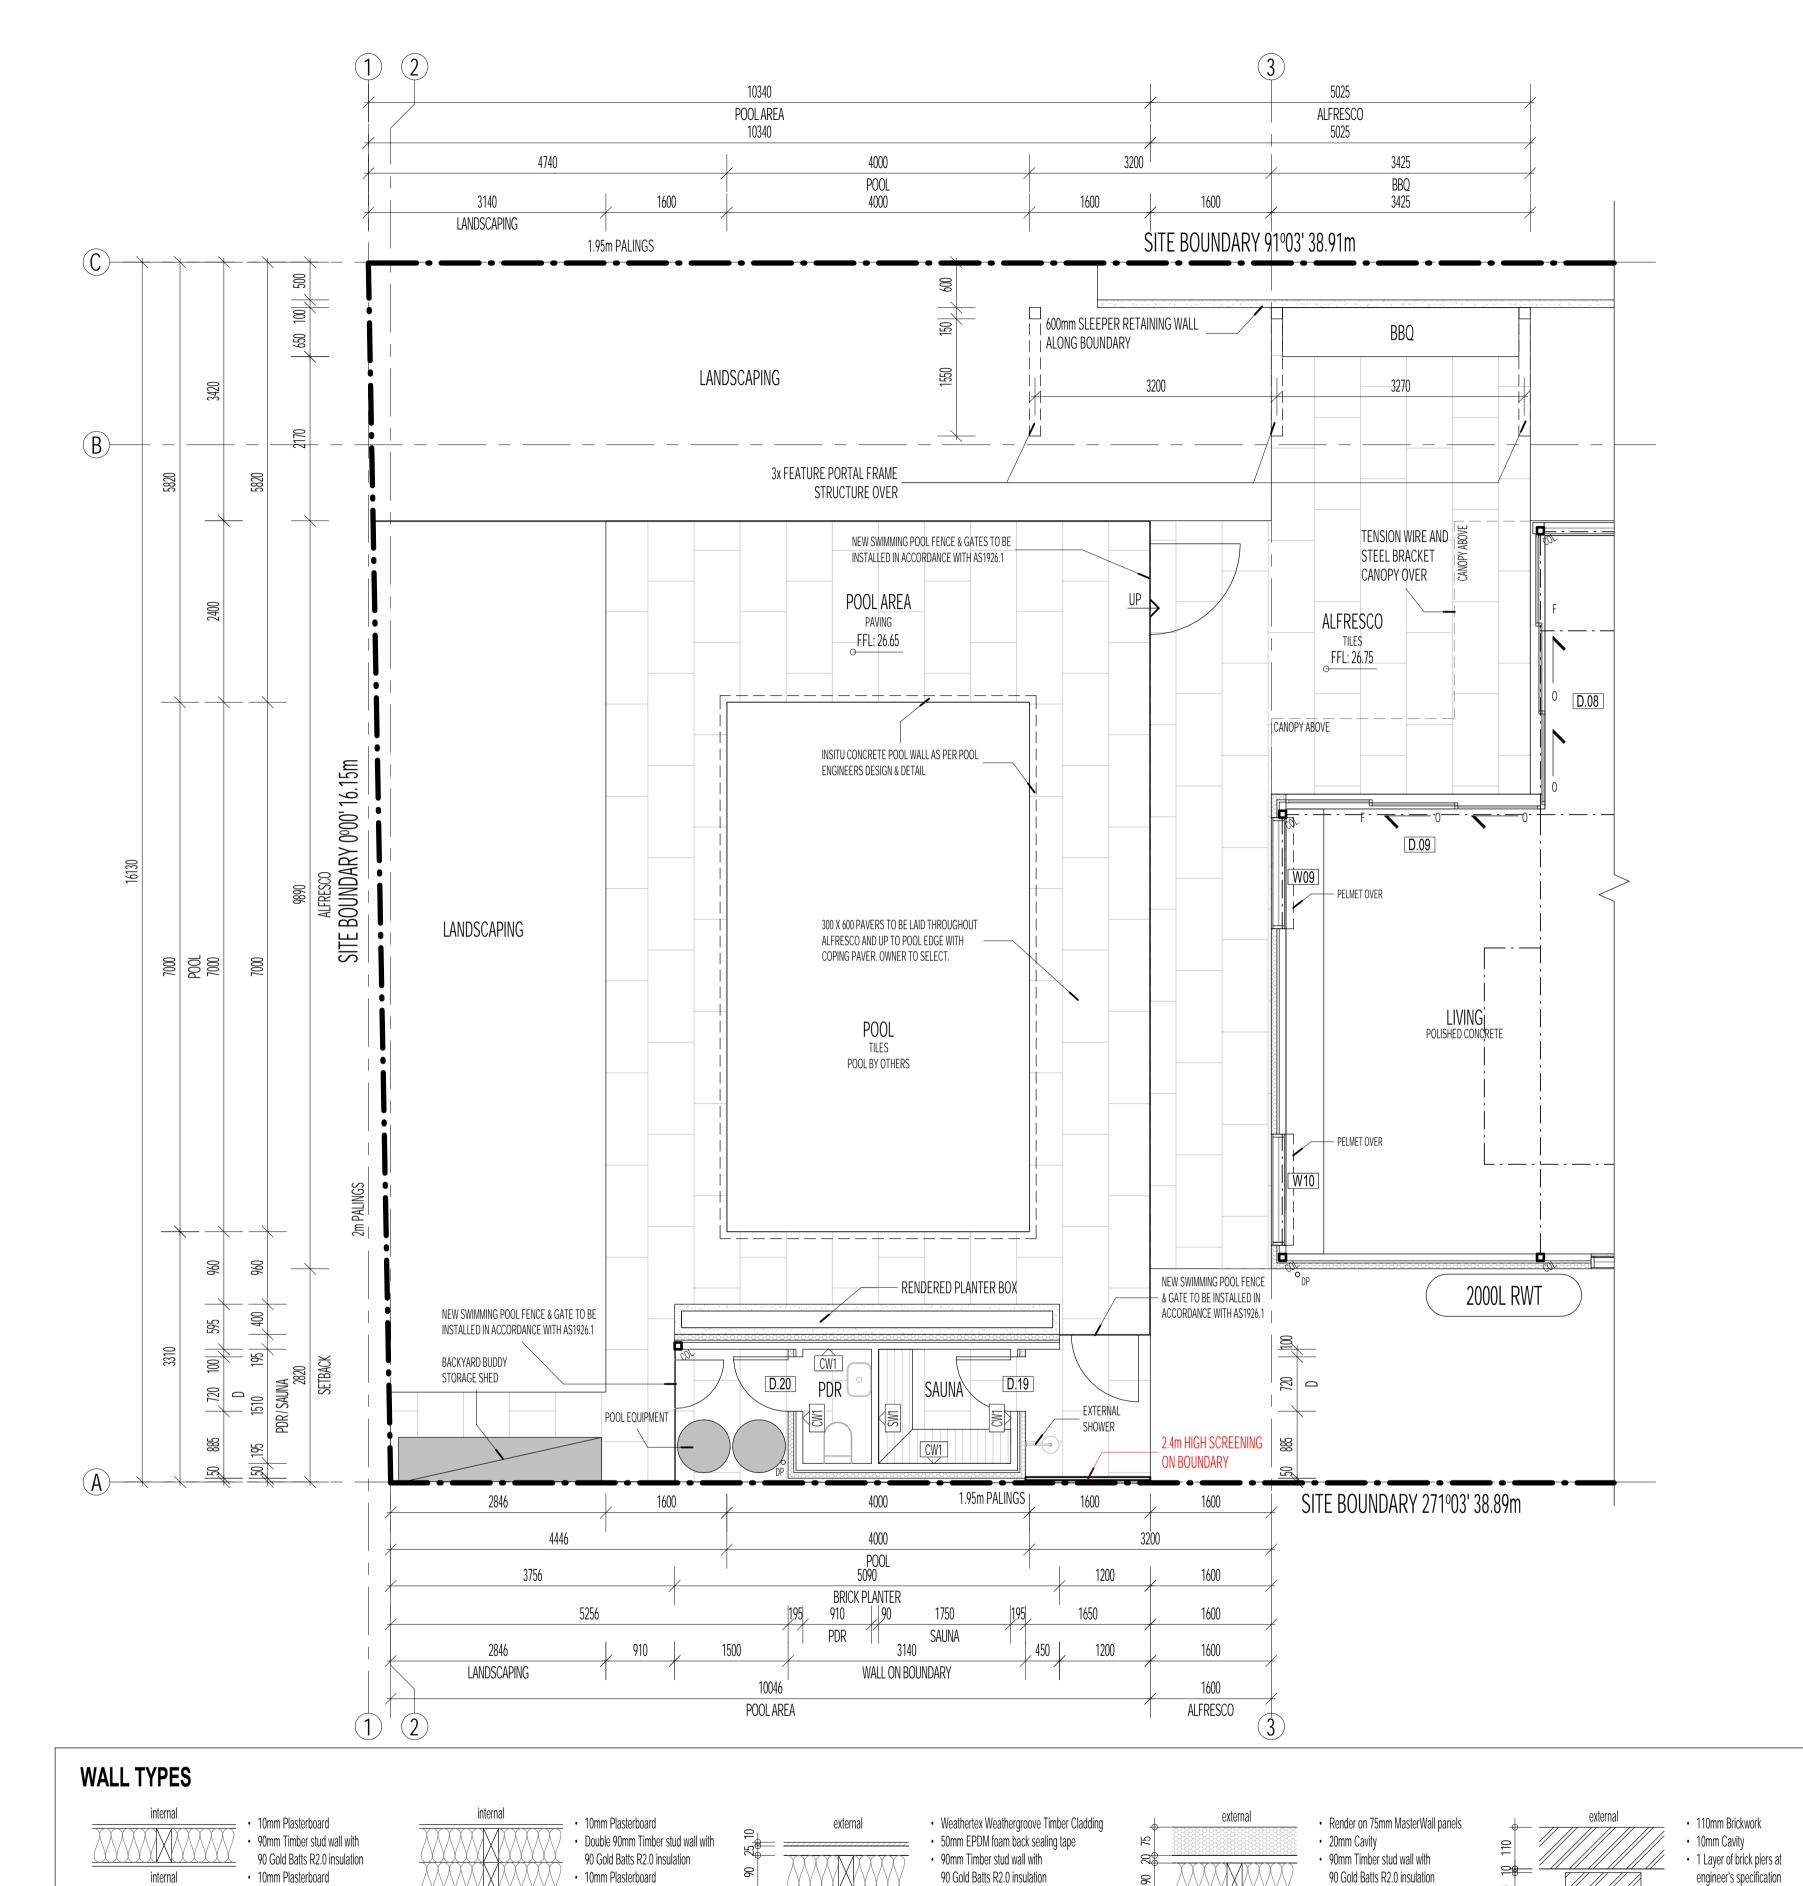

STRUCTURAL LEGEND

---- DENOTES STRUCTURAL BEAM OVER

DENOTES COLUMN

REFER TO ENGINEERING DRAWINGS FOR STRUCTURAL MEMBER SCHEDULES AND DETAILS.

RAINWATER RETENTION NOTES

TOILETS FOR FLUSHING.

PROVISION FOR 2 x 2000L RAIN WATER TANKS TO INDEPENDENTLY COLLECT WATER FROM DWELLINGS, BALCONY, TERRACE

STORMWATER FILTRATION PIT OR SIMILAR. WATER TO BE DISCHARGED VIA A MECHANICALLY PUMPED OR FULLY CHARGED SYSTEM INTO A 1m² 100mm RAINGARDEN, SETBACK 3675mm FROM BUILDING BOUNDARY. RAINGARDEN TO BE FULLY LINED

EXHAUST FAN FLUE TO PENETRATE ROOF OVER. ALL GAPS BETWEEN FLUE AND WALL / ROOF

CLADDING MUST BE CAULKED AND SEALED. EXHAUST COWL TO BE INSTALLED ABOVE ROOF TO

NOTE: VENTILATION COWL SHOWN IN INDICATIVE LOCATIONS ONLY - FINAL LOCATION AND EQUIPMENT

ALL EXHAUST FANS ARE TO DISCHARGE TO OUTSIDE AIR AT A RATE OF 25L/s FOR A

BATHROOM / SANITARY COMPARTMENT AND 40L/s FOR A KITCHEN OR LAUNDRY IN

ACCORDANCE WITH NCC 2019, VOL 2, PART 3.8.7 CONDENSATION MANAGEMENT.

/ COURTYARDS & DRIVEWAY CATCHMENT AREAS. RAINWATER COLLECTED & DISCHARGED INTO ENVISS SENTINEL

WITH AN IMPERVIOUS LINER AND HAVE ITS OVERFLOW & AGGI DRAIN CONNECTED TO THE LPOD.

THE INDEPENDENTLY COLLECTED FROM ROOF CATCHMENT AREAS IS TO BE COLLECTED AND

SELECTED BY OWNER IN 2000L CAPACITY RAINWATER TANK WHICH IS TO BE CONNECTED TO

DISCHAGED VIA A MECHANICALLY PUMPED, FULLY CHARGED OR GRAVITY FED SYSTEM

VENTILATION LEGEND

MANUFACTURERS SPECIFICATION.

TYPE TO BE CONFIRMED WITH MECHANICAL CONTRACTOR.

PROJECT PROPOSED RESIDENTIAL DEVELOPMENT AT 11 STOREY AVENUE, HAMPTON CLIENT NAME: CORINNA & BOB NEILL

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LEGEND

MARK	DESCRIPTION
BBQ	BARBEQUE PROVISION
BP	PILES TO STRUCTURAL ENGINEERS DESIGN & SPEC.
BS	BUILT IN BOOKSHELF JOINERY
С	BUILT IN CUPBOARD
COL.	STRUCTURAL COLUMN - REFER TO ENGINEERING.
DP	DOWNPIPE LOCATION ALLOW FOR 100 x 50mm STEEL COLORBOND DOWNPIPE.
DW	DISHWASHER PROVISION
EX	REEF - 250mm ROUND EXHAUST FAN SKU: 209031 AIRFLOW: 320m³/HOUR WATTAGE: 35w
FW	FLOOR WASTE TRAP
HWS	RINNAI - INFINITY - GAS CONTINUOUS FLOW HOT WATER SYSTEM
INT	SECURITY INTERCOM & KEYPAD ACCESS
LED	DENOTES CONCEALED LED LIGHTING STRIP UNDER. HAVIT LIGHTING - 4.8w 1P67 12v DC 4000K LED STRIP PART NUMBER: HV9723-IP67-60-4K
LIN	LINEN CUPBOARD
Р	PANTRY
RAH	ROOF ACCESS HATCH
REF	REFRIDGERATOR PROVISION
RWH	COLORBOND STEEL RAINWATER HEAD
W/D	WASHER & DRYER PROVISION.
SB	SWITCHBOARD
SD	CEILING MOUNTED SMOKE ALARM
SHED	FLATROOF SHED BY EASY SHED. 2.22m w x 0.78m d x 1.82m h - STEEL, SLATE GREY. MODEL: EF-S2308
SKY	SKYLIGHT LOCATION OVER
SN	STUDY NOOK


FLOOR AREAS


JULY 2020


SHEET No.: A107 REVISION:

DWG No.: 2013

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	(m²)	(Sq)	(%)
SITE AREA	626.8	67.4	100
SITE COVERAGE	223.3	24.0	35.6
GARDEN AREA	306.4	32.9	48.9
PERMEABILITY	256.6	27.6	40.9
PARTICULARS - 11 STOREY AVENUE, HAMPTON.			
GROUND LEVEL	169.8	18.2	
FIRST LEVEL	114.5	12.3	
ALFRESCO	28.2	3.0	
GARAGE	39.3	4.2	

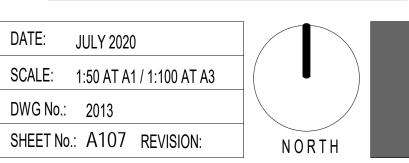

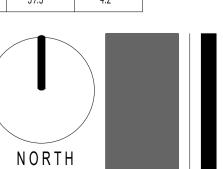

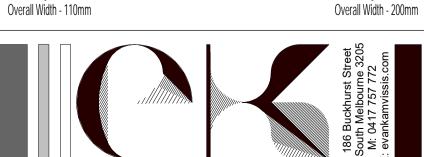

Typical use - Internal unit walls

Acoustic - Rw/Rw+Ctr = 48/37


Fire Rating - N/A



Typical use - Internal unit walls

Acoustic - Rw/Rw+Ctr = 48/37

Fire Rating - N/A

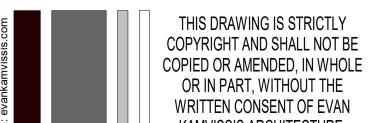



10mm Plasterboard

NOTE: LW1

Typical use - External unit walls

Acoustic - Rw/Rw+Ctr = N/A

Fire Rating - FRL = N/A

Overall Width = 135mm

SHEET NAME OUTDOOR LIVING AREA PLAN

NOTE: BW1

internal

Typical use - External unit walls Acoustic - Rw/Rw+Ctr = N/A

Fire Rating - FRL = N/A

Overall Width = 230mm


10mm Plasterboard

Typical use - External unit walls

Acoustic - Rw/Rw+Ctr = 48/37

Fire Rating - N/A

Overall Width - 195mm

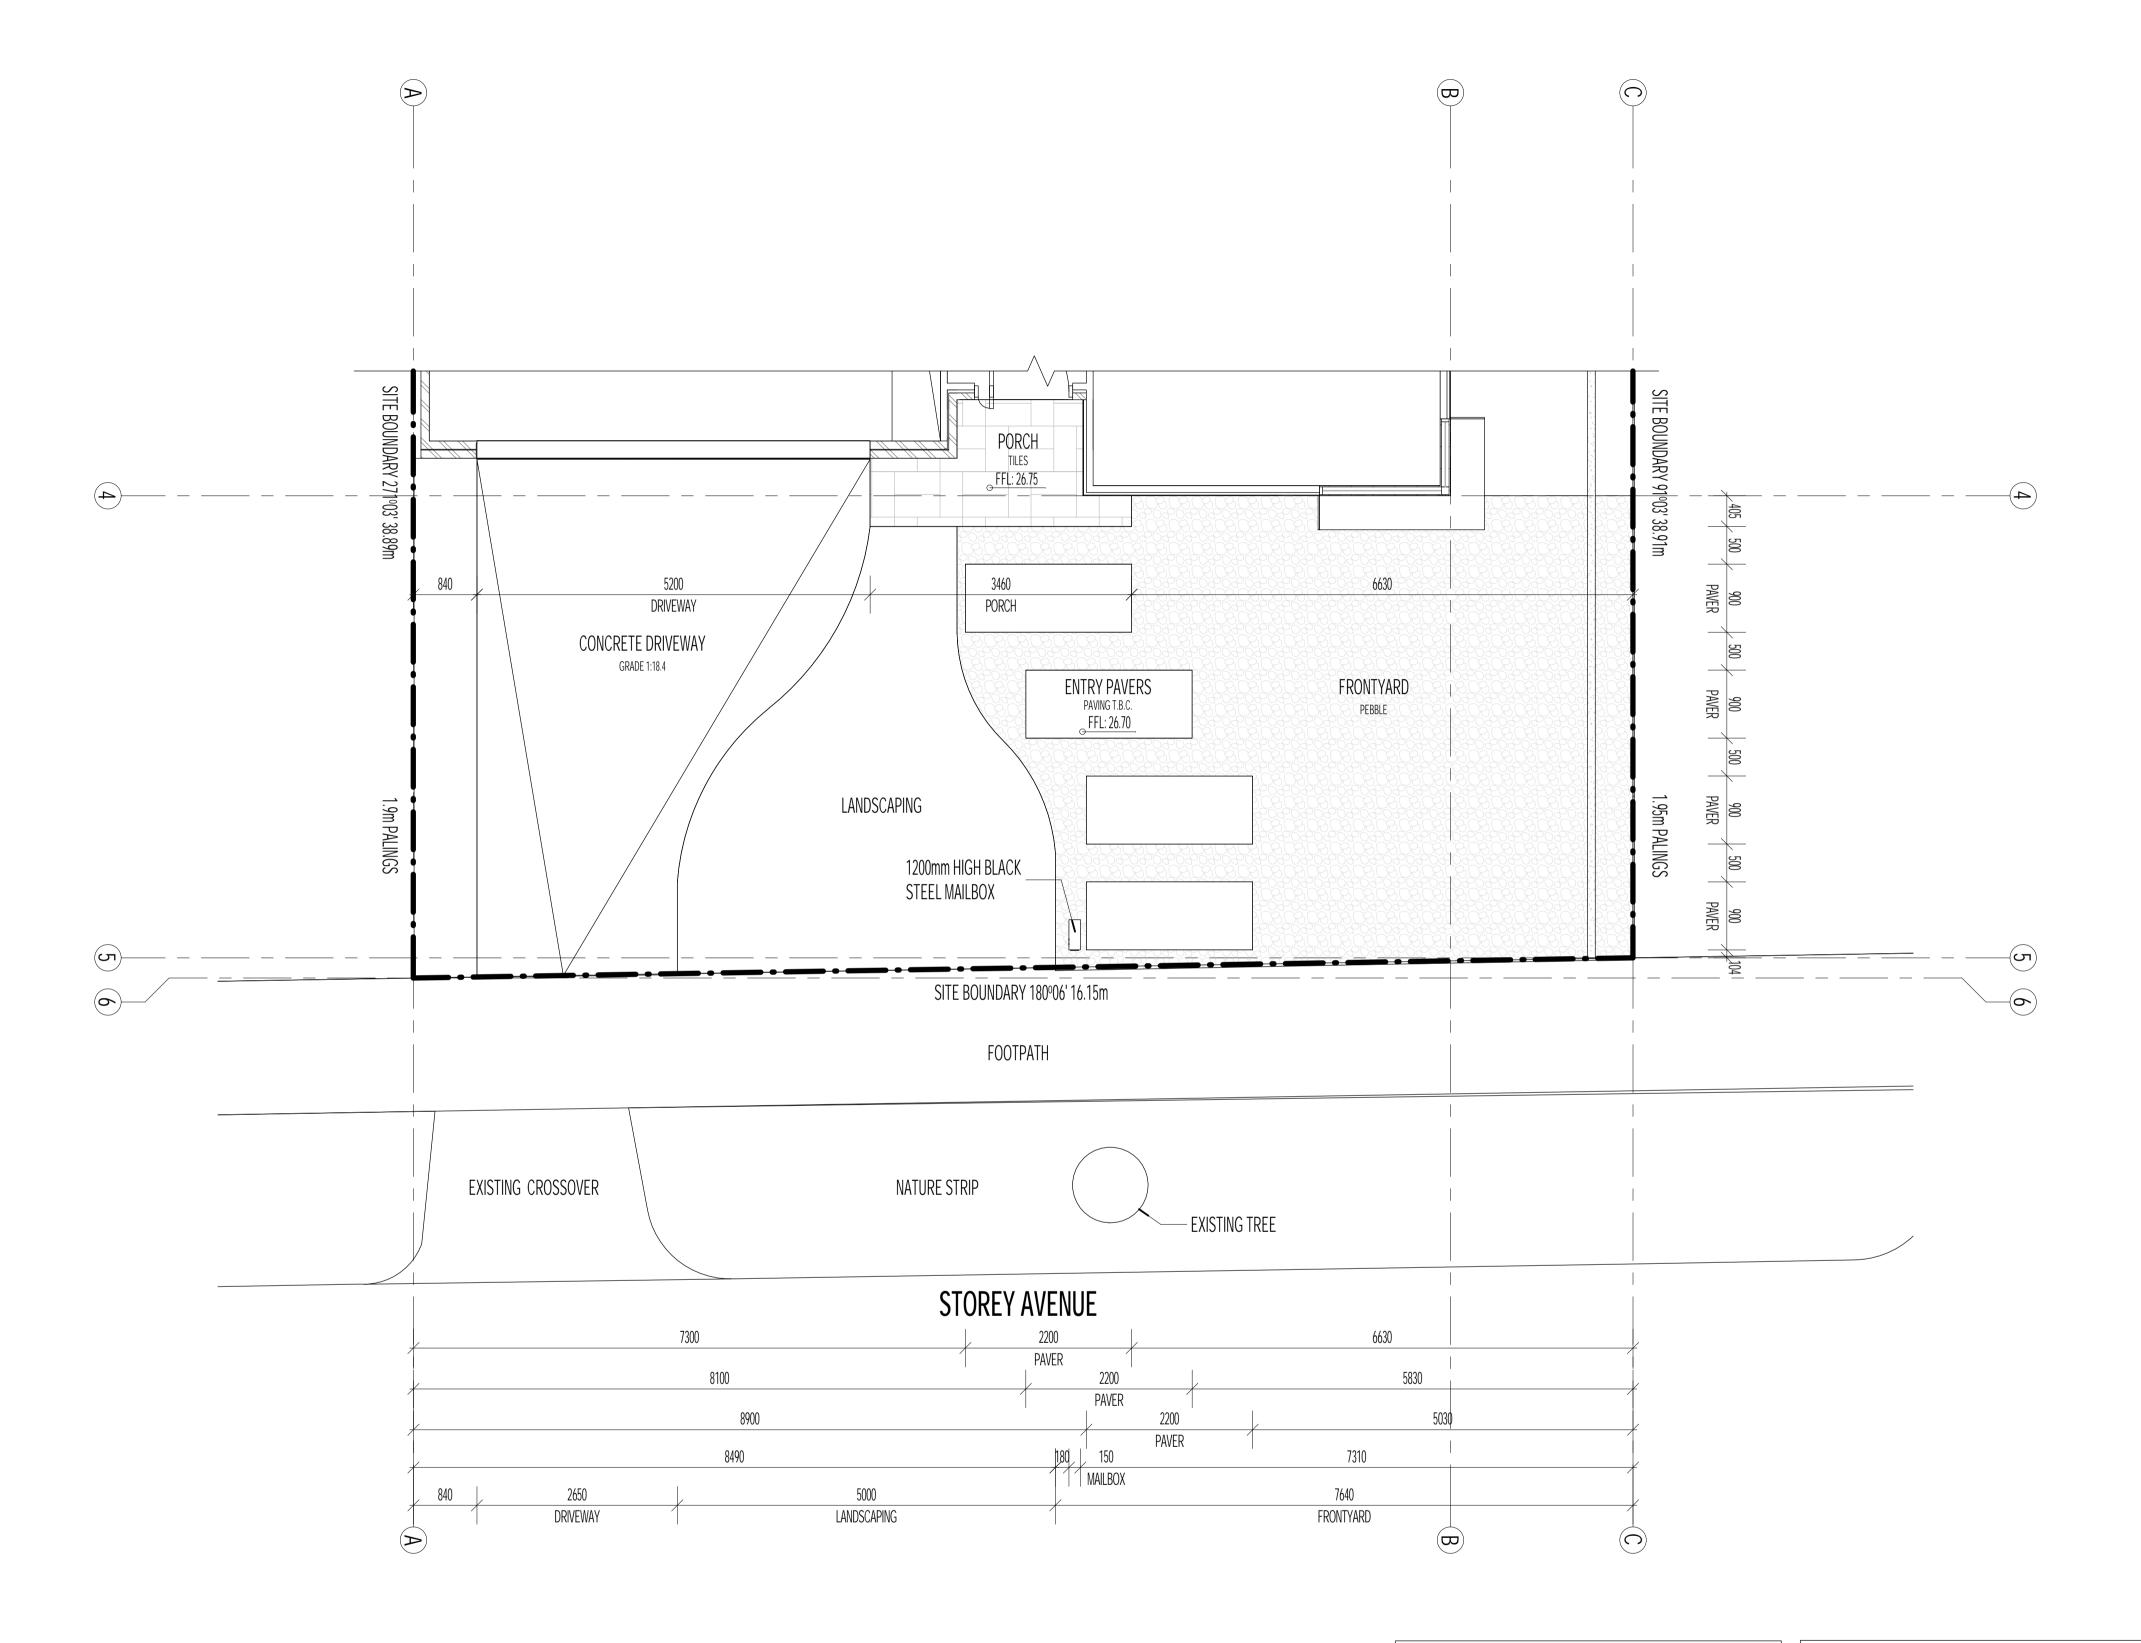

VENTILATION LEGEND

EXHAUST FAN FLUE TO PENETRATE ROOF OVER. ALL GAPS BETWEEN FLUE AND WALL / ROOF CLADDING MUST BE CAULKED AND SEALED. EXHAUST COWL TO BE INSTALLED ABOVE ROOF TO MANUFACTURERS SPECIFICATION.

VENTILATION COWL.

NOTE: VENTILATION COWL SHOWN IN INDICATIVE LOCATIONS ONLY - FINAL LOCATION AND EQUIPMENT TYPE TO BE CONFIRMED WITH MECHANICAL CONTRACTOR.

ALL EXHAUST FANS ARE TO DISCHARGE TO OUTSIDE AIR AT A RATE OF 25L/S FOR A BATHROOM / SANITARY COMPARTMENT AND 40L/S FOR A KITCHEN OR LAUNDRY IN ACCORDANCE WITH NCC 2019, VOL 2, PART 3.8.7 CONDENSATION MANAGEMENT.

RAINWATER RETENTION NOTES

PROVISION FOR 2 x 2000L RAIN WATER TANKS TO INDEPENDENTLY COLLECT WATER FROM DWELLINGS, BALCONY, TERRACE / COURTYARDS & DRIVEWAY CATCHMENT AREAS. RAINWATER COLLECTED & DISCHARGED INTO ENVISS SENTINEL STORMWATER FILTRATION PIT OR SIMILAR. WATER TO BE DISCHARGED VIA A MECHANICALLY PUMPED OR FULLY CHARGED SYSTEM INTO A 1n² 100mm RAINGARDEN, SETBACK 3675mm FROM BUILDING BOUNDARY. RAINGARDEN TO BE FULLY LINED WITH AN IMPERVIOUS LINER AND HAVE ITS OVERFLOW & AGGI DRAIN CONNECTED TO THE LPOD.

THE INDEPENDENTLY COLLECTED FROM ROOF CATCHMENT AREAS IS TO BE COLLECTED AND DISCHAGED VIA A MECHANICALLY PUMPED, FULLY CHARGED OR GRAVITY FED SYSTEM SELECTED BY OWNER IN 2000L CAPACITY RAINWATER TANK WHICH IS TO BE CONNECTED TO TOILETS FOR FLUSHING.

ARCHITECTURAL GENERAL NOTES

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NO

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- ALL WATERPROOFING SYSTEMS TO COMPLY WITH AS 3420 / AS 1562 / AS 2904
 / SAA HB30
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 WITH AS3600 / 2009 IN LINE WITH WALL AND WINDOW JOINTS WHERE
 POSSIBLE


 OUT TO SHARE THE PROPERTY OF THE

LEGEND

MARK	DESCRIPTION
BBQ	BARBEQUE PROVISION
BP	PILES TO STRUCTURAL ENGINEERS DESIGN & SPEC.
BS	BUILT IN BOOKSHELF JOINERY
С	BUILT IN CUPBOARD
COL.	STRUCTURAL COLUMN - REFER TO ENGINEERING.
DP	DOWNPIPE LOCATION ALLOW FOR 100 x 50mm STEEL COLORBOND DOWNPIPE.
DW	DISHWASHER PROVISION
EX	REEF - 250mm ROUND EXHAUST FAN SKU: 209031 AIRFLOW: 320m³/HOUR WATTAGE: 35w
FW	FLOOR WASTE TRAP
HWS	RINNAI - INFINITY - GAS CONTINUOUS FLOW HOT WATER SYSTEM
INT	SECURITY INTERCOM & KEYPAD ACCESS
LED	DENOTES CONCEALED LED LIGHTING STRIP UNDER.
	HAVIT LIGHTING - 4.8w 1P67 12v DC 4000K LED STRIP PART NUMBER: HV9723-IP67-60-4K
LIN	LINEN CUPBOARD
Р	PANTRY
RAH	ROOF ACCESS HATCH
REF	REFRIDGERATOR PROVISION
RWH	COLORBOND STEEL RAINWATER HEAD
W/D	WASHER & DRYER PROVISION.
SB	SWITCHBOARD
SD	CEILING MOUNTED SMOKE ALARM
SHED	FLATROOF SHED BY EASY SHED. 2.22m w x 0.78m d x 1.82m h - STEEL, SLATE GREY. MODEL: EF-S2308
SKY	SKYLIGHT LOCATION OVER
SN	STUDY NOOK

ELOOD ADEAS

TOTAL - 11 STOREY AVENUE, HAMPTON.	SIZE	SIZE	PERCENT
	(m²)	(Sq)	(%)
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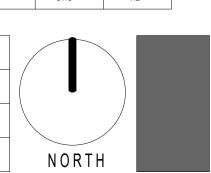


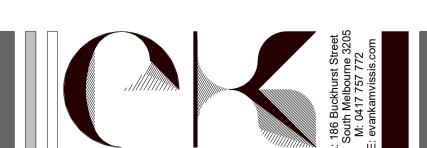
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REV	DATE	DETAILS
*	11/06/2021	ISSUE FOR BUILDING PERMIT

SHEET NAME
FRONT GARDEN PLAN

DATE: JULY 2020
SCALE: 1:50 AT A1 / 1:100 AT A3
DWG No.: 2013
SHEET No.: A108 REVISION:



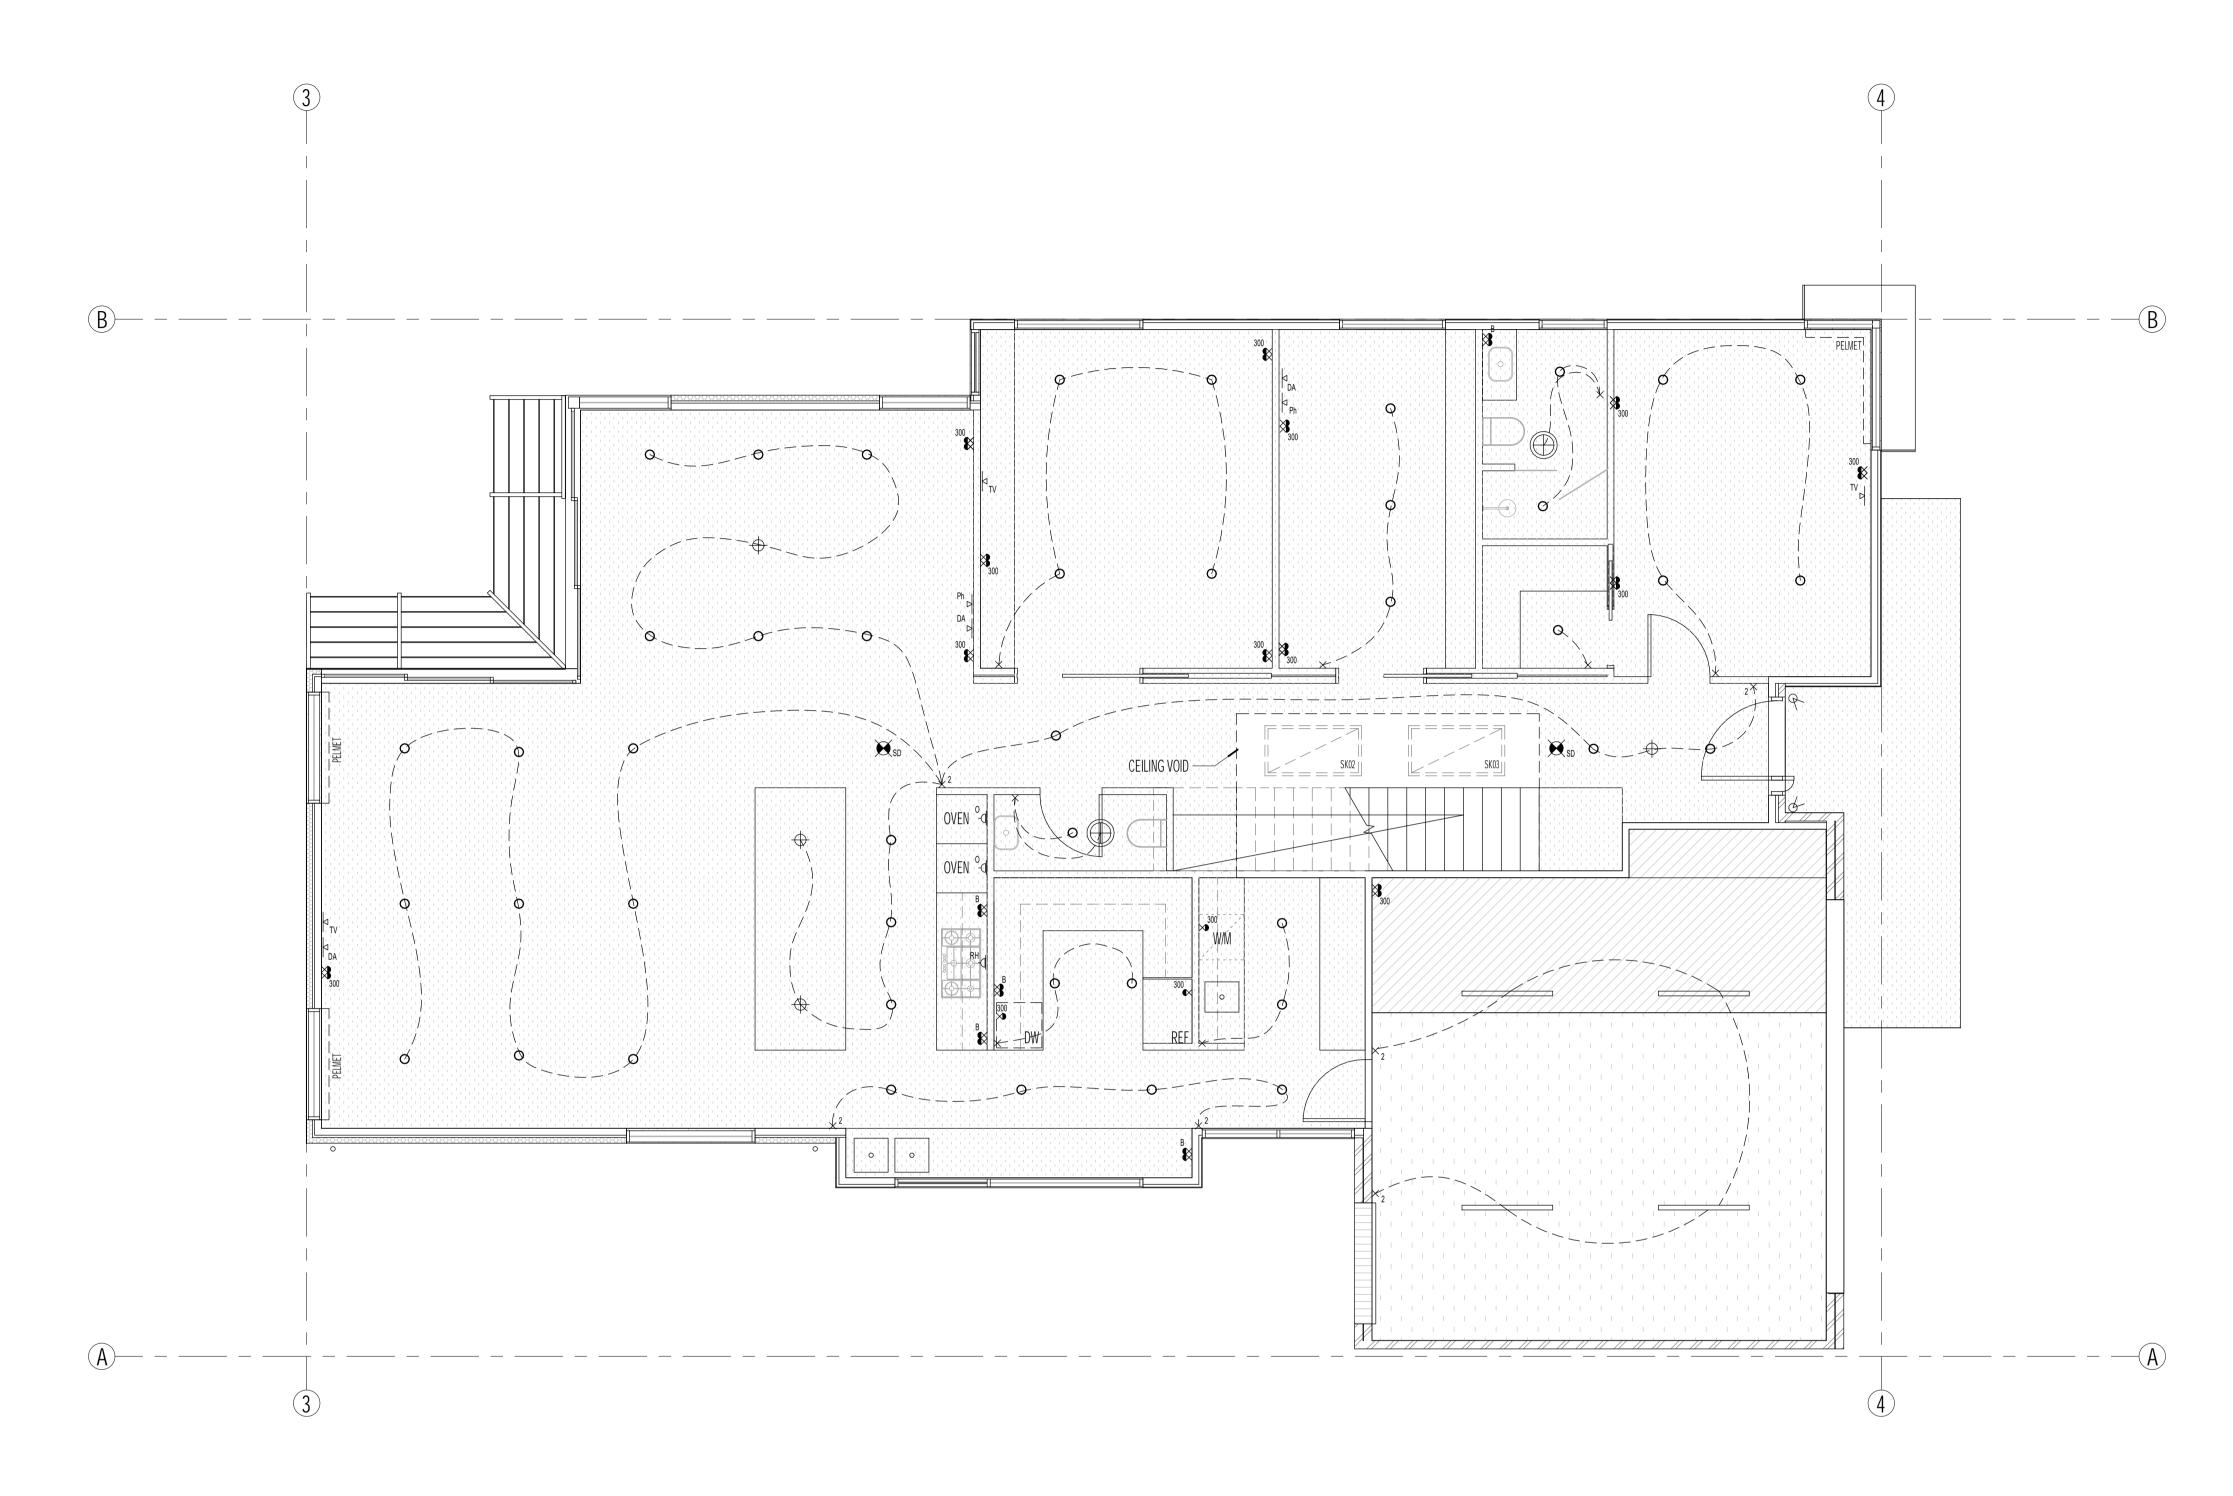


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SD- DENOTES HARDWIRED AND INTERCONNECTED SMOKE DETECTORS COMPLYING WITH AS3786-1993, CEILING MOUNTED WHERE INDICATED ON DESIGNER'S DRAWINGS.



LIGHTING CALCULATION

11 STOREY AVENUE, HAMPTON	AREA (m²)	MAX ILLUMINATION POWER DENSITY (W/m²)	TOTAL MAX WATTS	
ENTRY PORCH	1.5	4 W/m ²	6 Watts	
GROUND FLOOR	183.8	5 W/m ²	919 Watts	
GARAGE	40.2	5 W/m ²	201 Watts	
FIRST FLOOR	115.4	5 W/m ²	577 Watts	
PROPOSED DWELLING TO HAVE NO MORE THAN MAXIMUM ALLOWABLE WATTAGE TO TOTAL 1703 Watts				
COMPLY WITH BCA.				

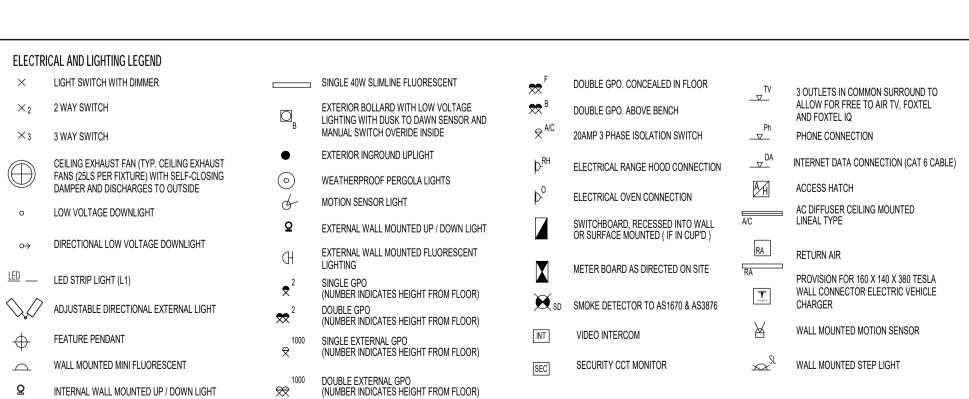CEILING LEGEND

1 1 1 1 1 1	2700mm HIGH CEILING	3000mm HIGH CEILING	
	3150mm HIGH CEILING	3200mm HIGH CEILING	





☑ INTERNAL WALL MOUNTED UP / DOWN LIGHT




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REV	DATE	DETAILS
*	11/06/2021	ISSUE FOR BUILDING PERMIT

	SHEET NAME
	GROUND FLOOR RCP
ı	

PROJECT					
PROPOSED RESIDENTIAL DEVELOPMENT AT					
11 STOREY AVENUE, HAMPTON					
CLIENT NAME: CORINNA & BOB NEILL					

DATE:	JULY 2020
SCALE:	1:50 AT A1 / 1:100 AT A3
DWG No.:	2013
SHEET No.	: A109 REVISION:

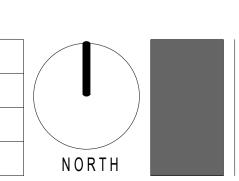

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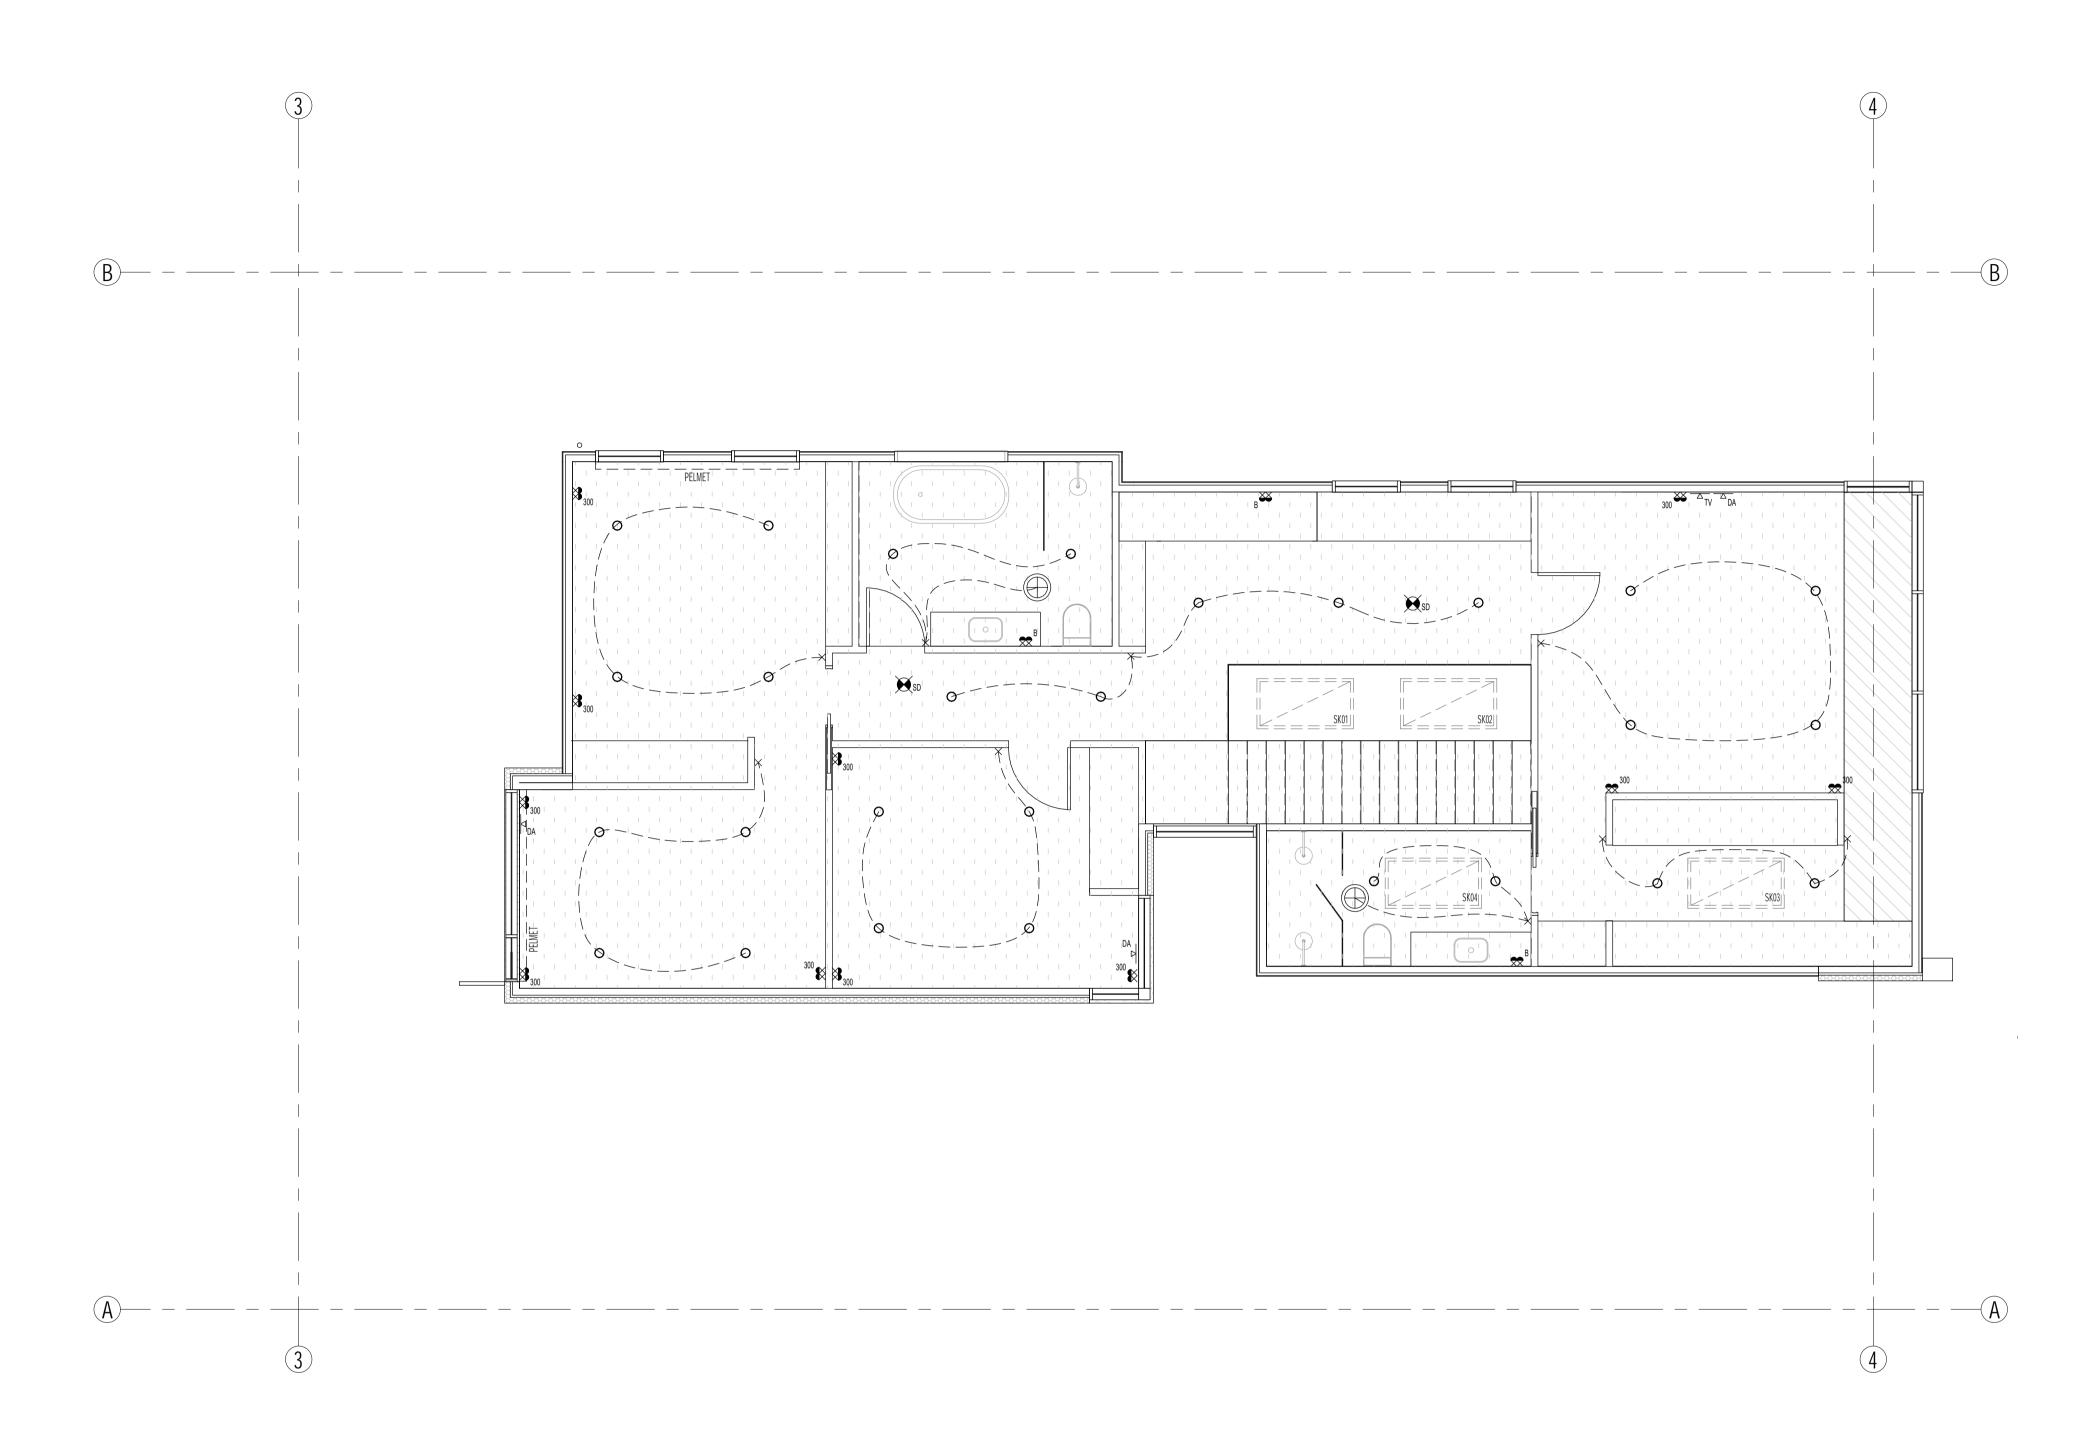
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	ELECTRIC	CAL AND LIGHTING LEGEND						
	×	LIGHT SWITCH WITH DIMMER		SINGLE 40W SLIMLINE FLUORESCENT	₹	DOUBLE GPO. CONCEALED IN FLOOR	TV	3 OUTLETS IN COMMON SURROUND TO
	\times_2	2 WAY SWITCH		EXTERIOR BOLLARD WITH LOW VOLTAGE LIGHTING WITH DUSK TO DAWN SENSOR AND	₹ B	DOUBLE GPO. ABOVE BENCH		ALLOW FOR FREE TO AIR TV, FOXTEL AND FOXTEL IQ
	\times_3	3 WAY SWITCH	В	MANUAL SWITCH OVERIDE INSIDE	\$ A/C	20AMP 3 PHASE ISOLATION SWITCH	Ph _▽	PHONE CONNECTION
		CEILING EXHAUST FAN (TYP. CEILING EXHAUST	•	EXTERIOR INGROUND UPLIGHT	D-RH	ELECTRICAL RANGE HOOD CONNECTION	DA	INTERNET DATA CONNECTION (CAT 6 CABLE)
(FANS (25LS PER FIXTURE) WITH SELF-CLOSING DAMPER AND DISCHARGES TO OUTSIDE	<u></u>	WEATHERPROOF PERGOLA LIGHTS	Þ ₋₀	ELECTRICAL OVEN CONNECTION	AH	ACCESS HATCH
	0	LOW VOLTAGE DOWNLIGHT	6	MOTION SENSOR LIGHT	ν —	ELECTRICAL OVEN CONNECTION	A/C	AC DIFFUSER CEILING MOUNTED
		DIDECTIONAL LOWING TAGE DOWN IN	Ω	EXTERNAL WALL MOUNTED UP / DOWN LIGHT		SWITCHBOARD, RECESSED INTO WALL OR SURFACE MOUNTED (IF IN CUP'D)	A/C	LINEAL TYPE
	\leftrightarrow	DIRECTIONAL LOW VOLTAGE DOWNLIGHT	H	EXTERNAL WALL MOUNTED FLUORESCENT LIGHTING		METER ROADR AS RIDESTER ON SITE	RA	RETURN AIR
Ī	<u>ED</u>	LED STRIP LIGHT (L1)	₹ ²	SINGLE GPO		METER BOARD AS DIRECTED ON SITE	RA	PROVISION FOR 160 X 140 X 380 TESLA WALL CONNECTOR ELECTRIC VEHICLE
<		ADJUSTABLE DIRECTIONAL EXTERNAL LIGHT	☆ ²	(NUMBER INDICATES HEIGHT FROM FLOOR) DOUBLE GPO	€ SD	SMOKE DETECTOR TO AS1670 & AS3876		CHARGER
	-	FEATURE PENDANT	1000	(NUMBER INDICATES HEIGHT FROM FLOOR) SINGLE EXTERNAL GPO	INT	VIDEO INTERCOM	\bowtie	WALL MOUNTED MOTION SENSOR
	Ψ Ω	WALL MOUNTED MINI FLUORESCENT	₹ 1000	(NUMBER INDICATES HEIGHT FROM FLOOR)	[050]	SECURITY CCT MONITOR	xx SL	WALL MOUNTED STEP LIGHT
		WALE INCOMED INITIAL LOCALEDOCIAL	1000	DOUBLE EXTERNAL CRO	SEC	SECONITY OUT MONITOR	X	WALL MODITED OTEL CIOITI


LIGHTING CALCULATION


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COMPLY WITH BCA.				

CEILING LEGEND

1 1 1 1 1 1	2700mm HIGH CEILING	3000mm HIGH CEILING
	3150mm HIGH CEILING	3200mm HIGH CEILING



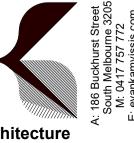

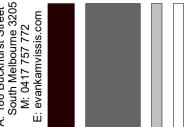

☑ INTERNAL WALL MOUNTED UP / DOWN LIGHT

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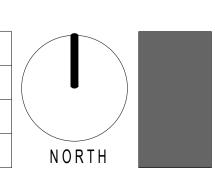
DOUBLE EXTERNAL GPO
(NUMBER INDICATES HEIGHT FROM FLOOR)

REV	DATE	DETAILS
*	11/06/2021	ISSUE FOR BUILDING PERMIT
	1	

SHEET NAME		
FIRST FLOOR RCP		

PROJECT
PROPOSED RESIDENTIAL DEVELOPMENT AT
11 STOREY AVENUE, HAMPTON
CLIENT NAME: CORINNA & BOB NEILL

DATE:	JULY 2020
SCALE:	1:50 AT A1 / 1:100 AT A3
DWG No.:	2013
SHEET No.	: A110 REVISION:



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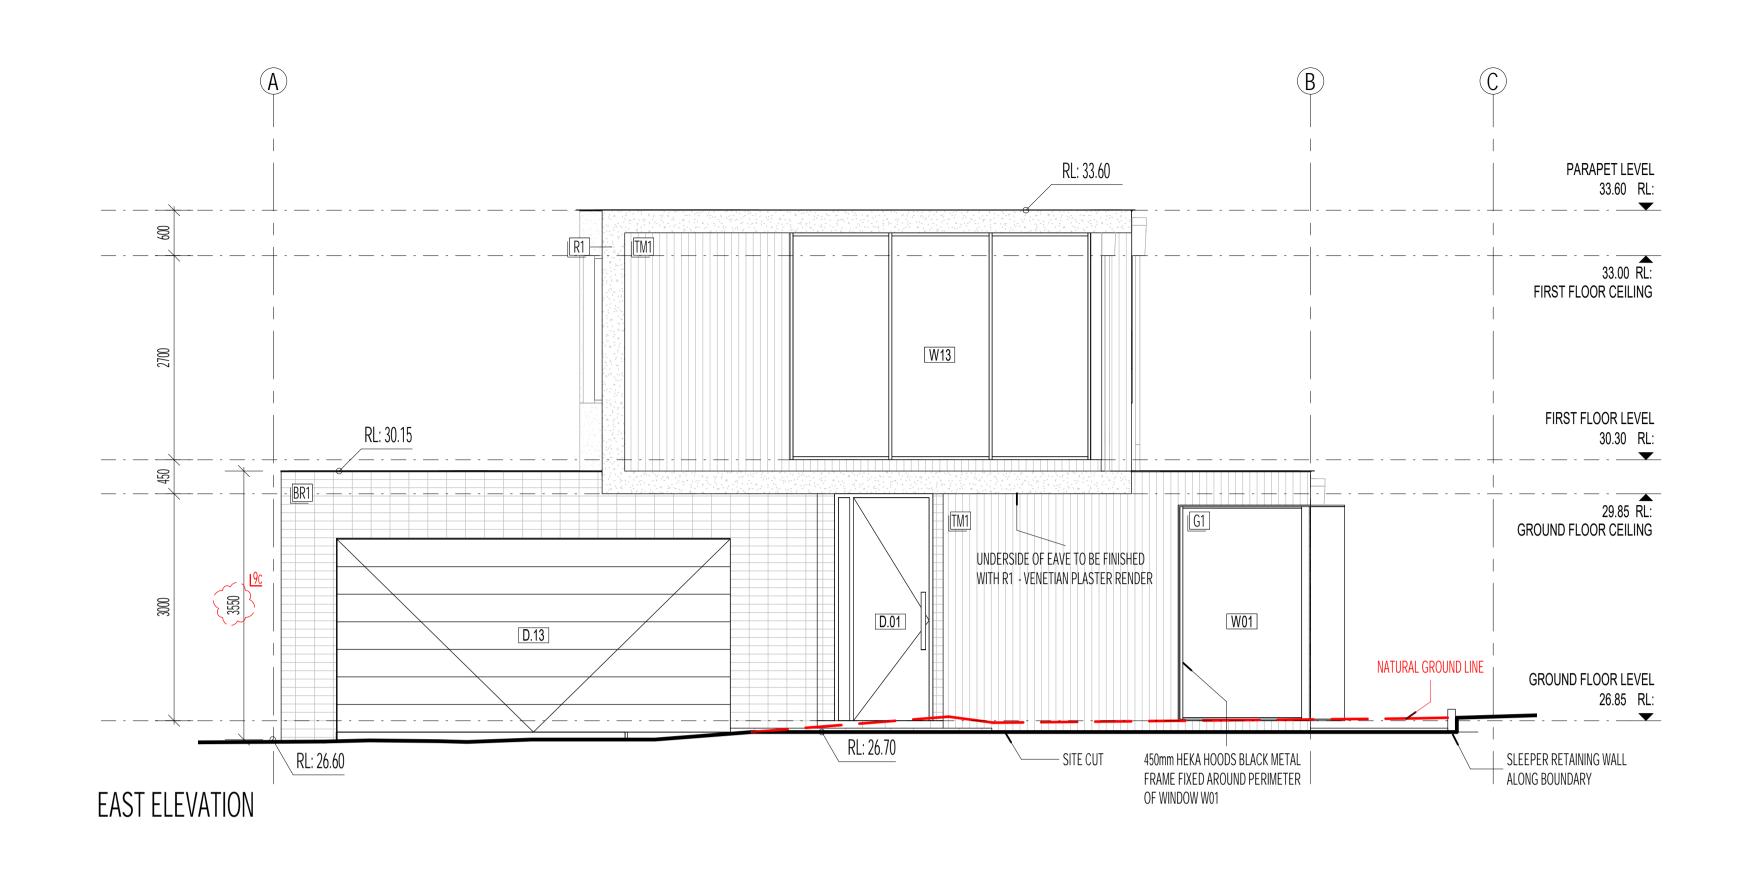
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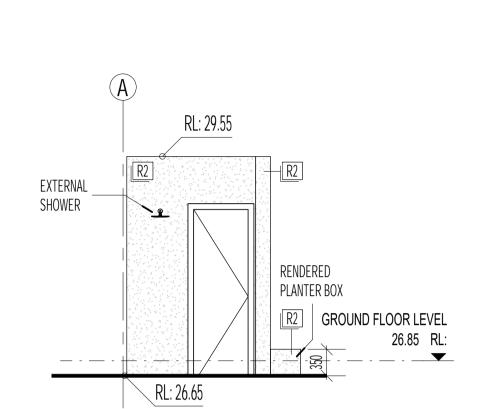
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POWDER / SAUNA EAST ELEVATION

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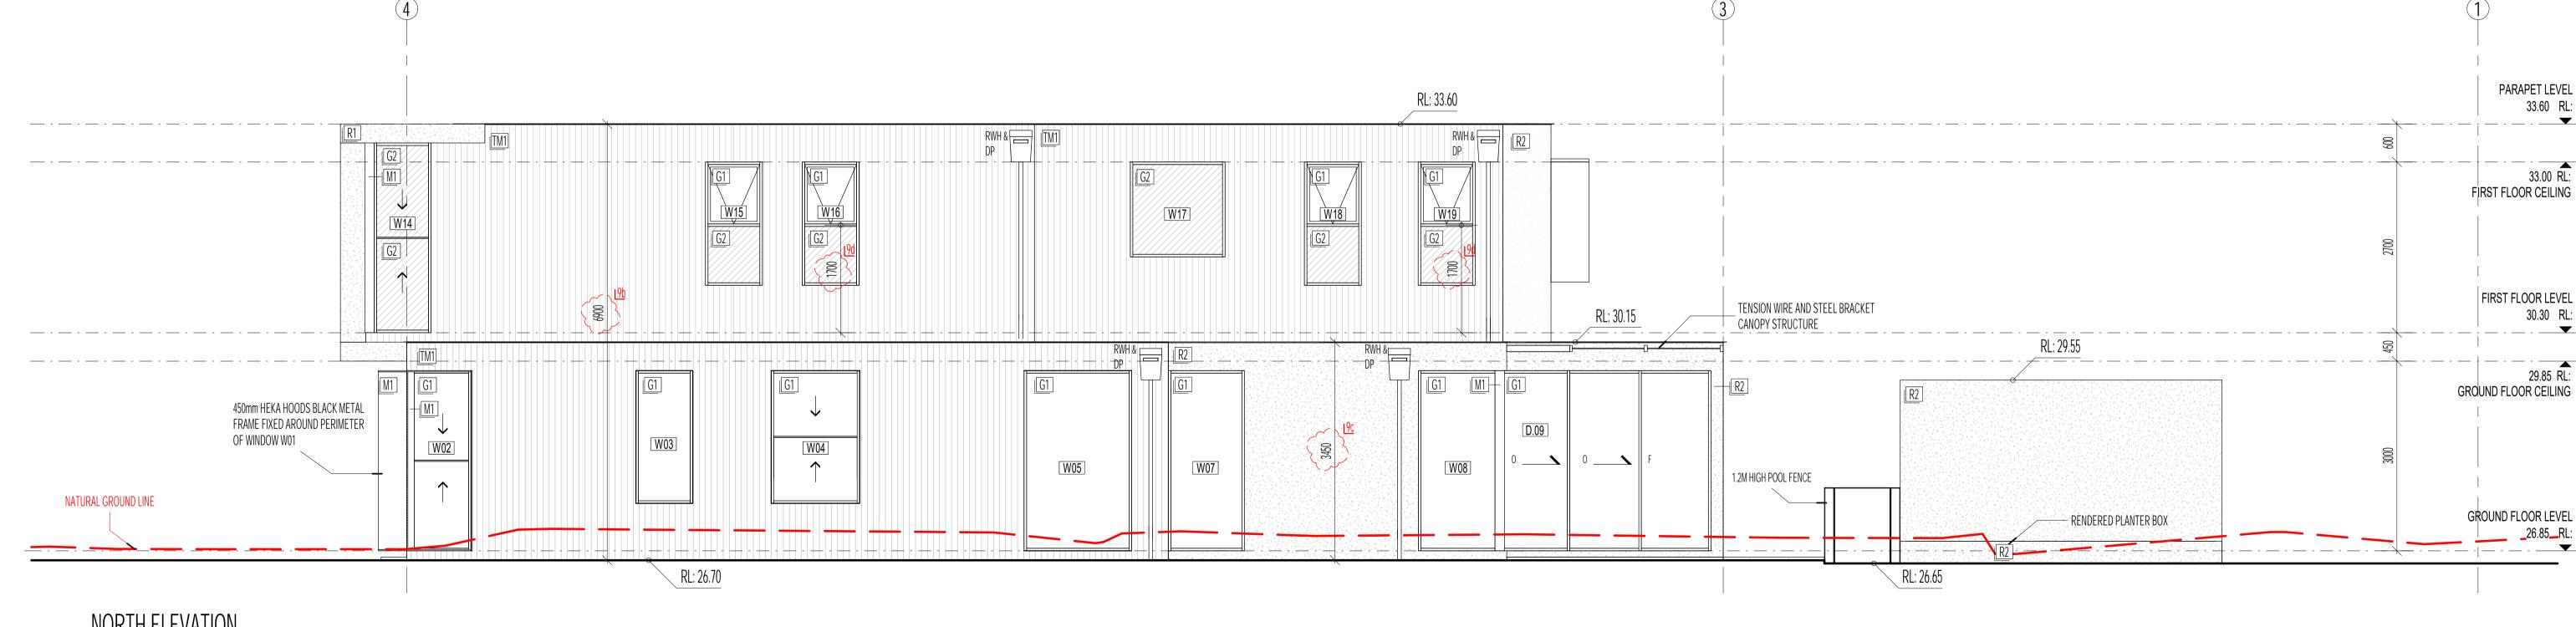
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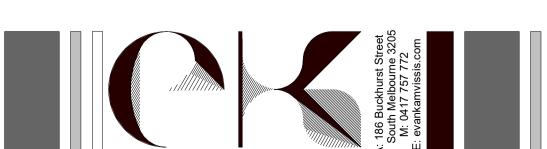
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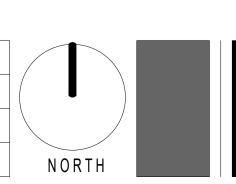



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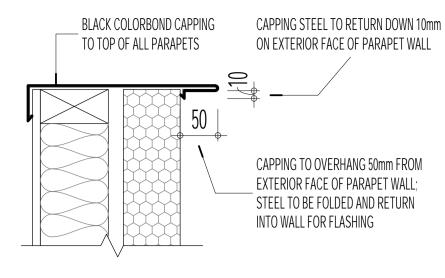
REV	DATE	DETAILS
*	11/06/2021	ISSUE FOR BUILDING PERMIT

SHEET NAME PROJECT NORTH & EAST ELEVATIONS PROPOSED RESIDENTIAL DEVELOPMENT AT 11 STOREY AVENUE, HAMPTON CLIENT NAME: CORINNA & BOB NEILL


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PARAPET CAPPING DETAIL 1:5 AT A1 / 1:10 AT A3



POWDER / SAUNA WEST ELEVATION

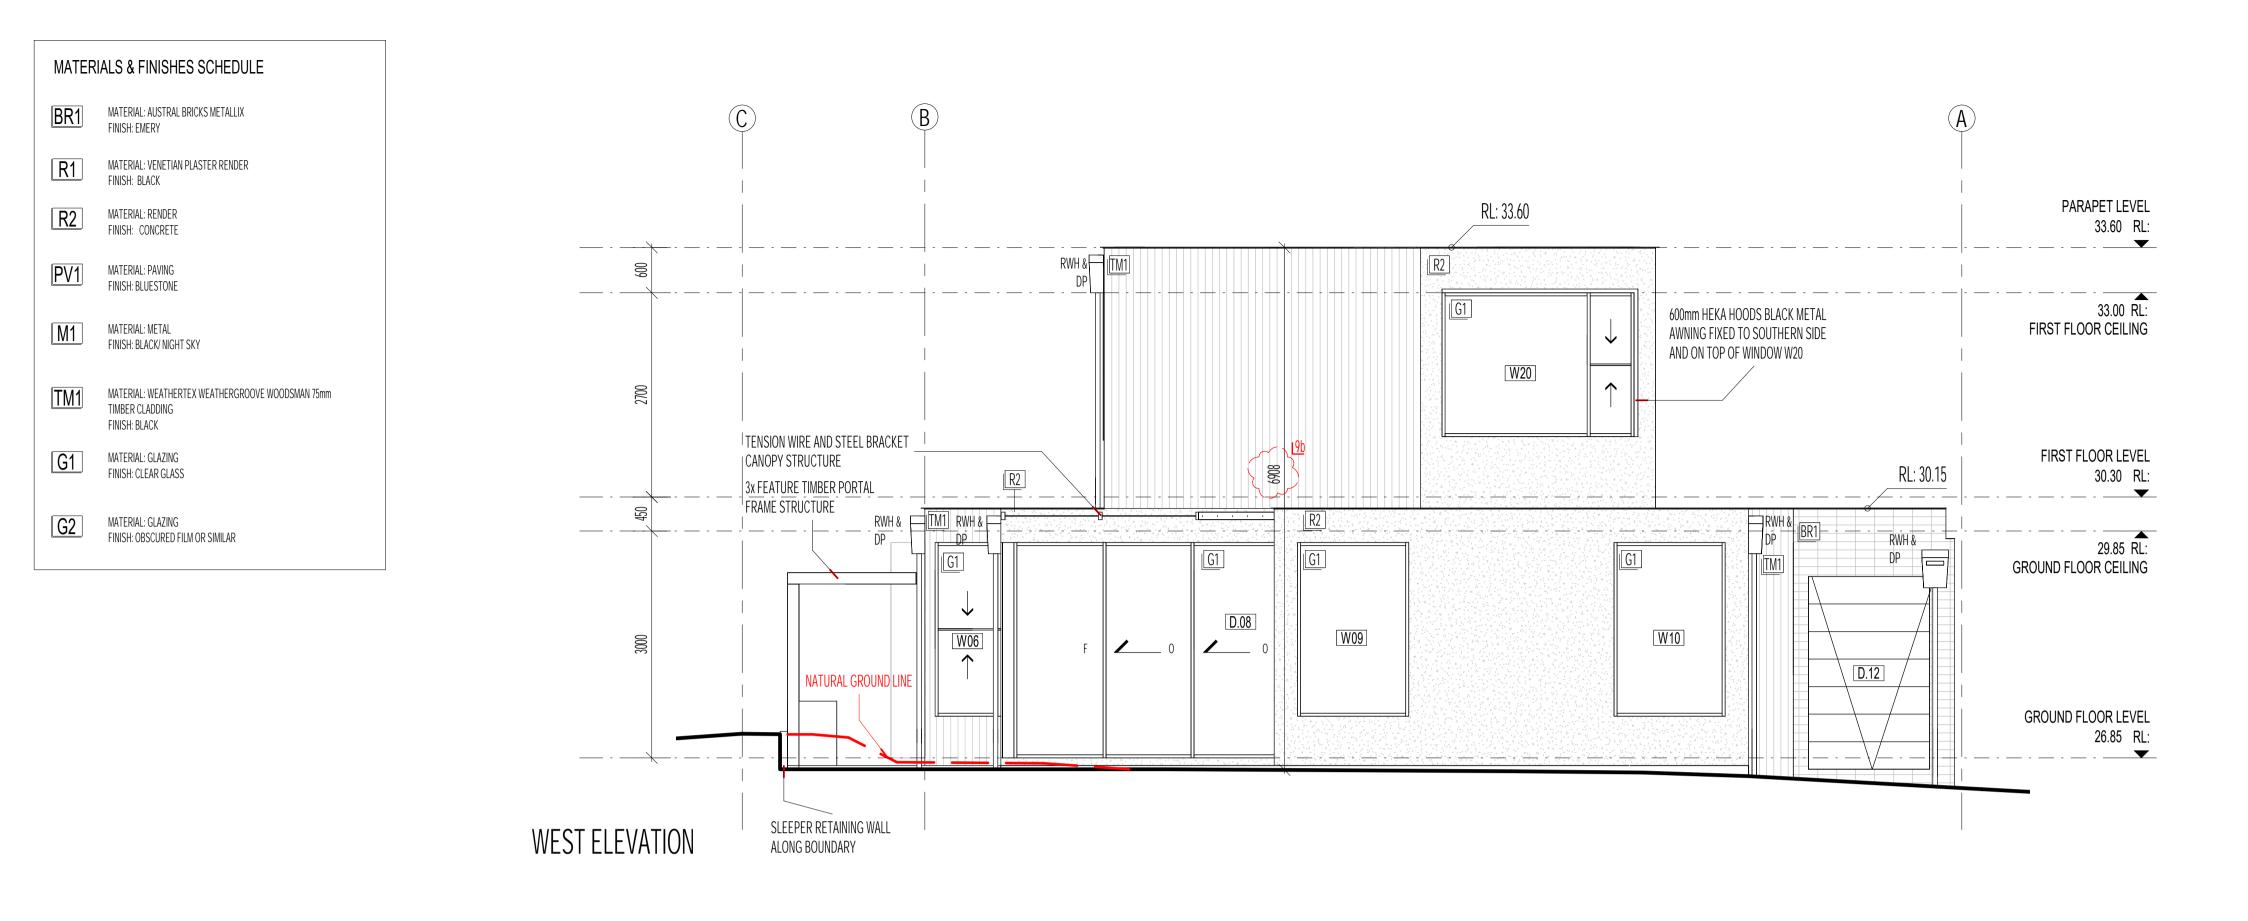ARCHITECTURAL GENERAL NOTES

THESE DRAWINGS SHALL BE READ IN CONJUNCTION WITH ALL RELEVANT STRUCTURAL AND ALL OTHER CONSULTANTS DRAWINGS/DETAILS AND WITH ANY OTHER WRITTEN INSTRUCTIONS ISSUED IN THE COURSE OF THE CONTRACT.

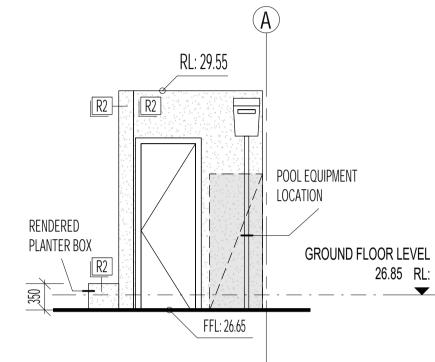THE BUILDER SHALL TAKE ALL THE STEPS NECESSARY TO ENSURE THE STABILITY AND GENERAL WATER TIGHTNESS OF NEW AND/OR EXISTING STRUCTURES DURING ALL

THE OWNER/BUILDER, SUBCONTRACTOR SHALL VERIFY ALL DIMENSIONS, LEVELS, SETBACKS, SPECIFICATIONS AND ALL OTHER RELEVANT DOCUMENTATION PRIOR TO COMMENCING ANY WORKS OR ORDERING MATERIALS AND SHALL BE RESPONSIBLE FOR ENSURING THAT ALL BUILDING WORKS CONFORM TO THE BUILDING CODE OF AUSTRALIA, AUSTRALIAN STANDARDS, BUILDING REGULATIONS, LOCAL BY-LAWS & TOWN PLANNING REQUIREMENTS.

INSTALLATION OF ALL SERVICES SHALL COMPLY WITH THE RESPECTIVE SUPPLY AURTHORITIES REQUIREMENTS.

THE APPROVAL BY THIS OFFICE OF A SUBSTITUTE MATERIAL, WORK PRACTICE, VARIATION OR THE LIKE IS NOT AUTHORIZATION FOR THE USE OR A CONTRACT VARIATION. ANY SAID VARIATIONS MUST BE ACCEPTED BY ALL PARTIES TO THE AGREEMENT AND WHERE APPLICABLE THE RELEVANT BUILDING SURVEYOR PRIOR TO IMPLEMENTING THE SAID VARIATION.


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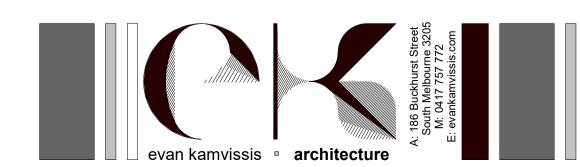
REPORT ALL DISCREPANCIES TO THIS OFFICE FOR CLARIFICATION AND APPROVAL IN WRITING.

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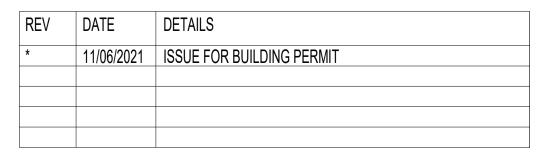
)TE:

- ALL EXPOSED STEEL WORK TO BE 316 MARINE GRADE STAINLESS STEEL
 UNLESS APPROVED OTHERWISE BY CLIENT.
- ALL WATERPROOFING SYSTEMS TO COMPLY WITH AS 3420 / AS 1562 / AS 2904 / SAA HB39
- EXPANSION JOINTS AT APPROPRIATE / REQUIRED LOCATION IN ACCORDANCE WITH AS3600 / 2009 IN LINE WITH WALL AND WINDOW JOINTS WHERE POSSIBLE.



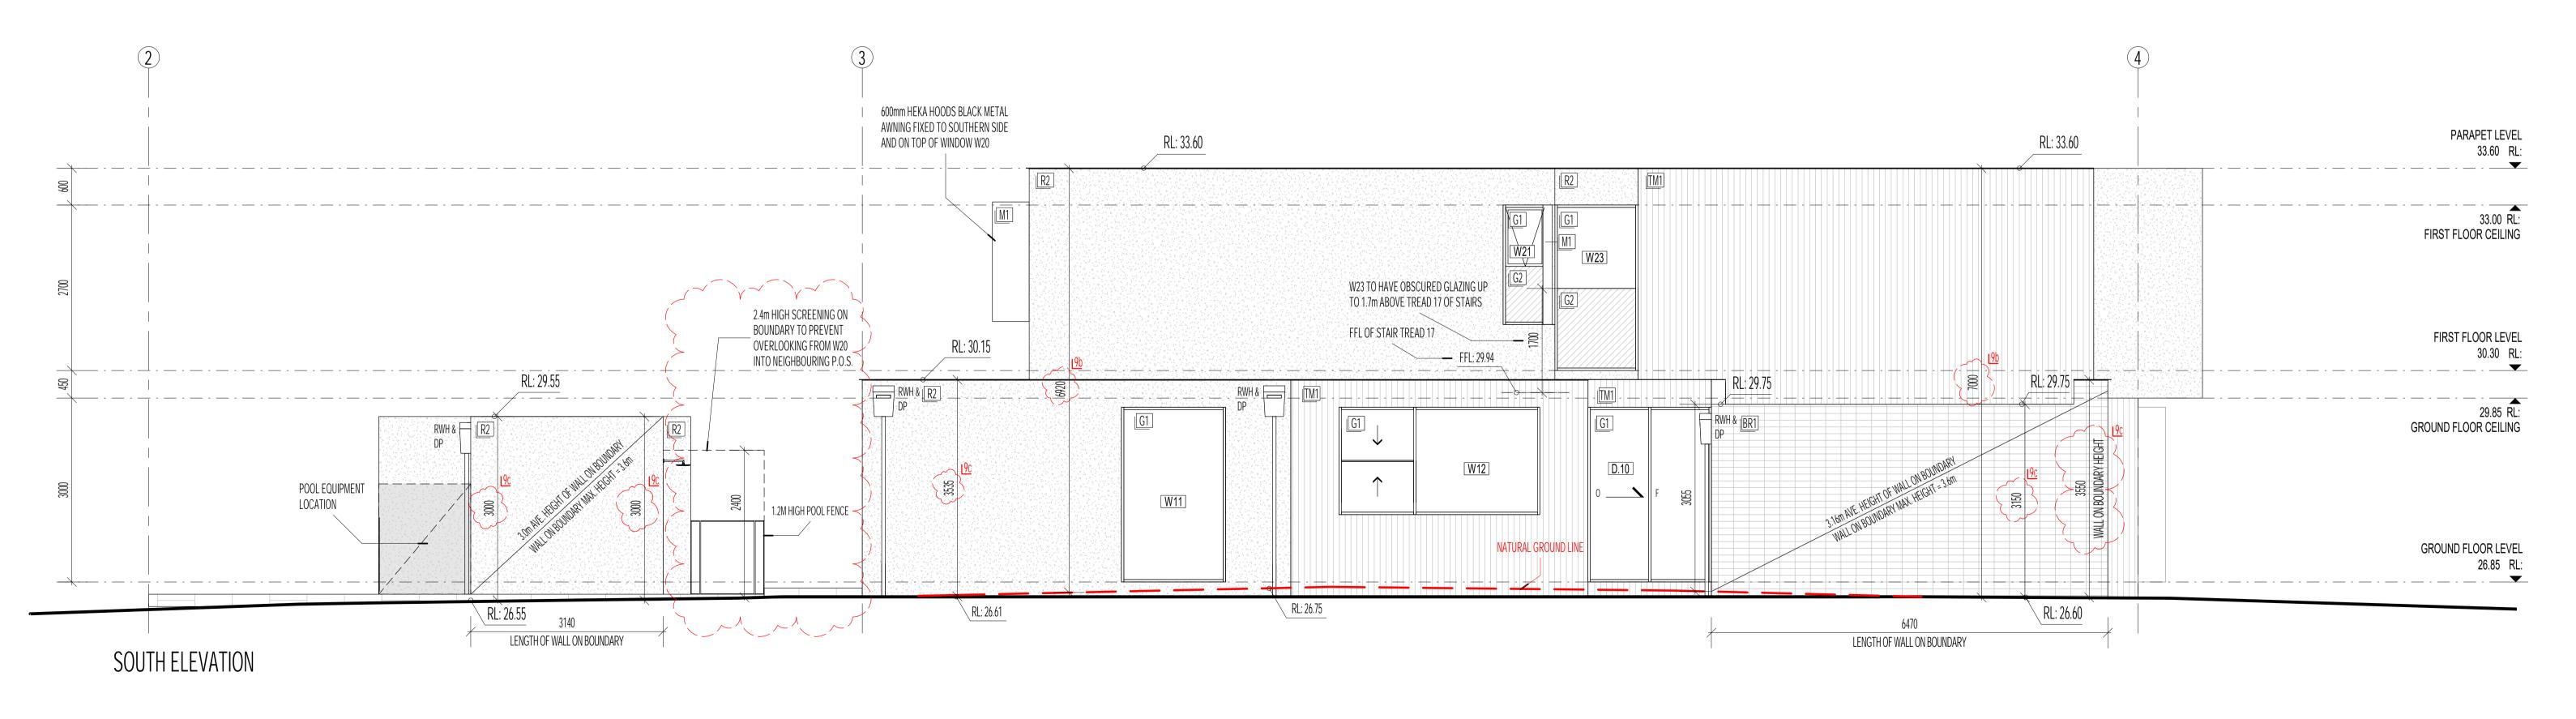

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SHEET NAME

SOUTH & WEST ELEVATIONS

PROPOSED RESIDENTIAL DEVELOPMENT AT 11 STOREY AVENUE, HAMPTON


CLIENT NAME: CORINNA & BOB NEILL

DATE: JULY 2020

SCALE: 1:50 AT A1 / 1:100 AT A3

DWG No.: 2013

SHEET No.: A202 REVISION:

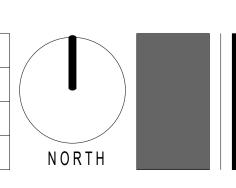

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STRUCTURAL AND ALL OTHER CONSULTANTS DRAWINGS/DETAILS AND WITH
ANY OTHER WRITTEN INSTRUCTIONS ISSUED IN THE COURSE OF THE

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LEVELS, SETBACKS, SPECIFICATIONS AND ALL OTHER RELEVANT
DOCUMENTATION PRIOT TO COMMENCING ANY WORKS OR ORDER

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REPORT ALL DISCREPANCIES TO THIS OFFICE FOR CLARIFICATION AND APPROVAL IN


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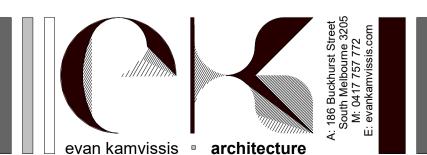
NOTE:

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ALL WATERPROOFING SYSTEMS TO COMPLY WITH AS 3420 / AS 1562 / AS 2904 / SAA HB39


EXPANSION JOINTS AT APPROPRIATE / REQUIRED LOCATION IN ACCORDANCE WITH AS3600 / 2009 IN LINE WITH WALL AND WINDOW JOINTS WHERE POSSIBLE.




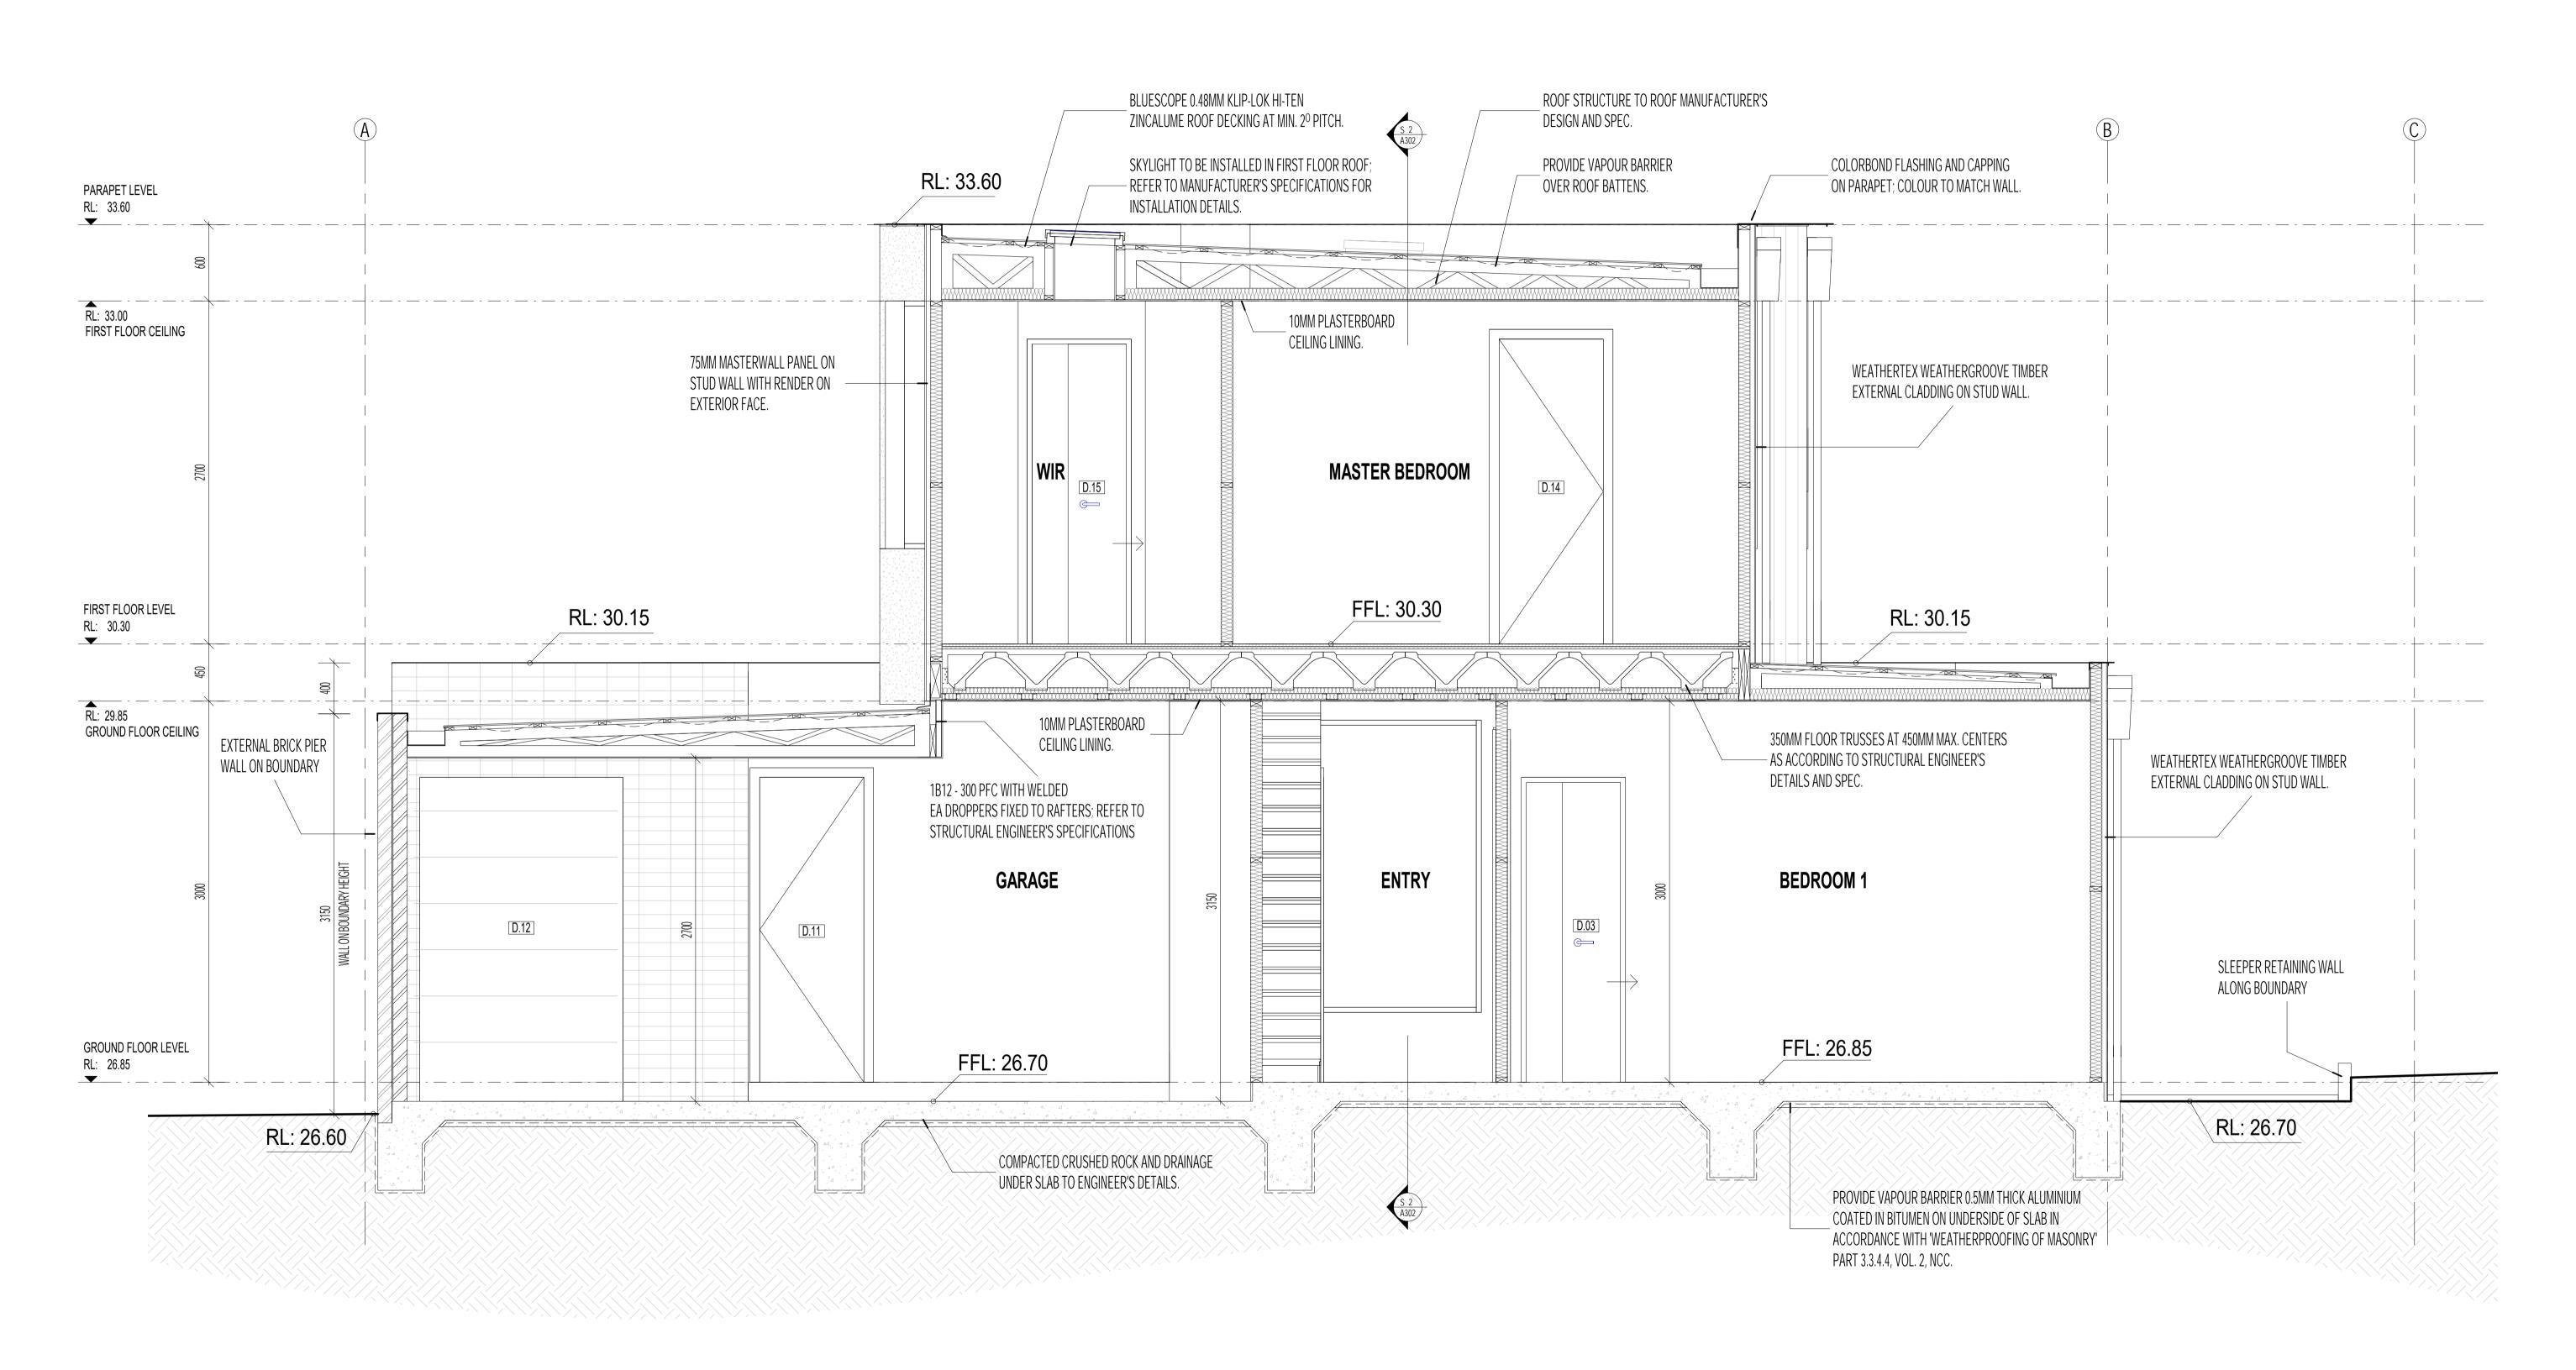



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REV	DATE	DETAILS
*	11/06/2021	ISSUE FOR BUILDING PERMIT



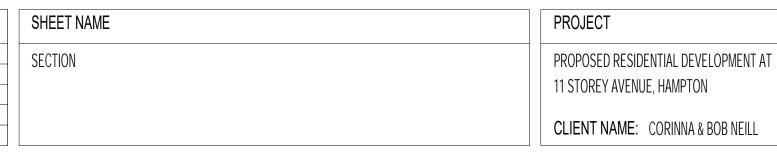

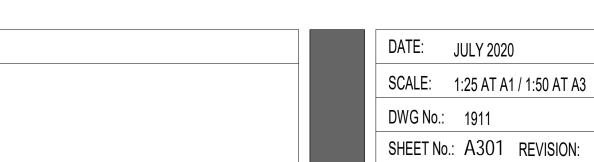

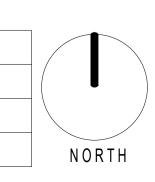
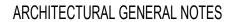
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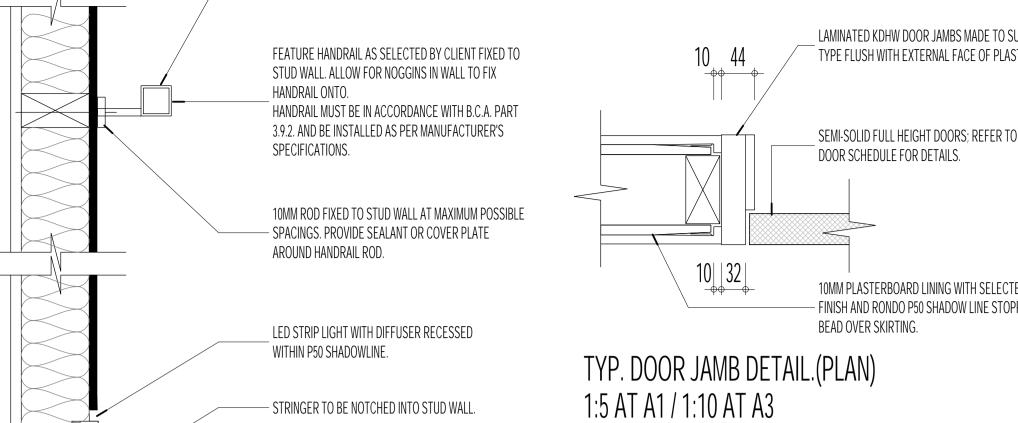
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- EXPANSION JOINTS AT APPROPRIATE / REQUIRED LOCATION IN ACCORDANCE WITH AS3600 / 2009 IN LINE WITH WALL AND WINDOW JOINTS WHERE



HARDWOOD TIMBER

FINISHED INTERNAL FLOOR.

50


- BLACK METAL HANDRAIL. SELECTED BY OWNER.

DRESSED TIMBER TREAD. SELECTED

TIMBER RISER AND TREADS TO BE SANDED

AND POLISHED. FINISH TO BE SELECTED

BY OWNER.

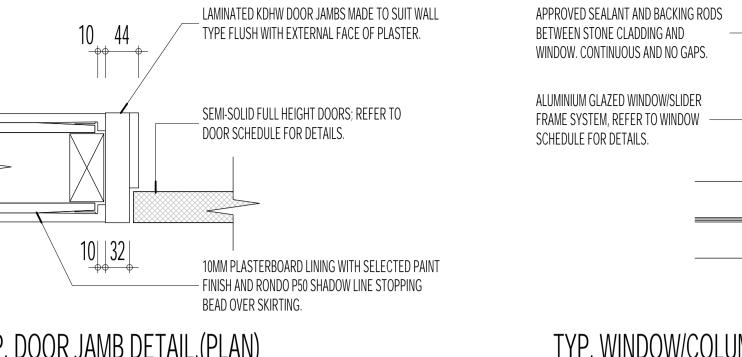


FLOOR TO INCREASE BY 40MM.


& SEAL WITH FLEXIBLE CAULKING.

SELECTED EXTERNAL TILE / PAVER TO GRADE

- AWAY FROM BUILDING UNDER DOOR SUBSILL

INTERNAL TYP. WINDOW/COLUMN DETAIL.(PLAN) 1:5 AT A1 / 1:10 AT A3

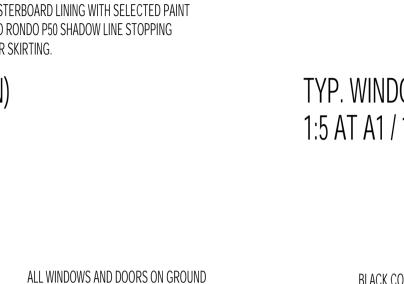

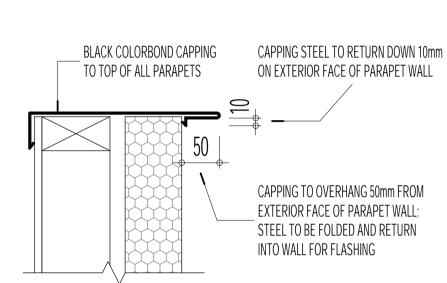


PAINT FINISH. REFER TO FINISHES

SCHEDULE FOR DETAILS.


STEEL COLUMN. REFER TO


STRUCTURAL ENGINEERS DETAILS.


PARAPET CAPPING DETAIL 1:5 AT A1 / 1:10 AT A3

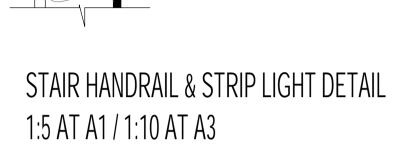




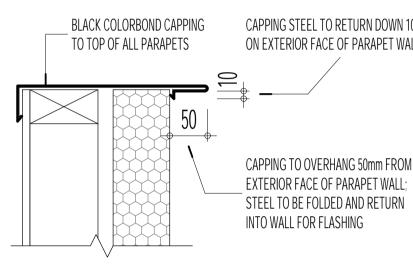

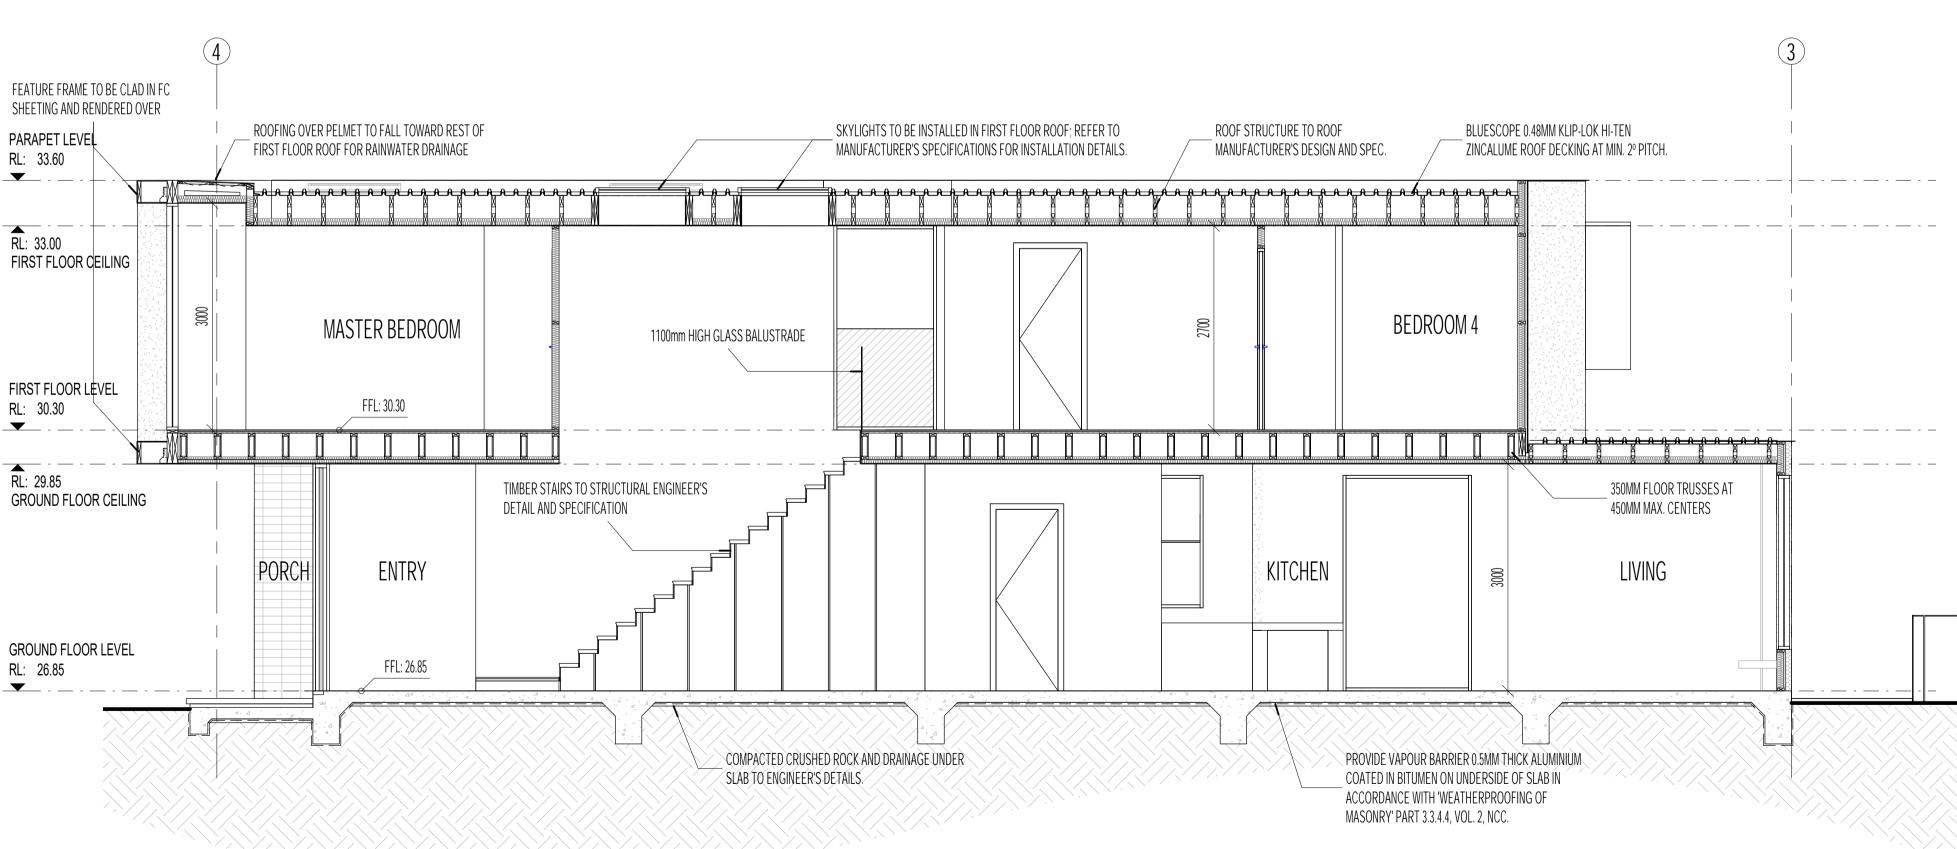

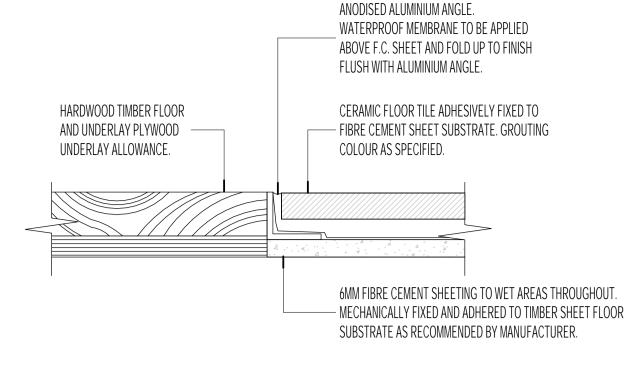


TYPICAL TILE TO TIMBER FLOORBOARD

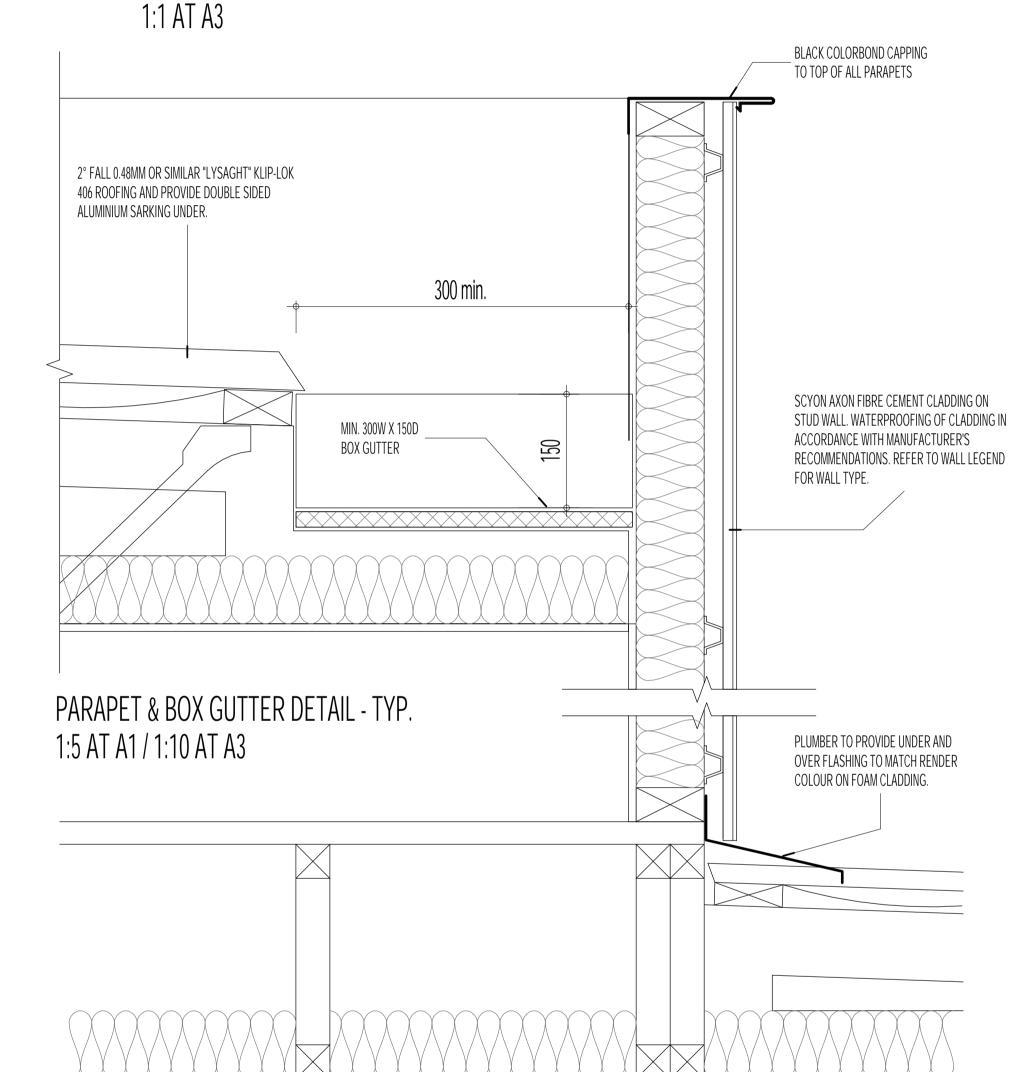

FOAM WALL & ROOF FLASHING DETAIL - TYP. 1:5 AT A1 / 1:10 AT A3

LONGITUDINAL SECTION 1:50 AT A1 / 1:100 AT A3



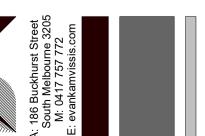



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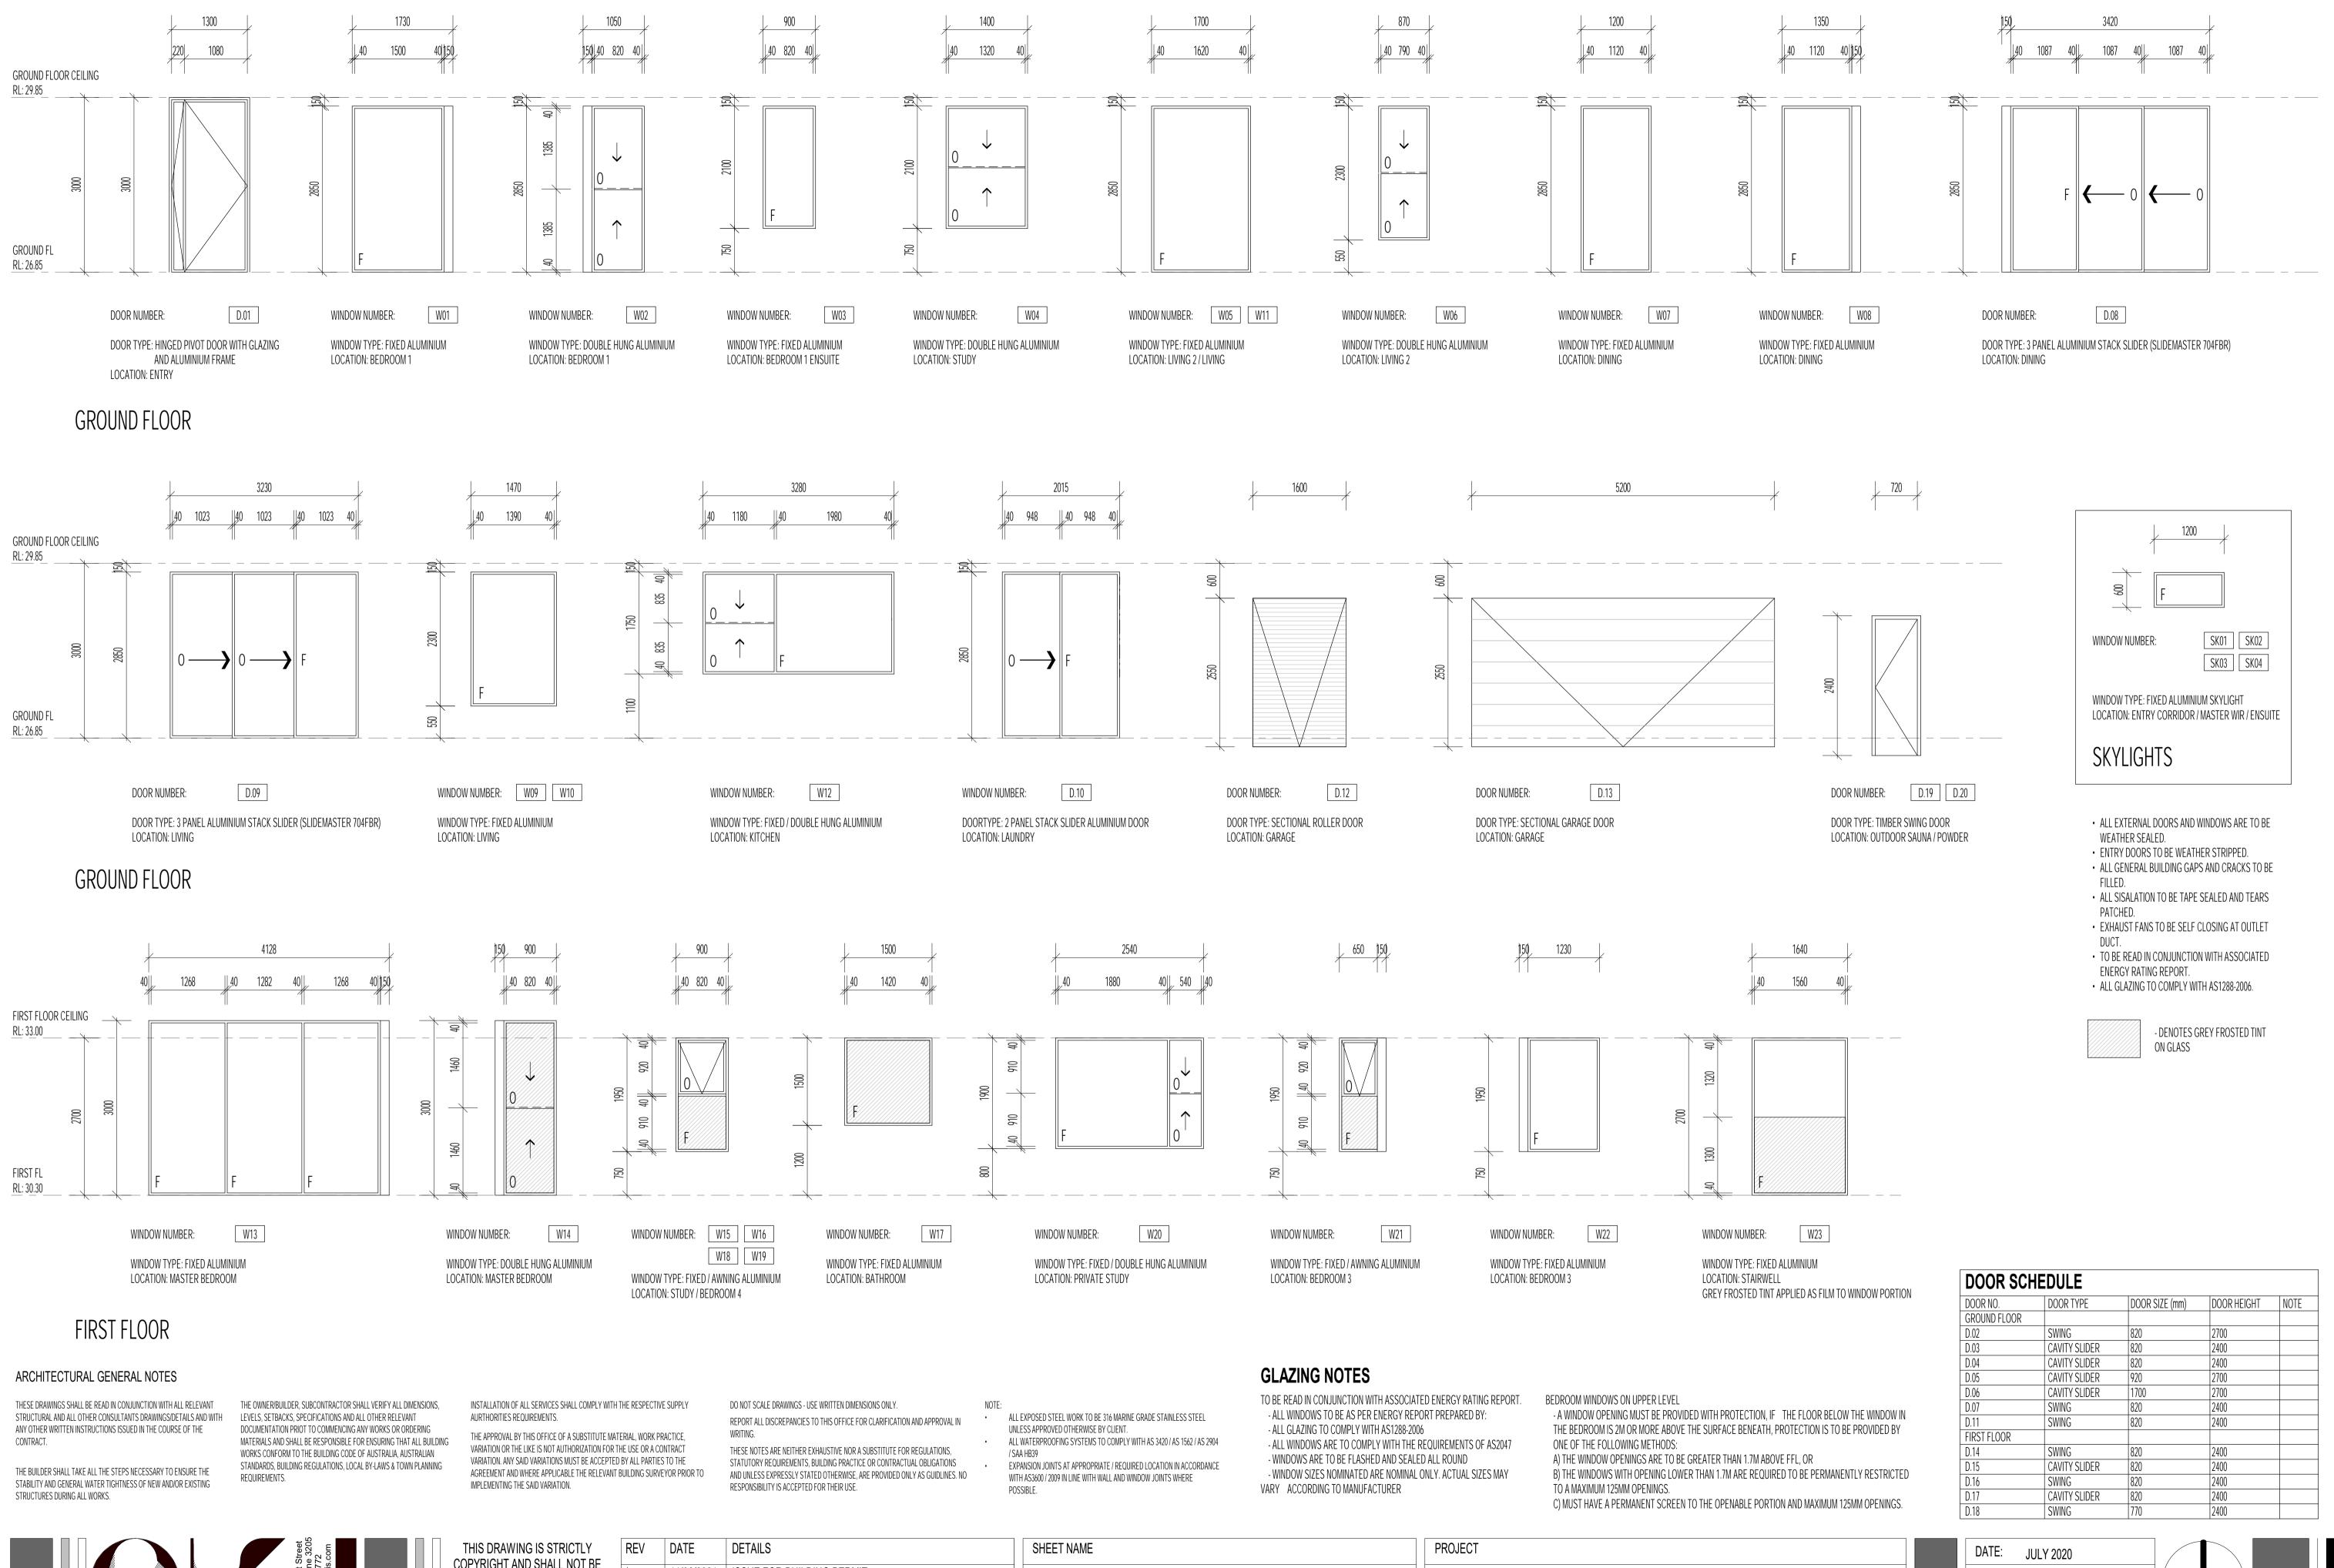
REV	DATE	DETAILS
*	11/06/2021	ISSUE FOR BUILDING PERMIT

SHEET NAME LONGITUDINAL SECTION + TYPICAL DETAILS

DATE:	02/01/21	
SCALE:	AS SPECIFIED	
DWG No.:	2013	\
SHEET No	o.: A302 REVISION:	




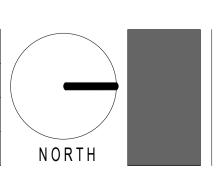

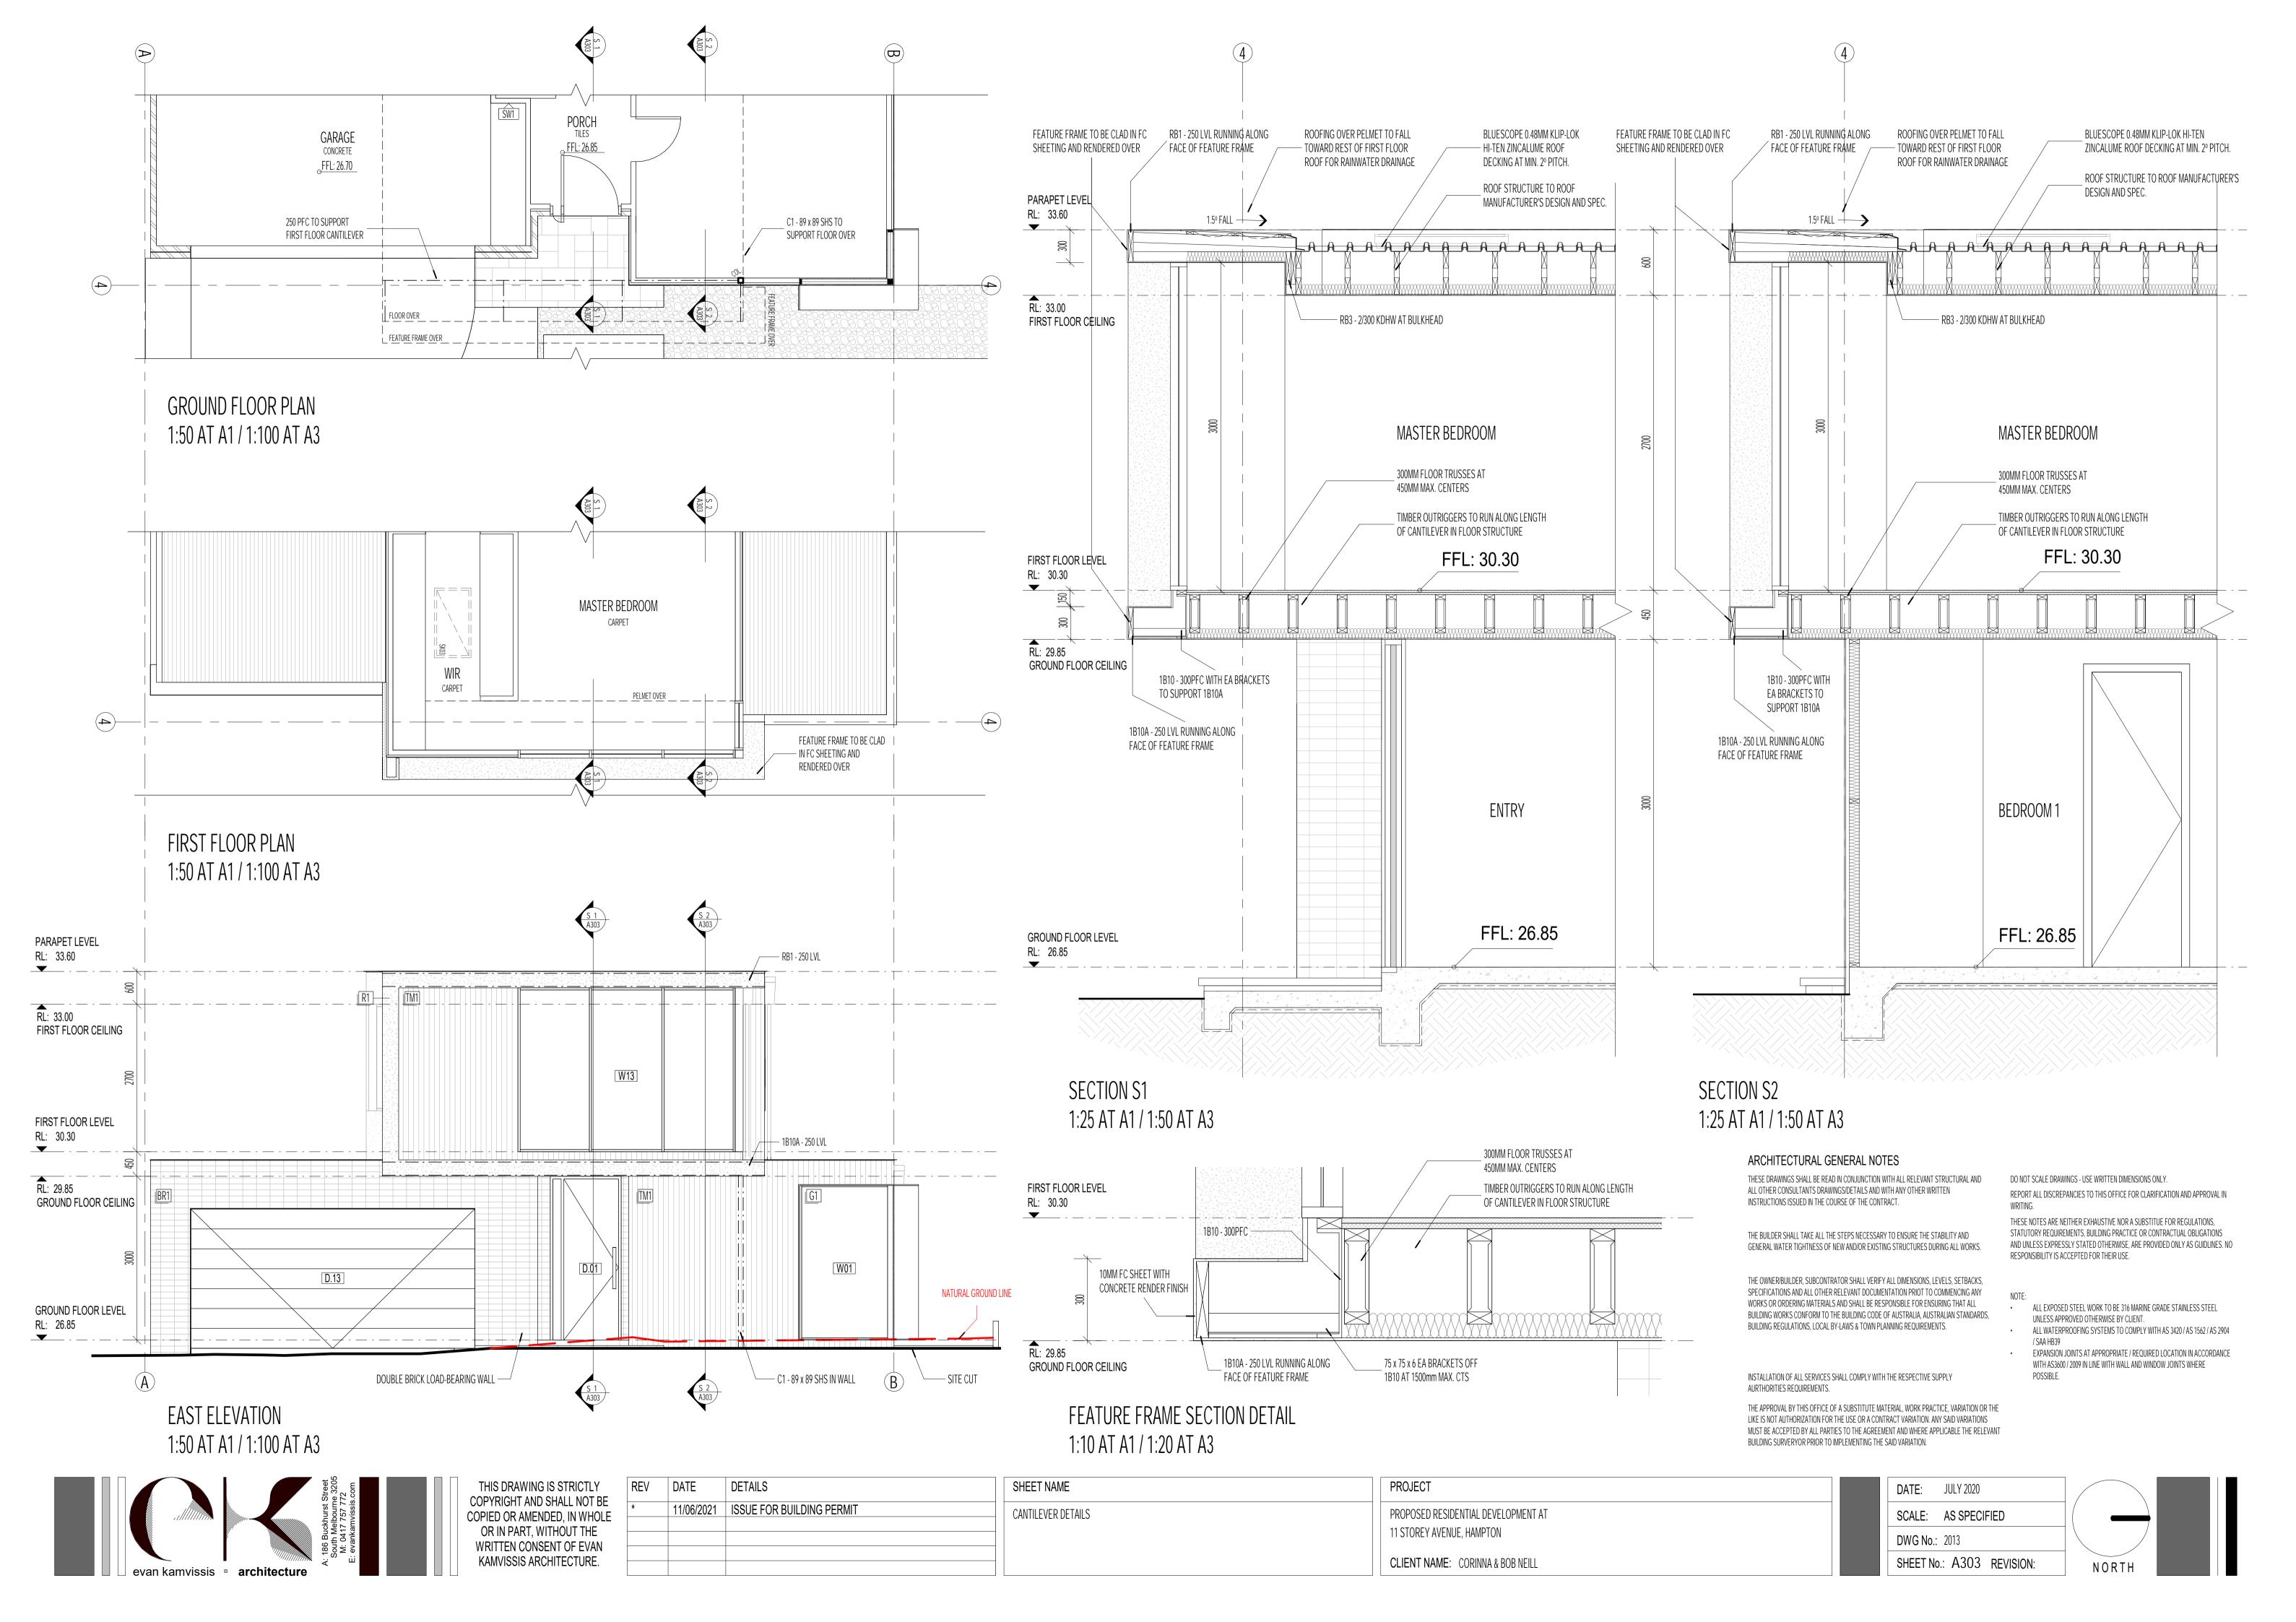



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WINDOW & DOOR SCHEDULE

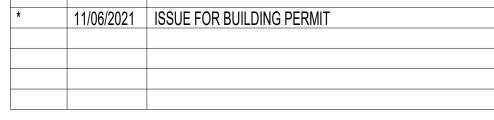PROPOSED RESIDENTIAL DEVELOPMENT AT 11 STOREY AVENUE, HAMPTON

CLIENT NAME: CORINNA & BOB NEILL

	DATE: JULY 2020	
ı	SCALE: 1:50 AT A1 / 1:100 AT A3	\rfloor (
ı	DWG No.: 2013	
	SHEET No.: A400 REVISION:	

