

1. Existing Floor Plan 1:100

Job No. A.Langdon Revision Drawn **GENERAL NOTES** Copyright © 2014 **Proposed Renovation & Addition to** DEMAND -ALL DIMENSIONS AND UNDERGROUND SERVICE LOCATIONS TO BE CHECKED ON SITE PRIOR TO COMMENCEMENT OF WORK. -DO NOT SCALE FROM DRAWINGS, IF IN DOUBT, CONFIRM THE DESIGNER. 26/07/2019 Date 208 **Existing Dwelling** Scale AS INDICATED @A3 -CONSTRUCTION TO COMPLY WITH: -NZS 3604:2011 -LOCAL TERRITORIAL AUTHORITY BYLAWS T. Gieck A D Drawing Number Drawing Title -LUCAL TERRITORIAL AUTHORITY BYLAWS -NEW ZEALAND BUILDING CODE -FLOOR LEVELS MAY VARY TO ALLOW FOR BEST USE OF CUT AND FILL. -THIS DOCUMENTATION AND ELECTRONIC DATA IS COPYRIGHT, AND REMAINS THE PROPERTY OF DEMAND LIMITED. Phone: 021915754 10 Belmont Terrace, Email: tim@demandltd.co.nz Website: demandltd.co.nz NZ. **Existing Floor Plan** 105 Remuera, Auckland 1050

26.07.2019 Client Approval
Revision Date Description

Domestic smoke alarms to be in accordance with NZBC F7 Smoke alarms shall be provided with a hush facility having a min. duration of 60 seconds. Smoke alarms shall be listed or approved by recognized authority as complying with at least one of: UL 217 CAN/ULC S531, AS 3786, BS

5446 Part 1.

26.07.2019

Date

Revision

Client Approval

Description

Stairs to comply with NZBC requirements Section D1/AS1: -Main Private: 280min Tread 190max Riser

Rusticated Weatherboards

90

3,020 3,495

- 80

2,115

2,955

2,295

067

1,165

8

106 90 Paint finish Rusticated Timber Weatherboards (with boxed corners) on 20mm H3.1 Cavity battens over Thermakraft Watergate Plus Building Paper on H1.2 timber framing @ 300crs. with Fibreglass Batt R2.2 Insulation.

External Wall Framing

90x45 H1.2 external timber framing (enclosed walls). 3.3m ceiling (max) Studs @ 300crs. Fix to Slab with M12 Propriety Fixings @ 900mm crs. First fixing to be within 300mm of corner.) Timber Weatherboard cladding on drained & ventilated cavity over Thermakraft Watergate plus Building wrap. R2.2 insulating batts to all external wall framing.

Internal Walls

90x45 KD H1.2 framing with studs @ 400mm crs to NZS3604:2011. Nog for all fittings, fixtures, linings, bracing panels & trims. DPC (malthoid) between bottom plate and conc. Generally line with 10mm standard Gib board (Aqualine to wet areas) stopped for selected paint finish (unless otherwise indicated). Refer also specific fitout dwgs & bracing schedule for specialist wall linings & requirements.

PROJECT INSULATION

Wall insulation to external walls = R2.2 Batts Ceiling insulation = R3.2 skillion Batts

LININGS

10mm Gib wall linings 10mm Gib Aqualine wall lining to wet-areas 13mm Gib Ceiling lining throughout - Install all as per Manufacturers specifications and installation instructions.

NOTE:

All lintels / beams on double studs. Unless Noted Otherwise

Connection Details

- Lintel To Stud Connections

- Bottom Plate to Slab / Timber Floor
- Wall Bracing Fixing Details
- Stud to Top Plate Fixings

Refer to Connection Details Page

Double Glazing

Refer to window manufacturers schedule. Window manufacturer

to check 'on-site' all window opening sizes prior to assembly

All glazing to comply with F2/AS1 1.0 Glazing NZS 4223.1 2008 and NZS 4223.2-2016 and 4223.3-2016. Glazing to wet areas safety glass as per table 1 NZS 4223.3-

Window openings to comply with F4/AS1 2.0 opening windows

(Openings less than 1.0m wide min. sill height to be 760mm


restrictor stay required with max. 100mm opening gap)

Wall Bracing: Refer to Bracing Plan by MEC Engineering

NOTE:

Plumbing System is as per NZS/ AS 3500 Refer to Plumbing Plan, Sheet 106

NOTE: New Foul Water System to comply to NZBC G13 AS1 & AS2. New Piped Services to comply with G10 NZBC

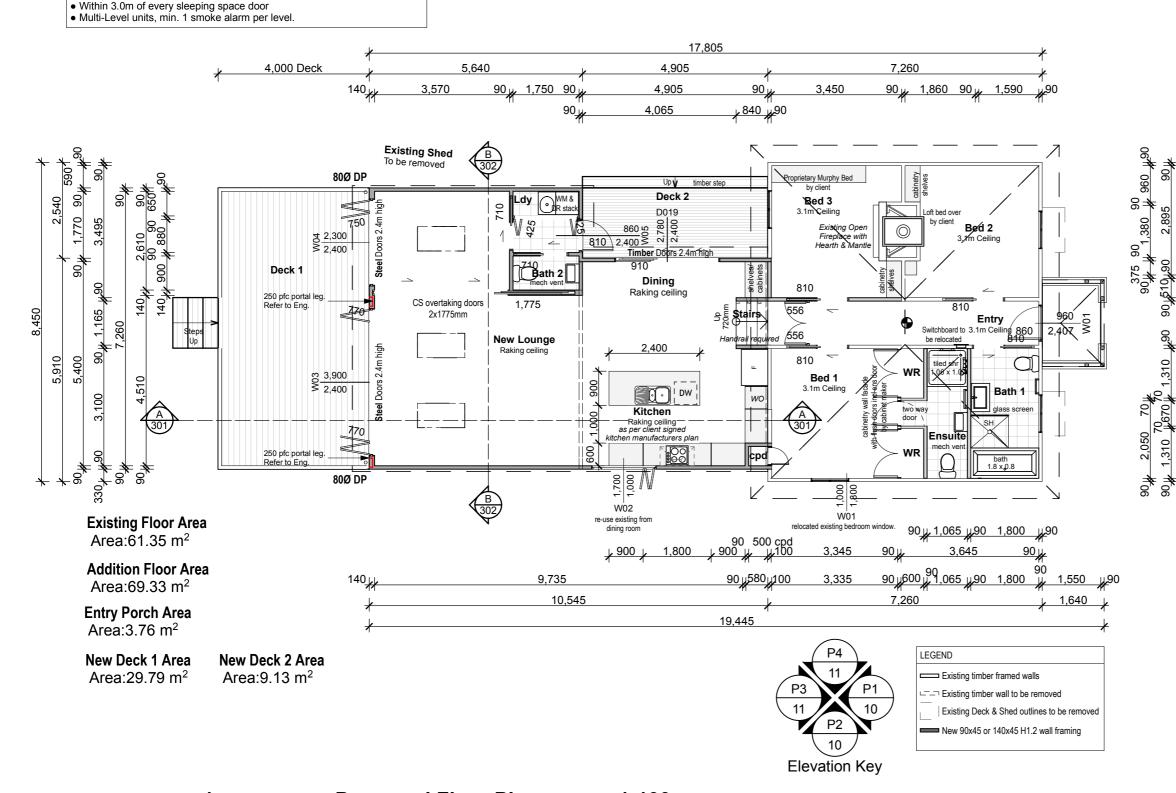

Proposed Floor Plan 1:100

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Proposed Renovation & Addition to Existing Dwelling

T. Gieck

10 Belmont Terrace, Remuera. Auckland 1050

	Proposed Floor Plan	106	;
Drawing Title		Drawing Number	
Scale	AS INDICATED @A3		
Date	26/07/2019	208	
Drawn	A.Langdon	Job No.	Revision




Note: * Existing FFL Note: Ground Lines are indication only

Existing South Elevation E1

1:100

Existing West Elevation E2

1:100

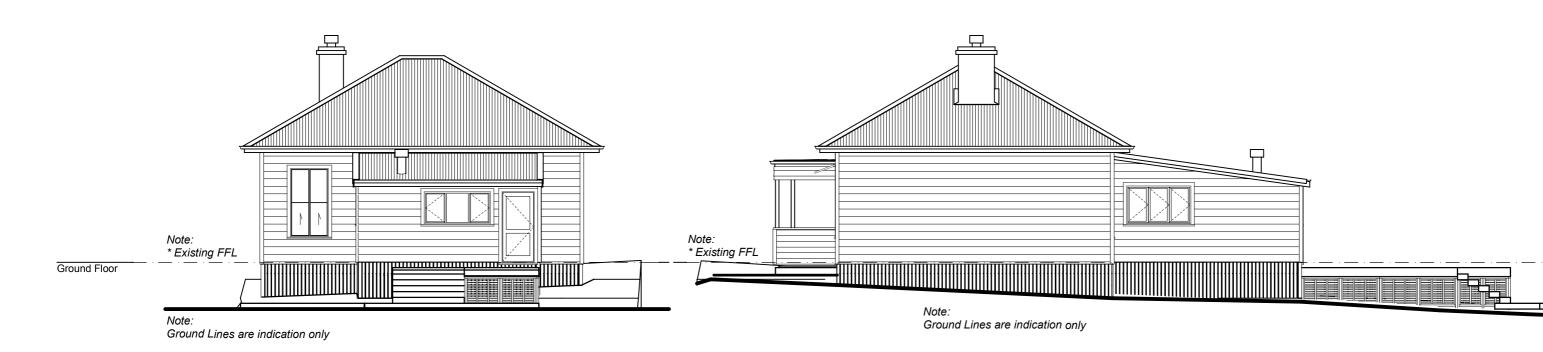

E3 Existing North Elevation 1:100

Existing East Elevation E4 1:100

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Drawn	A.Langdon	Job No.	Revision	
Date	26/07/2019	208		
Scale	AS INDICATED @A3			
Drawing Title	Drawing Title		Drawing Number	
	Existing Elevations	201		

26.07.2019 Client Approval Revision Date Description

Notes

3 deg. Roof Pitch = 3 degrees

MC760 Longrun Roof Cladding

MC760 Longrun COLORSTEEL Endura roofing system, on 70x45 H1.2 Purlins on flat @ 900crs max. over Thermakraft 215 Roofing underlay on 2/190x45 H1.2 SG8 rafters at 600 crs max. New Fibreglass skillion Batts R3.2 insulation to ceiling.

Timber Weatherboards

Client Selected Timber H3.2 Painted Weatherboards on 18mm H3.1 Cavity battens over Thermakraft Watergate Plus Building Paper on H1.2 timber framing. with Fibreglass Batt R2.2 Insulation.

Existing Timber Weatherboards

Existing Rusticated Timber Painted Weatherboards to existing framing with boxed corners

Existing Chimney

Timber Weatherboards to Low height wall

450mm high wall clad in Timber rusticated weatherboards to match house.

Low Pitch Skylight

New Velux FCM 2246 Low Pitch Aluminuim Skylight Refer to Manufacturers installation details and Specifications.

New Detention tank

New Detention tank 750wide x 3.6l x 2.0m high designed in accordance with the Stormwater Assessment Report by eCoast dated 29.03.2019 and installed to manufacturers designs and specifications. Outlet to connect by gravity to public system by gravity in existing connection.




BUILDING ENVELOPE RISK MATRIX All Elevations			
Risk Factor	Risk Severity	Risk	Score
Wind zone (per NZS 3604)	Low risk		0
Number of storeys	Low risk		0
Roof/wall intersection design	Medium risk		1
Eaves width	Very high risk		5
Envelope complexity	Low risk		0
Deck design	Low risk		0
Total Risk Score:			6

Note:

* Existing FFL to remain unchanged

Ground Floor

P1 Proposed South Elevation 1:100

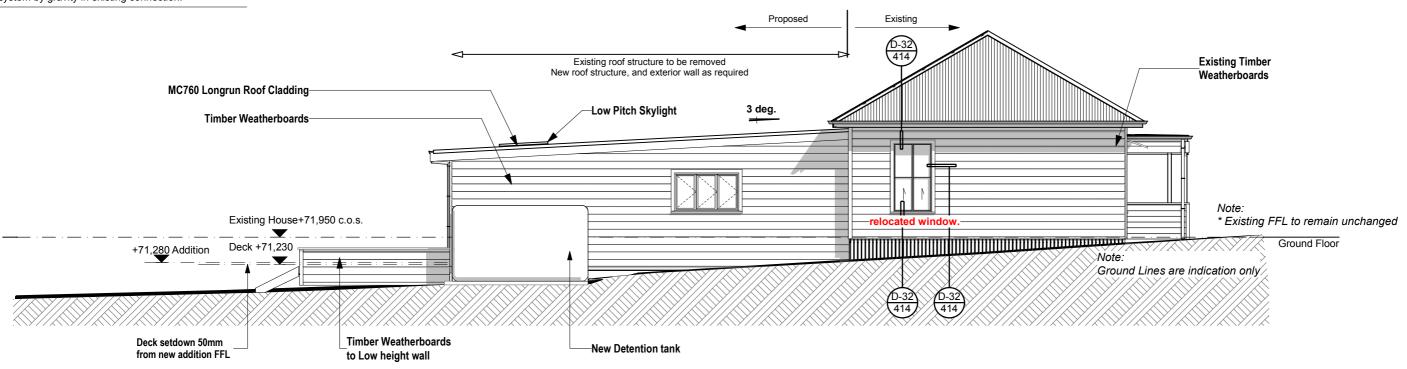

P2 Proposed West Elevation 1:100

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Auckland 1050

A.Langdon Job No. Revision Drawn 26/07/2019 Date 208 Scale AS INDICATED @A3 Drawing Title **Drawing Number Proposed Elevations** 202

Notes

3 deg.

Roof Pitch = 3 degrees

MC760 Longrun Roof Cladding
MC760 Longrun COLORSTEEL Endura roofing system, on 70x45 H1.2 Purlins on flat @ 900crs max. over Thermakraft 215 Roofing underlay on 2/190x45 H1.2 SG8 rafters at 600 crs max. New Fibreglass skillion Batts R3.2 insulation to ceiling.

Rusticated Weatherboards

Paint finish Rusticated Timber Weatherboards (with boxed corners) on 20mm H3.1 Cavity battens over Thermakraft Watergate Plus Building Paper on H1.2 timber framing @ 300crs. with Fibreglass Batt R2.2 Insulation.

Existing Timber Weatherboards

Existing Rusticated Timber Painted Weatherboards to existing framing with boxed corners

Timber Weatherboards to Low height wall

450mm high wall clad in Timber rusticated weatherboards to match house.

Timber Deck 1

Client selected Timber Decking on 140x45mm H3.2 SG8 joists @ 400mm c/c max. on 2/140 x 45mm H4 SG8 Bearers. All Fixings to be S/S. Piles and footings as per engineers design.

Timber Deck 2

Client selected Timber Decking on 140x45mm H3.2 SG8 joists @ 400mm c/c max. on 2/190 x 45mm H4 SG8 Bearers. All Fixings to be S/S. Piles and footings as per engineers design.


Double glazed steel framed windows and doors by Crittall Arnold. Product selection to be confirmed by client.

Low Pitch Skylight

New Velux FCM 2246 Low Pitch Aluminuim Skylight. Refer to Manufacturers installation details and Specifications.


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BUILDING ENVELOPE RISK MATRIX All Elevations			
Wind zone (per NZS 3604)	Low risk	0	
Number of storeys	Low risk	0	
Roof/wall intersection design	Medium risk	1	
Eaves width	Very high risk	5	
Envelope complexity	Low risk	0	
Deck design	Low risk	0	
Total Risk Score:		6	



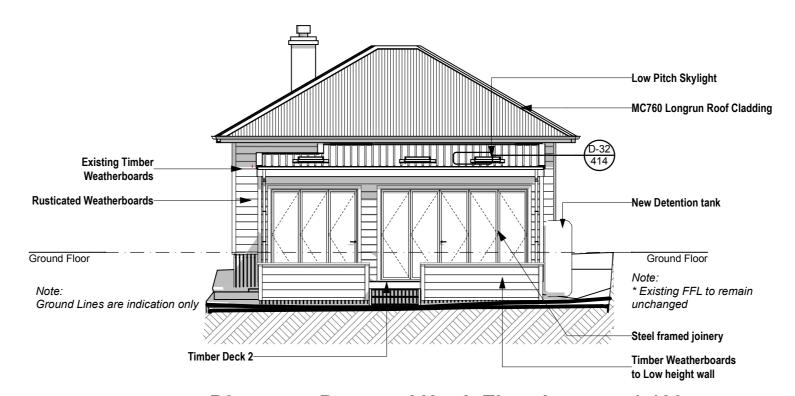

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A.Langdon Job No. Revision Drawn 26/07/2019 Date 208 Scale AS INDICATED @A3 Drawing Title **Drawing Number Proposed Elevations** 203


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Description

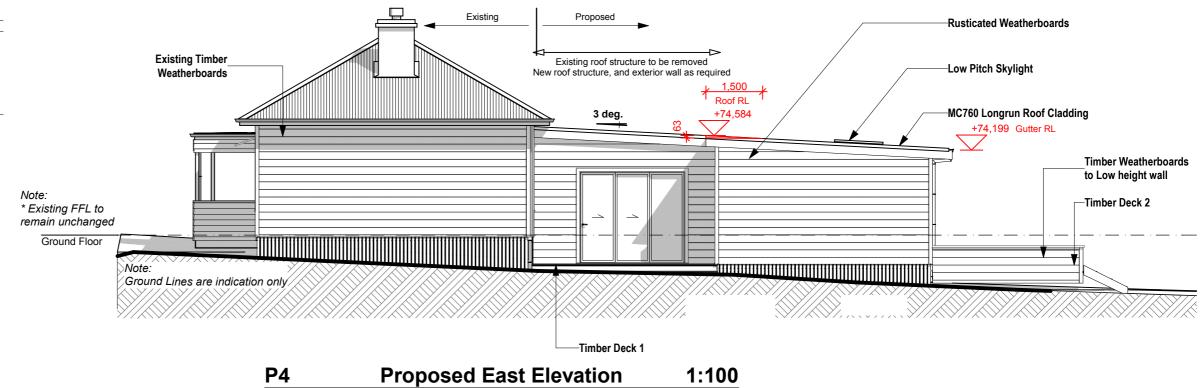Revision Date

PROJECT INSULATION

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Notes

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Timber Weatherboards to Low height wall

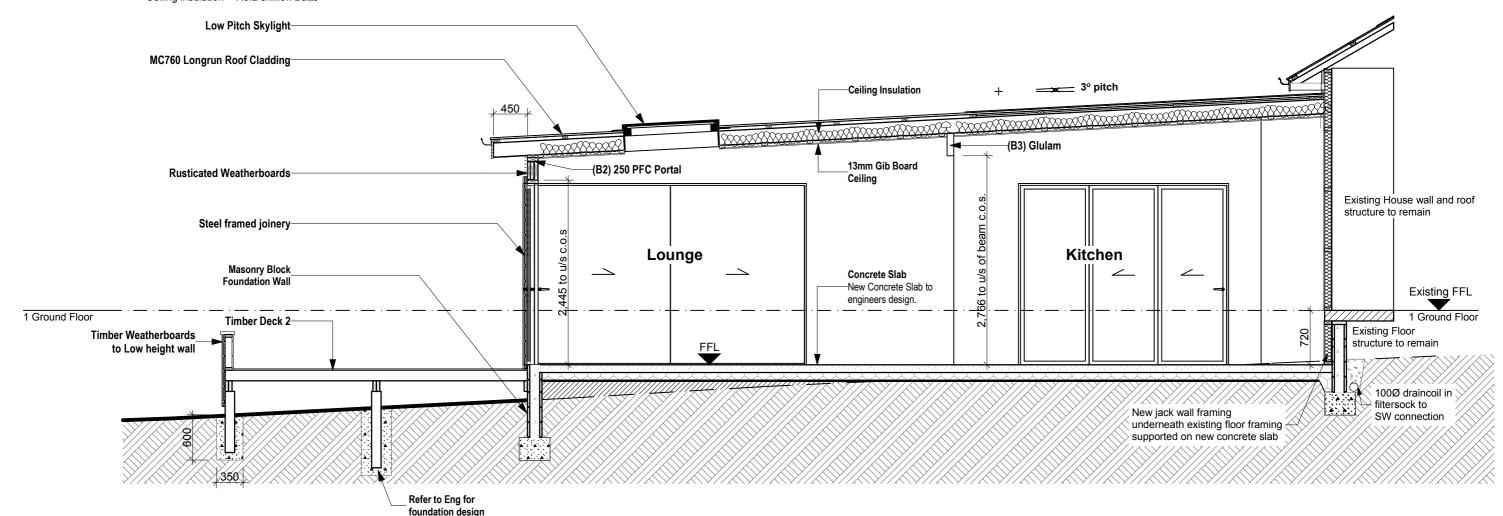450mm high wall clad in Timber rusticated weatherboards to match house.

Masonry Block Foundation Wall

20 series (190mm) reinforced masonry block. Refer to Engineers drawings and specifications for steel size and placement.

Concrete Slab

New Concrete Slab to engineers design.

Timber Deck 2

Client selected Timber Decking on 140x45mm H3.2 SG8 joists @ 400mm c/c max. on 2/190 x 45mm H4 SG8 Bearers. All Fixings to be S/S. Piles and footings as per engineers design.

Ceiling Insulation

Ceiling Insulation to be Pink Batts R3.2

13mm Gib Board Ceiling

13mm Gib board ceiling with 70x35 H1.2 ceiling battens @ 600 crs fixed to underside of Rafters. Gib Aqualine to wet areas. Flush and square stop for level 4 finish.

Steel framed joinery

Double glazed steel framed windows and doors by Crittall Arnold. Product selection to be confirmed by client.

Low Pitch Skylight

New Velux FCM 2246 Low Pitch Aluminuim Skylight. Refer to Manufacturers installation details and Specifications.

Phone: 021915754

Email: tim@demandltd.co.nz Website: demandltd.co.nz

Refer To MEC Consulting Engineers Job # 1912

(B3) Glulam

Section A-A

Refer To MEC Consulting Engineers Job # 1912

(B2) 250 PFC Portal

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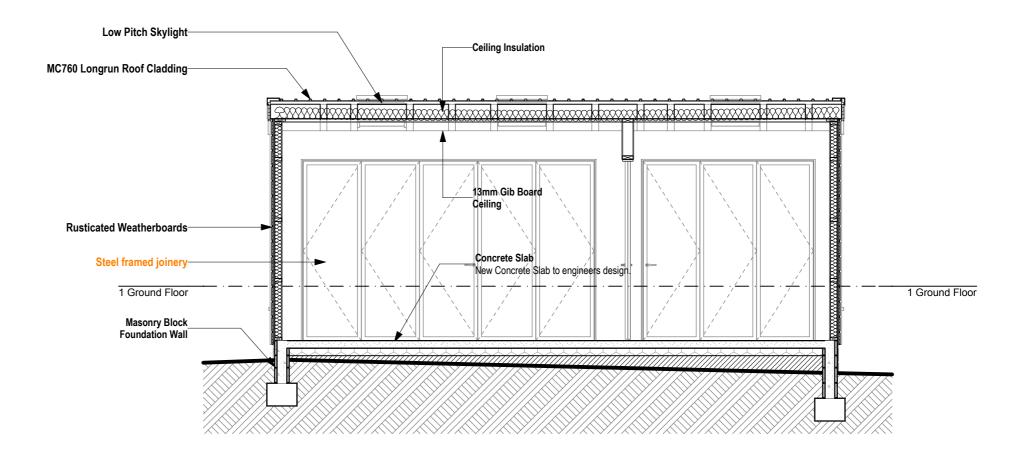
T. Gieck

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Drawn	A.Langdon	Job No.	Revision
Date	26/07/2019	208	
Scale	AS INDICATED @A3		
Drawing Title		Drawing N	Number
	Section A-A	301	

26.07.2019 Client Approval

Description Revision Date



В **Section B-B** 1:50

Notes

Revision Date

MC760 Longrun Roof Cladding

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Ceiling Insulation

for level 4 finish.

Ceiling Insulation to be Pink Batts R3.2

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Low Pitch Skylight

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Drawn	A.Langdon	Job No.	Revision	
Date	26/07/2019	208		
Scale	AS INDICATED @A3			
Drawing Title	Drawing Title		Drawing Number	
Section B-B		302		

26.07.2019 Client Approval

Description