


740 FO 2280, existing head height, lower to 2180 (cos) Line sill with existing

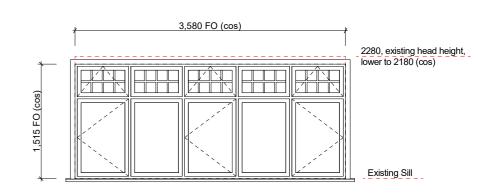

Ground FFL 51.180

**WG01** Joinery

Notes

Architrave 3: Salvaged 92x20 Moulded Rimu, painted

Sash: Replace existing sashes to JMF 5000 series

Fenestrations / Astragals: Detail to be confirmed with

Interior Frame: Allow to paint re-finish window board,

Awning Stays: Salvage, refurbish & re-use existing Hardware

WG02

Joinery Head Apron Flashing: New 0.55 folded colour steel to Notes

Sash: Replace existing sashes to JMF 5000 series

Window Frame: Allow for remedial repair of existing

Interior Frame: Allow to paint re-finish window board,

Fenestrations / Astragals: Detail to be confirmed with

Double Glazed, Solux-E, Argon Filled Glass Type

Sash Type Casement Sash

Casement Stays: Salvage, refurbish & re-use existing Hardware

WG 03

Ground FFL 51.180

Glass Type Double Glazed, Solux-E, Argon Filled

Sash Type Awning Sash

Casement Sash

Fixed Sash

Joinery Suite JMF 5000 Series: Awning & Casement to NZS4211 Exterior Facings: Ex 20mm H3.1, to match existing, Joinery

Window Frame: H3.1 Pine clears, painted finish

Window Sash: Cedar, paint finish, profiles to JMF details Fenestrations / Astragals: Detail to be confirmed with

WG 04

Ground FFL 51.180

Glass Type Double Glazed, Solux-E, Argon Filled

Sash Type Awning Sash

Casement Sash

Fixed Sash

Joinery Suite JMF 5000 Series: Awning & Casement to NZS4211

Window Frame: H3.1 Pine clears, painted finish Joinery

Window Sash: Cedar, paint finish, profiles to JMF details


Exterior Facings: Ex 20mm H3.1, to match existing,


Fenestrations / Astragals: Detail to be confirmed with


Awning Stay: Miles Nelson Quadrant Stays, Florentine

Casement Stay: Miles Nelson Telscopic Stays,

Florentine Bronze (FB)

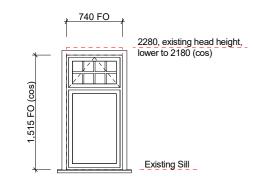

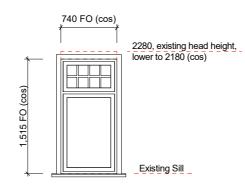

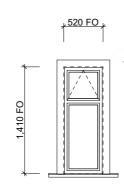

2130, top of interior architrave (cos)

Ground FFL 51.180

Ground FFL 51.180 WG 05

> Glass Type Double Glazed, Solux-E, Argon Filled

Sash Type Awning Sash

Casement Sash

Fixed Sash

Joinery Suite JMF 5000 Series: Awning & Casement to NZS4211 Window Frame: H3.1 Pine clears, painted finish

Joinery

Window Sash: Cedar, paint finish, profiles to JMF details

Exterior Facings: Ex 20mm H3.1, to match existing,

Fenestrations / Astragals: Detail to be confirmed with

Awning Stay: Miles Nelson Quadrant Stays, Florentine

WG 06 Glass Type

Double Glazed, Solux-E, Argon Filled

Awning Sash Sash Type

Casement Sash

Fixed Sash

Joinery

Joinery Suite JMF 5000 Series: Awning & Casement to NZS4211 Window Frame: H3.1 Pine clears, painted finish

> Window Sash: Cedar, paint finish, profiles to JMF details Exterior Facings: Ex 20mm H3.1, to match existing,

Fenestrations / Astragals: Detail to be confirmed with

**WG 07** 

Glass Type Double Glazed, Solux-E, Argon Filled

Safety Glass in compliance with NZS 4223.3:2016

Obscure Double Glazed

Sash Type Awning Sash

Architrave 1: 92x20 Moulded pine clears, painted, refer Joinerv

A404 for profile

Exterior Facings: Ex 20mm H3.1, to match existing,

Window Frame: H3.1 Pine clears, painted finish

Window Sash: Cedar, paint finish, profiles to JMF details Joinery Suite JMF 5000 Series: Awning & Casement to NZS4211

Awning Stay: Miles Nelson Quadrant Stays, Florentine Hardware Bronze (FB)

Head to match

existing (cos)

WG 08

Hardware Awning Stays: Salvage, refurbish & re-use existing

Joinery Notes

Architrave 3: Salvaged 92x20 Moulded Rimu, painted

Interior Frame: Allow to paint re-finish window board,

frame & architraves

Sash: Replace existing sashes to JMF 5000 series details

Casement Sash

Double Glazed, Solux-E, Argon Filled

# **Baldwin Allen**

For: David Allen & Pip Baldwin

At: 11 A Shirley St Karori Wellington



5 Everton Terrace, PO Box 12 232, Wellington 6144 akmiddleton.co.nz

Date:

ISSUE:

Issued for Construction

Comments

Scale: 1:50 Original size: A3

Designed | Drawn: RM / CS

N:\2021\2104 Baldwin Allen\3.0-Drawi \230417\_CD\_BaldwinAllen\_CA Set.pln

File Reference: Allen\3.0-Drawinas\3.1-ArchiCAD\CA

**Exterior Window Schedule** 

Stage of Documentation: **Detailed Design** Printed: 21/04/2023


Drawing number / Issue


Project number:

2104


A601b

Copyright in all drawings, specifications and other documents and in the work executed from them remains the property of Novak+Middleton Limited.

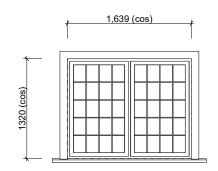

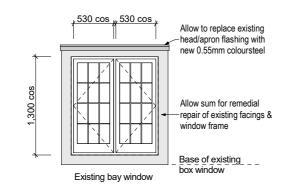

740 FO 2280, existing head height, lower to 2180 (cos) Line sill with existing

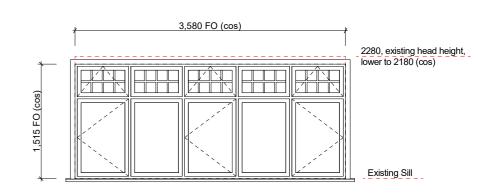

Ground FFL 51.180

**WG01** Joinery

Notes

Architrave 3: Salvaged 92x20 Moulded Rimu, painted

Sash: Replace existing sashes to JMF 5000 series

Fenestrations / Astragals: Detail to be confirmed with

Interior Frame: Allow to paint re-finish window board,

Awning Stays: Salvage, refurbish & re-use existing Hardware

WG02

Joinery Head Apron Flashing: New 0.55 folded colour steel to Notes

Sash: Replace existing sashes to JMF 5000 series

Window Frame: Allow for remedial repair of existing

Interior Frame: Allow to paint re-finish window board,

Fenestrations / Astragals: Detail to be confirmed with

Double Glazed, Solux-E, Argon Filled Glass Type

Sash Type Casement Sash

Casement Stays: Salvage, refurbish & re-use existing Hardware

WG 03

Ground FFL 51.180

Glass Type Double Glazed, Solux-E, Argon Filled

Sash Type Awning Sash

Casement Sash

Fixed Sash

Joinery Suite JMF 5000 Series: Awning & Casement to NZS4211 Exterior Facings: Ex 20mm H3.1, to match existing, Joinery

Window Frame: H3.1 Pine clears, painted finish

Window Sash: Cedar, paint finish, profiles to JMF details Fenestrations / Astragals: Detail to be confirmed with

WG 04

Ground FFL 51.180

Glass Type Double Glazed, Solux-E, Argon Filled

Sash Type Awning Sash

Casement Sash

Fixed Sash

Joinery Suite JMF 5000 Series: Awning & Casement to NZS4211

Window Frame: H3.1 Pine clears, painted finish Joinery

Window Sash: Cedar, paint finish, profiles to JMF details


Exterior Facings: Ex 20mm H3.1, to match existing,


Fenestrations / Astragals: Detail to be confirmed with


Awning Stay: Miles Nelson Quadrant Stays, Florentine

Casement Stay: Miles Nelson Telscopic Stays,

Florentine Bronze (FB)

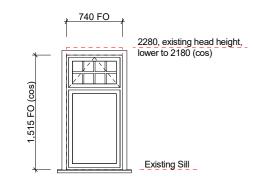

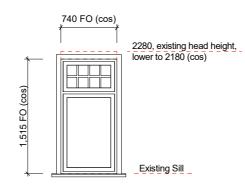

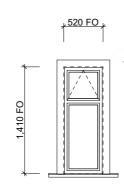

2130, top of interior architrave (cos)

Ground FFL 51.180

Ground FFL 51.180 WG 05

> Glass Type Double Glazed, Solux-E, Argon Filled

Sash Type Awning Sash

Casement Sash

Fixed Sash

Joinery Suite JMF 5000 Series: Awning & Casement to NZS4211 Window Frame: H3.1 Pine clears, painted finish

Joinery

Window Sash: Cedar, paint finish, profiles to JMF details

Exterior Facings: Ex 20mm H3.1, to match existing,

Fenestrations / Astragals: Detail to be confirmed with

Awning Stay: Miles Nelson Quadrant Stays, Florentine

WG 06 Glass Type

Double Glazed, Solux-E, Argon Filled

Awning Sash Sash Type

Casement Sash

Fixed Sash

Joinery

Joinery Suite JMF 5000 Series: Awning & Casement to NZS4211 Window Frame: H3.1 Pine clears, painted finish

> Window Sash: Cedar, paint finish, profiles to JMF details Exterior Facings: Ex 20mm H3.1, to match existing,

Fenestrations / Astragals: Detail to be confirmed with

**WG 07** 

Glass Type Double Glazed, Solux-E, Argon Filled

Safety Glass in compliance with NZS 4223.3:2016

Obscure Double Glazed

Sash Type Awning Sash

Architrave 1: 92x20 Moulded pine clears, painted, refer Joinerv

A404 for profile

Exterior Facings: Ex 20mm H3.1, to match existing,

Window Frame: H3.1 Pine clears, painted finish

Window Sash: Cedar, paint finish, profiles to JMF details Joinery Suite JMF 5000 Series: Awning & Casement to NZS4211

Awning Stay: Miles Nelson Quadrant Stays, Florentine Hardware Bronze (FB)

Head to match

existing (cos)

WG 08

Hardware Awning Stays: Salvage, refurbish & re-use existing

Joinery Notes

Architrave 3: Salvaged 92x20 Moulded Rimu, painted

Interior Frame: Allow to paint re-finish window board,

frame & architraves

Sash: Replace existing sashes to JMF 5000 series details

Casement Sash

Double Glazed, Solux-E, Argon Filled

# **Baldwin Allen**

For: David Allen & Pip Baldwin

At: 11 A Shirley St Karori Wellington



5 Everton Terrace, PO Box 12 232, Wellington 6144 akmiddleton.co.nz

Date:

ISSUE:

Issued for Construction

Comments

Scale: 1:50 Original size: A3

Designed | Drawn: RM / CS

N:\2021\2104 Baldwin Allen\3.0-Drawi \230417\_CD\_BaldwinAllen\_CA Set.pln

File Reference: Allen\3.0-Drawinas\3.1-ArchiCAD\CA

**Exterior Window Schedule** 

Stage of Documentation: **Detailed Design** Printed: 21/04/2023


Drawing number / Issue


Project number:

2104


A601b

Copyright in all drawings, specifications and other documents and in the work executed from them remains the property of Novak+Middleton Limited.

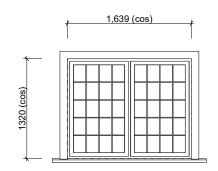

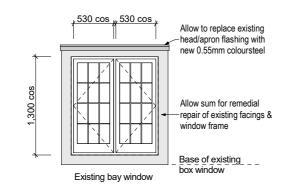

740 FO 2280, existing head height, lower to 2180 (cos) Line sill with existing

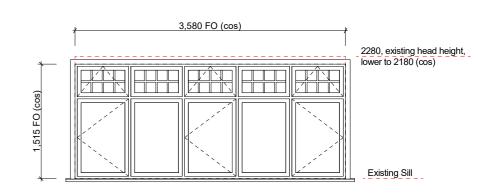

Ground FFL 51.180

**WG01** Joinery

Notes

Architrave 3: Salvaged 92x20 Moulded Rimu, painted

Sash: Replace existing sashes to JMF 5000 series

Fenestrations / Astragals: Detail to be confirmed with

Interior Frame: Allow to paint re-finish window board,

Awning Stays: Salvage, refurbish & re-use existing Hardware

WG02

Joinery Head Apron Flashing: New 0.55 folded colour steel to Notes

Sash: Replace existing sashes to JMF 5000 series

Window Frame: Allow for remedial repair of existing

Interior Frame: Allow to paint re-finish window board,

Fenestrations / Astragals: Detail to be confirmed with

Double Glazed, Solux-E, Argon Filled Glass Type

Sash Type Casement Sash

Casement Stays: Salvage, refurbish & re-use existing Hardware

WG 03

Ground FFL 51.180

Glass Type Double Glazed, Solux-E, Argon Filled

Sash Type Awning Sash

Casement Sash

Fixed Sash

Joinery Suite JMF 5000 Series: Awning & Casement to NZS4211 Exterior Facings: Ex 20mm H3.1, to match existing, Joinery

Window Frame: H3.1 Pine clears, painted finish

Window Sash: Cedar, paint finish, profiles to JMF details Fenestrations / Astragals: Detail to be confirmed with

WG 04

Ground FFL 51.180

Glass Type Double Glazed, Solux-E, Argon Filled

Sash Type Awning Sash

Casement Sash

Fixed Sash

Joinery Suite JMF 5000 Series: Awning & Casement to NZS4211

Window Frame: H3.1 Pine clears, painted finish Joinery

Window Sash: Cedar, paint finish, profiles to JMF details


Exterior Facings: Ex 20mm H3.1, to match existing,


Fenestrations / Astragals: Detail to be confirmed with


Awning Stay: Miles Nelson Quadrant Stays, Florentine

Casement Stay: Miles Nelson Telscopic Stays,

Florentine Bronze (FB)

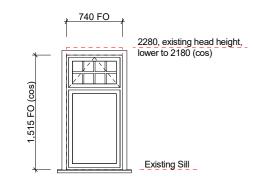

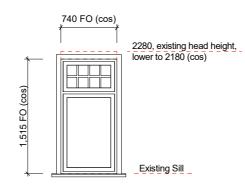

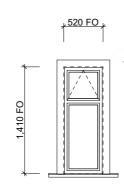

2130, top of interior architrave (cos)

Ground FFL 51.180

Ground FFL 51.180 WG 05

> Glass Type Double Glazed, Solux-E, Argon Filled

Sash Type Awning Sash

Casement Sash

Fixed Sash

Joinery Suite JMF 5000 Series: Awning & Casement to NZS4211 Window Frame: H3.1 Pine clears, painted finish

Joinery

Window Sash: Cedar, paint finish, profiles to JMF details

Exterior Facings: Ex 20mm H3.1, to match existing,

Fenestrations / Astragals: Detail to be confirmed with

Awning Stay: Miles Nelson Quadrant Stays, Florentine

WG 06 Glass Type

Double Glazed, Solux-E, Argon Filled

Awning Sash Sash Type

Casement Sash

Fixed Sash

Joinery

Joinery Suite JMF 5000 Series: Awning & Casement to NZS4211 Window Frame: H3.1 Pine clears, painted finish

> Window Sash: Cedar, paint finish, profiles to JMF details Exterior Facings: Ex 20mm H3.1, to match existing,

Fenestrations / Astragals: Detail to be confirmed with

**WG 07** 

Glass Type Double Glazed, Solux-E, Argon Filled

Safety Glass in compliance with NZS 4223.3:2016

Obscure Double Glazed

Sash Type Awning Sash

Architrave 1: 92x20 Moulded pine clears, painted, refer Joinerv

A404 for profile

Exterior Facings: Ex 20mm H3.1, to match existing,

Window Frame: H3.1 Pine clears, painted finish

Window Sash: Cedar, paint finish, profiles to JMF details Joinery Suite JMF 5000 Series: Awning & Casement to NZS4211

Awning Stay: Miles Nelson Quadrant Stays, Florentine Hardware Bronze (FB)

Head to match

existing (cos)

WG 08

Hardware Awning Stays: Salvage, refurbish & re-use existing

Joinery Notes

Architrave 3: Salvaged 92x20 Moulded Rimu, painted

Interior Frame: Allow to paint re-finish window board,

frame & architraves

Sash: Replace existing sashes to JMF 5000 series details

Casement Sash

Double Glazed, Solux-E, Argon Filled

# **Baldwin Allen**

For: David Allen & Pip Baldwin

At: 11 A Shirley St Karori Wellington



5 Everton Terrace, PO Box 12 232, Wellington 6144 akmiddleton.co.nz

Date:

ISSUE:

Issued for Construction

Comments

Scale: 1:50 Original size: A3

Designed | Drawn: RM / CS

N:\2021\2104 Baldwin Allen\3.0-Drawi \230417\_CD\_BaldwinAllen\_CA Set.pln

File Reference: Allen\3.0-Drawinas\3.1-ArchiCAD\CA

**Exterior Window Schedule** 

Stage of Documentation: **Detailed Design** Printed: 21/04/2023


Drawing number / Issue

Project number:

2104

A601b

Copyright in all drawings, specifications and other documents and in the work executed from them remains the property of Novak+Middleton Limited.

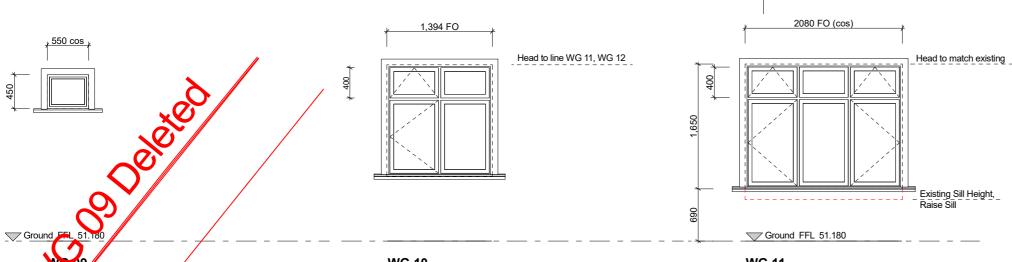

WG 10

Double Glazed, Solux-E, Argon Filled Glass Type

Sash Type Awning Sash

> Casement Sash Fixed Sash

Architrave 1: 92x20 Moulded pine clears, painted, refer Joinery Notes

A404 for profile

Window Frame: H3.1 Pine clears, painted finish

Window Sash: Cedar, paint finish, profiles to JMF details

Joinery Suite JMF 5000 Series: Awning & Casement to NZS4211

Awning Stay: Miles Nelson Quadrant Stays, Florentine Bronze (FB)

Casement Stay: Miles Nelson Telscopic Stays,

Florentine Bronze (FB)

WG 11

Glass Type Double Glazed, Solux-E, Argon Filled

Sash Type Awning Sash

Casement Sash Fixed Sash

Joinery Architrave 1: 92x20 Moulded pine clears, painted, refer Notes

A404 for profile

Window Frame: H3.1 Pine clears, painted finish


Window Sash: Cedar, paint finish, profiles to JMF details

Joinery Suite JMF 5000 Series: Awning & Casement to NZS4211

Awning Stay: Miles Nelson Quadrant Stays, Florentine Bronze (FB)

Casement Stay: Miles Nelson Telscopic Stays,

Florentine Bronze (FB)

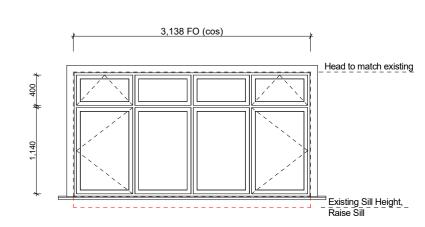

### WG 12

Double Glazed, Solux-E, Argon Filled

Awning Sash

Casement Sash

Fixed Sash

Joinery Architrave 1: 92x20 Moulded pine clears, painted, refer Notes

A404 for profile

Window Frame: H3.1 Pine clears, painted finish

Window Sash: Cedar, paint finish, profiles to JMF details


Joinery Suite JMF 5000 Series: Awning & Casement to NZS4211

Awning Stay: Miles Nelson Quadrant Stays, Florentine

Bronze (FB)

Casement Stay: Miles Nelson Telscopic Stays,

Florentine Bronze (FB)

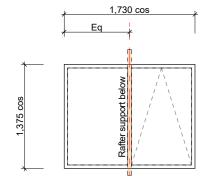

Suite: Alpac Thermal Heart roof glazing supplied by Wellington Windows & Doors One side electric opener

Glazing: Double Glazed, Solux E, Argon Filled

Double Glazed, Solux-E, Argon Filled

window frame

Fixed Sash

Sash Type

Casement Stays: Salvage, refurbish & re-use existing


Architraye 3: Salvaged 92x20 Moulded Rimu, painted

Interior Frame: Allow to paint re-finish window board,

Sash: Replace existing sashes to JMF 5000 series

Window Frame: Allow for remedial repair of existing

Exterior Frame Colour: Powdercoated TBC

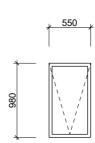

### SK 02

Suite: Velux Skylight (C04) 550x980 VSS Glazing: Double Glazed, Solux E, Argon Filled Exterior Frame Colour: Powdercoated TBC

## **Baldwin Allen**

For: David Allen & Pip Baldwin

At: 11 A Shirley St Karori Wellington



15 Everton Terrace, PO Box 12 232, Wellington 6144 t 04 472 9729 e architects@novakmiddleton.co.nz vakmiddleton.co.nz

Copyright in all drawings, specifications and other documents and in the work executed from them remains the property of Novak+Middleton Limited.

ISSUE: Date: Comments: Issued for Construction

Original size: A3 Designed | Drawn: RM / CS

Scale: 1:50

File Reference: N:\2021\2104 Baldwin Allen\3.0-Drawi \230417\_CD\_BaldwinAllen\_CA Set.pln


**Exterior Window Schedule** 

Stage of Documentation:

Detailed Design Printed: 21/04/2023

Project number: 2104 Drawing number / Issue:

A602a

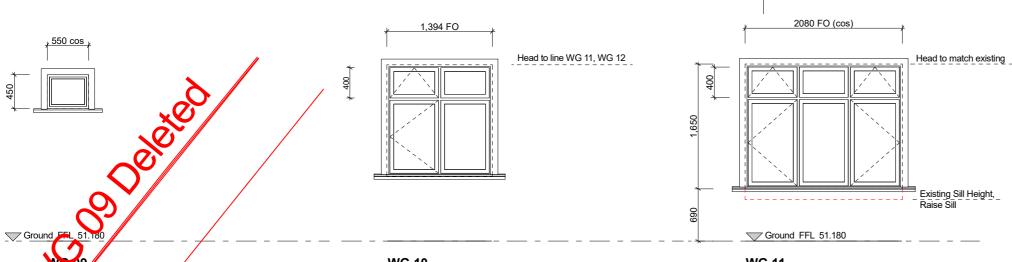

WG 10

Double Glazed, Solux-E, Argon Filled Glass Type

Sash Type Awning Sash

> Casement Sash Fixed Sash

Architrave 1: 92x20 Moulded pine clears, painted, refer Joinery Notes

A404 for profile

Window Frame: H3.1 Pine clears, painted finish

Window Sash: Cedar, paint finish, profiles to JMF details

Joinery Suite JMF 5000 Series: Awning & Casement to NZS4211

Awning Stay: Miles Nelson Quadrant Stays, Florentine Bronze (FB)

Casement Stay: Miles Nelson Telscopic Stays,

Florentine Bronze (FB)

WG 11

Glass Type Double Glazed, Solux-E, Argon Filled

Sash Type Awning Sash

Casement Sash Fixed Sash

Joinery Architrave 1: 92x20 Moulded pine clears, painted, refer Notes

A404 for profile

Window Frame: H3.1 Pine clears, painted finish


Window Sash: Cedar, paint finish, profiles to JMF details

Joinery Suite JMF 5000 Series: Awning & Casement to NZS4211

Awning Stay: Miles Nelson Quadrant Stays, Florentine Bronze (FB)

Casement Stay: Miles Nelson Telscopic Stays,

Florentine Bronze (FB)

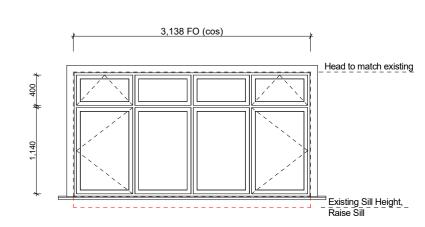

### WG 12

Double Glazed, Solux-E, Argon Filled

Awning Sash

Casement Sash

Fixed Sash

Joinery Architrave 1: 92x20 Moulded pine clears, painted, refer Notes

A404 for profile

Window Frame: H3.1 Pine clears, painted finish

Window Sash: Cedar, paint finish, profiles to JMF details


Joinery Suite JMF 5000 Series: Awning & Casement to NZS4211

Awning Stay: Miles Nelson Quadrant Stays, Florentine

Bronze (FB)

Casement Stay: Miles Nelson Telscopic Stays,

Florentine Bronze (FB)

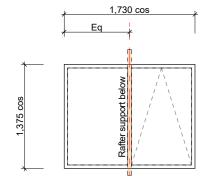

Suite: Alpac Thermal Heart roof glazing supplied by Wellington Windows & Doors One side electric opener

Glazing: Double Glazed, Solux E, Argon Filled

Double Glazed, Solux-E, Argon Filled

window frame

Fixed Sash

Sash Type

Casement Stays: Salvage, refurbish & re-use existing


Architraye 3: Salvaged 92x20 Moulded Rimu, painted

Interior Frame: Allow to paint re-finish window board,

Sash: Replace existing sashes to JMF 5000 series

Window Frame: Allow for remedial repair of existing

Exterior Frame Colour: Powdercoated TBC

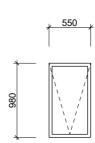

### SK 02

Suite: Velux Skylight (C04) 550x980 VSS Glazing: Double Glazed, Solux E, Argon Filled Exterior Frame Colour: Powdercoated TBC

## **Baldwin Allen**

For: David Allen & Pip Baldwin

At: 11 A Shirley St Karori Wellington



15 Everton Terrace, PO Box 12 232, Wellington 6144 t 04 472 9729 e architects@novakmiddleton.co.nz vakmiddleton.co.nz

Copyright in all drawings, specifications and other documents and in the work executed from them remains the property of Novak+Middleton Limited.

ISSUE: Date: Comments: Issued for Construction

Original size: A3 Designed | Drawn: RM / CS

Scale: 1:50

File Reference: N:\2021\2104 Baldwin Allen\3.0-Drawi \230417\_CD\_BaldwinAllen\_CA Set.pln


**Exterior Window Schedule** 

Stage of Documentation:

Detailed Design Printed: 21/04/2023

Project number: 2104 Drawing number / Issue:

A602a

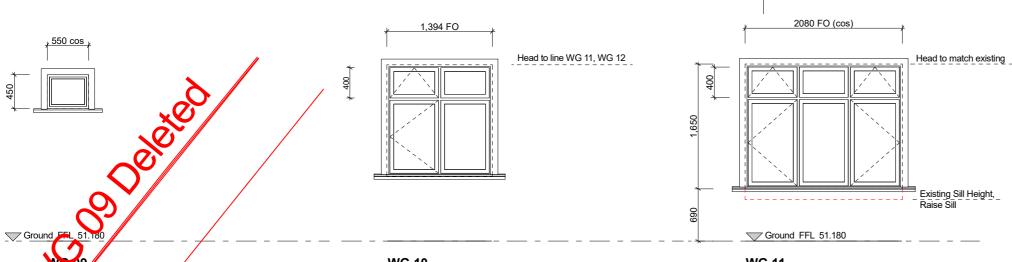

WG 10

Double Glazed, Solux-E, Argon Filled Glass Type

Sash Type Awning Sash

> Casement Sash Fixed Sash

Architrave 1: 92x20 Moulded pine clears, painted, refer Joinery Notes

A404 for profile

Window Frame: H3.1 Pine clears, painted finish

Window Sash: Cedar, paint finish, profiles to JMF details

Joinery Suite JMF 5000 Series: Awning & Casement to NZS4211

Awning Stay: Miles Nelson Quadrant Stays, Florentine Bronze (FB)

Casement Stay: Miles Nelson Telscopic Stays,

Florentine Bronze (FB)

WG 11

Glass Type Double Glazed, Solux-E, Argon Filled

Sash Type Awning Sash

Casement Sash Fixed Sash

Joinery Architrave 1: 92x20 Moulded pine clears, painted, refer Notes

A404 for profile

Window Frame: H3.1 Pine clears, painted finish


Window Sash: Cedar, paint finish, profiles to JMF details

Joinery Suite JMF 5000 Series: Awning & Casement to NZS4211

Awning Stay: Miles Nelson Quadrant Stays, Florentine Bronze (FB)

Casement Stay: Miles Nelson Telscopic Stays,

Florentine Bronze (FB)

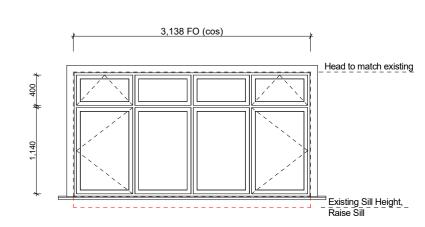

### WG 12

Double Glazed, Solux-E, Argon Filled

Awning Sash

Casement Sash

Fixed Sash

Joinery Architrave 1: 92x20 Moulded pine clears, painted, refer Notes

A404 for profile

Window Frame: H3.1 Pine clears, painted finish

Window Sash: Cedar, paint finish, profiles to JMF details


Joinery Suite JMF 5000 Series: Awning & Casement to NZS4211

Awning Stay: Miles Nelson Quadrant Stays, Florentine

Bronze (FB)

Casement Stay: Miles Nelson Telscopic Stays,

Florentine Bronze (FB)

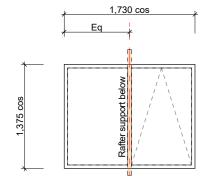

Suite: Alpac Thermal Heart roof glazing supplied by Wellington Windows & Doors One side electric opener

Glazing: Double Glazed, Solux E, Argon Filled

Double Glazed, Solux-E, Argon Filled

window frame

Fixed Sash

Sash Type

Casement Stays: Salvage, refurbish & re-use existing


Architraye 3: Salvaged 92x20 Moulded Rimu, painted

Interior Frame: Allow to paint re-finish window board,

Sash: Replace existing sashes to JMF 5000 series

Window Frame: Allow for remedial repair of existing

Exterior Frame Colour: Powdercoated TBC

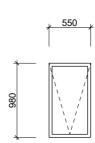

### SK 02

Suite: Velux Skylight (C04) 550x980 VSS Glazing: Double Glazed, Solux E, Argon Filled Exterior Frame Colour: Powdercoated TBC

## **Baldwin Allen**

For: David Allen & Pip Baldwin

At: 11 A Shirley St Karori Wellington



15 Everton Terrace, PO Box 12 232, Wellington 6144 t 04 472 9729 e architects@novakmiddleton.co.nz vakmiddleton.co.nz

Copyright in all drawings, specifications and other documents and in the work executed from them remains the property of Novak+Middleton Limited.

ISSUE: Date: Comments: Issued for Construction

Original size: A3 Designed | Drawn: RM / CS

Scale: 1:50

File Reference: N:\2021\2104 Baldwin Allen\3.0-Drawi \230417\_CD\_BaldwinAllen\_CA Set.pln


**Exterior Window Schedule** 

Stage of Documentation:

Detailed Design Printed: 21/04/2023

Project number: 2104 Drawing number / Issue:

A602a

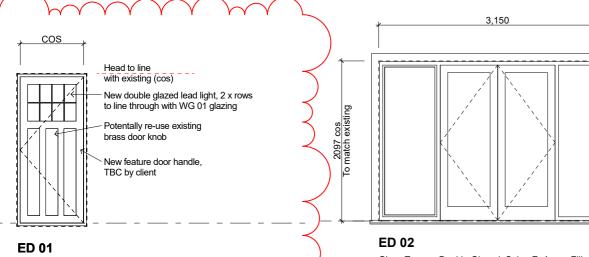

Door Type Single Hinged Door Hardware 100MM S.S Butt hinge

Door Frame: H3.1 Pine clears painted, profiles to JMF Joinery

standard details Notes

Door Sill: Hardwood, painted finish to standard JMF

Exterior Facings: Ex 20mm H3.1, to match existing, paint finish

Joinery Suite JMF 7000 Series: Hinged & French Door to NZS4211

Door Leaf Solid Core Glass Type Double Glazed, Solux-E, Argon Filled

Safety Glass in compliance with NZS 4223.3:2016

Joinery Architrave 1: 92x20 Moulded pine clears, painted, refer

A404 for profile


Exterior Facings: Ex 20mm H3.1, to match existing,

Finish Painted Finish, refer resene specification

Sash Type Hinged Door Fixed Pane Sidelight

100MM S.S Butt hinge Hardware

Door Hardware: To be confirmed by client Joinery Suite JMF 7000 Series: Hinged & French Door to NZS4211 1,600

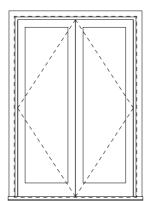

### **ED 04**

Glass Type Double Glazed, Solux-E, Argon Filled

Safety Glass in compliance with NZS 4223.3:2016

Joinery Architrave 1: 92x20 Moulded pine clears, painted, refer

Exterior Facings: Ex 20mm H3.1, to match existing,

Door Frame: H3.1 Pine clears painted, profiles to JMF standard details

Door Sill: Hardwood, painted finish to standard JMF


Glazed Door Frame: Cedar, painted, profiles to JMF standard details

Painted Finish, refer resene specification Finish

Sash Type Fixed Pane

Joinery Suite JMF 7000 Series: Hinged & French Door to NZS4211

Door Type Single Hinged Door

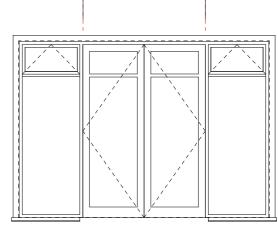

Line with Skylight Opening

Head to line with WG 12

Line through

with WG 12 Awning

ED 05

Single Hinged Door Door Type

Glass Type Double Glazed, Solux-E, Argon Filled

100MM S.S Butt hinge

Door Hardware: To be confirmed by client

Mortice Lock

Selected 2 Lever Mortice Lock - 44mm Backset

Architrave 1: 92x20 Moulded pine clears, painted, refer A404 for profile

Door Frame: H3.1 Pine clears painted, profiles to JMF

standard details

Exterior Facings: Ex 20mm H3.1, to match existing,

Glazed Door Frame: Cedar, painted, profiles to JMF

standard details

Joinery Suite JMF 7000 Series: Hinged & French Door to NZS4211

Awning Sash Sash Type

Fixed Sash

Hinged Door


### **Baldwin Allen**



Date:

Comments:

Scale: 1:50

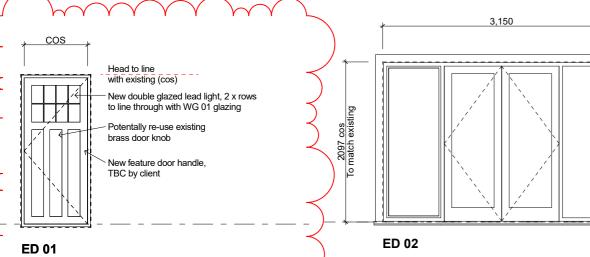

Glass Type Double Glazed, Solux-E, Argon Filled

Safety Glass in compliance with NZS 4223.3:2016

Joinery Architrave 1: 92x20 Moulded pine clears, painted, refer A404 for profile

Exterior Facings: Ex 20mm H3.1, to match existing,


Finish Painted Finish, refer resene specification

Sash Type Hinged Door Fixed Pane Sidelight

100MM S.S Butt hinge Hardware

Door Hardware: To be confirmed by client

Joinery Suite JMF 7000 Series: Hinged & French Door to NZS4211

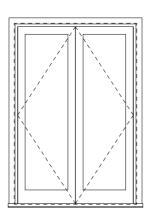

1,600

**ED 04** 

Glass Type Double Glazed, Solux-E, Argon Filled

Safety Glass in compliance with NZS 4223.3:2016

Joinery Architrave 1: 92x20 Moulded pine clears, painted, refer

Exterior Facings: Ex 20mm H3.1, to match existing,

Door Frame: H3.1 Pine clears painted, profiles to JMF standard details

Door Sill: Hardwood, painted finish to standard JMF

Glazed Door Frame: Cedar, painted, profiles to JMF


standard details

Painted Finish, refer resene specification Finish

Sash Type Fixed Pane

Joinery Suite JMF 7000 Series: Hinged & French Door to NZS4211

Door Type Single Hinged Door

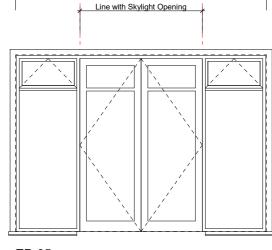

ED 05

Single Hinged Door Door Type

Glass Type Double Glazed, Solux-E, Argon Filled

100MM S.S Butt hinge

Door Hardware: To be confirmed by client

Mortice Lock

Selected 2 Lever Mortice Lock - 44mm Backset

Architrave 1: 92x20 Moulded pine clears, painted, refer

A404 for profile Door Frame: H3.1 Pine clears painted, profiles to JMF

standard details

Exterior Facings: Ex 20mm H3.1, to match existing,

Glazed Door Frame: Cedar, painted, profiles to JMF

standard details

Joinery Suite JMF 7000 Series: Hinged & French Door to NZS4211

Awning Sash Sash Type

Fixed Sash

Hinged Door

Door Type

Hardware

Door Leaf

Joinery

Notes

Single Hinged Door

standard details

paint finish

Solid Core

100MM S.S Butt hinge

Door Frame: H3.1 Pine clears painted, profiles to JMF

Door Sill: Hardwood, painted finish to standard JMF

Exterior Facings: Ex 20mm H3.1, to match existing,

Joinery Suite JMF 7000 Series: Hinged & French Door to NZS4211

### **Baldwin Allen**



15 Everton Terrace, PO Box 12 232, Wellington 6144 ww.novakmiddleton.co.nz

Copyright in all drawings, specifications and other documents and in the work executed from them remains the property of Novak+Middleton Limited.

ISSUE:

Date:

Issued for Construction

Comments:

Scale: 1:50

Original size: A3

Designed | Drawn: RM / CS

File Reference: N:\2021\2104 Baldwin Allen\3.0-Drawi \230417\_CD\_BaldwinAllen\_CA Set.pln dwin Allen\3.0-Drawings\3.1-ArchiCAD\CA Drawing:

Exterior Door Schedule

Stage of Documentation: Detailed Design

Printed: 21/04/2023

Project number: 2104


Drawing number / Issue:

Head to line with WG 12

Line through

with WG 12 Awning

A603b

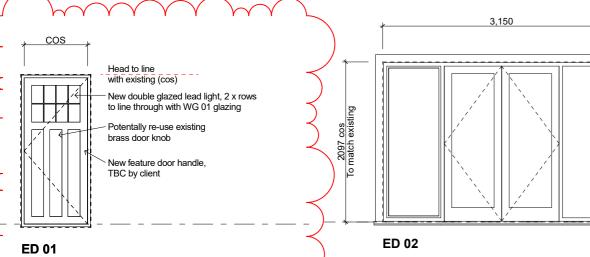

Glass Type Double Glazed, Solux-E, Argon Filled

Safety Glass in compliance with NZS 4223.3:2016

Joinery Architrave 1: 92x20 Moulded pine clears, painted, refer A404 for profile

Exterior Facings: Ex 20mm H3.1, to match existing,


Finish Painted Finish, refer resene specification

Sash Type Hinged Door Fixed Pane Sidelight

100MM S.S Butt hinge Hardware

Door Hardware: To be confirmed by client

Joinery Suite JMF 7000 Series: Hinged & French Door to NZS4211

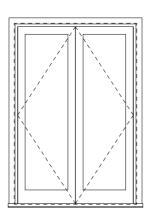

1,600

**ED 04** 

Glass Type Double Glazed, Solux-E, Argon Filled

Safety Glass in compliance with NZS 4223.3:2016

Joinery Architrave 1: 92x20 Moulded pine clears, painted, refer

Exterior Facings: Ex 20mm H3.1, to match existing,

Door Frame: H3.1 Pine clears painted, profiles to JMF standard details

Door Sill: Hardwood, painted finish to standard JMF

Glazed Door Frame: Cedar, painted, profiles to JMF


standard details

Painted Finish, refer resene specification Finish

Sash Type Fixed Pane

Joinery Suite JMF 7000 Series: Hinged & French Door to NZS4211

Door Type Single Hinged Door

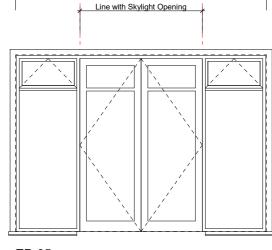

ED 05

Single Hinged Door Door Type

Glass Type Double Glazed, Solux-E, Argon Filled

100MM S.S Butt hinge

Door Hardware: To be confirmed by client

Mortice Lock

Selected 2 Lever Mortice Lock - 44mm Backset

Architrave 1: 92x20 Moulded pine clears, painted, refer

A404 for profile Door Frame: H3.1 Pine clears painted, profiles to JMF

standard details

Exterior Facings: Ex 20mm H3.1, to match existing,

Glazed Door Frame: Cedar, painted, profiles to JMF

standard details

Joinery Suite JMF 7000 Series: Hinged & French Door to NZS4211

Awning Sash Sash Type

Fixed Sash

Hinged Door

Door Type

Hardware

Door Leaf

Joinery

Notes

Single Hinged Door

standard details

paint finish

Solid Core

100MM S.S Butt hinge

Door Frame: H3.1 Pine clears painted, profiles to JMF

Door Sill: Hardwood, painted finish to standard JMF

Exterior Facings: Ex 20mm H3.1, to match existing,

Joinery Suite JMF 7000 Series: Hinged & French Door to NZS4211

### **Baldwin Allen**



15 Everton Terrace, PO Box 12 232, Wellington 6144 ww.novakmiddleton.co.nz

Copyright in all drawings, specifications and other documents and in the work executed from them remains the property of Novak+Middleton Limited.

ISSUE:

Date:

Issued for Construction

Comments:

Scale: 1:50

Original size: A3

Designed | Drawn: RM / CS

File Reference: N:\2021\2104 Baldwin Allen\3.0-Drawi \230417\_CD\_BaldwinAllen\_CA Set.pln dwin Allen\3.0-Drawings\3.1-ArchiCAD\CA Drawing:

Exterior Door Schedule

Stage of Documentation: Detailed Design

Printed: 21/04/2023

Project number: 2104

Drawing number / Issue:

Head to line with WG 12

Line through

with WG 12 Awning

A603b