PROPOSED NEW DWELLING

465 Beauchamp St Maroubra NSW 2035

LANDSCAPE

15% Required Landscape: 46.45 m²

Front Landscape: 23.19 m² 50% Required at Rear Landscape: 36.83 m² **Rear Landscape:** 41.12 m² Total Landscape: 64.31 m²

GROSS FLOOR AREA (GFA)

ALLOWABLE GFA : 235M2 **GF**: 122.39 m² **FF :** 90.38 m² TOTAL PROPOSED : 212.77 m²

SITE AREA : 309.7 m²

ALLOWABLE HEIGHT : 8.5m

ALLOWABLE FSR: 0.75:1 PROPOSED FSR: 0.687:1

PROPOSAL DESCRIPTION

DEMOLITION OF EX STRUCTURES AND **BUILDING OF A NEW HOUSE WITH 4** BEDROOMS, 3 BATHROOMS, 1 GARAGE

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		2
		4
		10
		The second

SCALE

DRAWING No DRAWING NAME



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General Notes

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FILE: 230511_CURRENT FILE.pln

COMPLYING DEVELOPMENT ONLY - NOT FOR CONSTRUCTION



PROJECT: PROPOSED NEW DWELLING

465 Beauchamp St Maroubra NSW 2035 DRAWING: COVERPAGE

PROJECT NO: 2207 SCALE: SCALE: @A3 DRAWING NO: REV: PLOTTED: 18/5/2023

Building Specification	Fire safety: -	ENCLOSURE NOTES
	Fire separation - Part 3.7.1 of the BCA (Volume 2)	Waterproofing
465 BEAUCHAMP STREET, MAROUBRA NSW Property address:	 Fire separation - Separating wall construction - Part 3.7.1.8 of the BCA (Volume 2) Fire separation - Roof lights - Part 3.7.1.10 of the BCA (Volume 2) 	- External and Tanking Materials, design and i
The building works included in the subject application will comply with the relevant deemed-to- satisfy provisions of the Building Code of Australia 2014 (Volume 2- Housing Provisions) and relevant standards of construction.	 Smoke alarms - Part 3.7.2 of the BCA (Volume 2) and AS 3786 (2014) - Smoke alarms Heating appliances - Part 3.7.3 of the BCA (Volume 2) and AS 2918 (2001)- Domestic solid - fuel burning appliances - installation 	Roofing To AS 1562. Roof plumbing to AS 3500.3. Met C1.1.3.6 Cladding
Particular reference is made to the following BCA provisions and Australian Standards, which form part of the application and will be complied with: -	Health and amenity: - • Wet areas - Part 3.8.1 of the BCA (Volume 2) and AS 3740 (2010) - Waterproofing of wet areas in residential buildings	Windows / Glazed Doors All windows, sliding and bi-fold doors to be all manufacturer. Glazed assemblies in an external wall must co
Demolition: - • AS 2601(1991) - The demolition of structures	 Room heights - Part 3.8.2 of the BCA (Volume 2) Kitchen, sanitary and washing facilities - Parts 3.8.3.2 and 3.8.3.3 of the BCA (Volume 2) 	Performance Specification
Site Preparation: -	 Natural and artificial light - Parts 3.8.4.2 and 3.8.4.3 of the BCA (Volume 2) Ventilation - Part 3.8.5 of the BCA 	Glass type, thickness, materials and installation
 Earthworks - To be carried out in accordance with the requirements of the Environmental Planning & Assessment Act 1979, conditions of development consent and the relevant requirements of Part 3.1.1 of the BCA (Volume 2) Stormwater drainage - Part 3.1.2 of the BCA (Volume 2); and AS/NZS 3500 Q018) Part 3 - Stormwater drainage 	 Natural - Parts 3.8.5.2 and 3.8.5.3 of the BCA (Volume 2) Mechanical - Parts 3.8.5.0 and 3.8.5.3 of the BCA (Volume 2) Sound insulation - Part 3.8.6.1 of the BCA (Volume 2) Safe movement and access: -	Insulation + Sarking Fire hazard properties to comply with NCC C1 and thermal performance generally to AS 4850 Installation certificate to be provided showing Insulation to ceilings as noted, to comply with
AS/NZS 3500 (2018) Part 5 – Domestic installations – Section 5 – stormwater drainage Termite protection - Part 3.1.3 of the BCA (Volume 2); and	 Stair construction - Part 3.9.1.1 of the BCA (Volume 2) - Acceptable construction practice Balustrades - Part 3.9.2.1 of the BCA (Volume 2) - Acceptable construction practice 	Acoustic Insulation To satisfy the requirements of NCC Part F5.
AS 3660.1(2014) - Protection of buildings from subterranean termites	 Handrails – Part 3.9.2.4 of the BCA (Volume 2) - Acceptable construction practice Protection of openable windows – Part 3.9.2.5 of the BCA (Volume 2) - Acceptable construction practice 	INTERIOR
Footings and Slabs: - • Footings and slabs - Part 3.2 of the BCA (Volume 2); and • AS 2870 (2011) - Residential slabs and footings • AS 3600 (2018) - Concrete structures	Energy efficiency: - • Building Fabric - Part 3.12.1 of the BCA (Volume 2) • Building Sealing - Part 3.12.3 of the BCA (Volume 2)	Lining Plasterboard to AS 2588, installation to AS 25 Fire Hazard Properties of linings to comply wit
 AS 2159 (2009) - Piling – Design and installation Site classification Part 3.2.4 of the BCA (Volume 2) 	Services - Part 3.12.5 of the BCA (Volume 2) Swimming pool safety: -	Partitions Refer to drawing CD702 & CD703 for wall type
Masonry: - • Masonry construction - Part 3.3 of the BCA (Volume 2) and AS 3700 (2018) - Masonry Code • Lintels in masonry - Part 3.3.3.4 of the BCA (volume 2)	 Swimming pool safety fencing / barriers - Swimming Pools Act 1992 and Regulation 2008 and AS 1926 Part 1 (2012), Part 2 (2007) & Part 3 (2010) Structural design manuals: - 	Joinery Hardwood to AS 2796.3; Seasoned cypress p & 2271; Particleboard to AS 1859.1; MDF to A pressure laminate to AS 2924.1.
 Framing: - Sub-floor ventilation - Part 3.4.1 of the BCA (Volume 2) Steel framing - Part 3.4.2 of the BCA (Volume 2) Acceptable construction practice (Part 3.4.2.1 of the BCA) and / or AS 4100 (1998) - Steel structures Timber wall, floor and roof framing - Part 3.4 of the BCA (Volume 2); and AS 1684 (Q010) - Residential timber - frame construction Structural steel members - Part 3.4.4 of the BCA (Volume 2) 	 AS 1170.1 (1989) - Dead and live loads and load combinations AS 1170.2 (1989) or AS 4055 (1992) - Wind loads AS 1170.4 (1993) - Earthquake loads AS 1720.1 (1997) - Timber structures AS 2159 (1995) - Piling - design and installation AS 3600 (2001) - Concrete structures AS 4100 (1998) - Steel structures 	Kitchen and joinery assemblies to the general Fabricated Metalwork Aluminium structures to AS 1664; Welding gen Stairs, Ladders, Walkways Materials, design and construction of proprieta balustrades design loading in accordance with All stairs are to have solid risers, slip resistant AS2419.1-2009 Handrails shall be constructed to comply with
Roof and wall cladding: - • Roof tiling - Parts 3.5.1.1 & 3.5.1.2 of the BCA (Volume 2) and AS 2049 (2002) - Roof tiles • Metal roof sheeting - Parts 3.5.1.1 & 3.5.1.3 of the BCA (Volume 2) • Gutters and downpipes - Part 3.5.2 of BCA (Volume 2); and • AS/NZS 3500 (2018) Part 3 – Stormwater drainage • AS/NZS 3500 (2018) Part 5 – Domestic installation		FINISHING Plastering Cement to AS 3972; Sand to Lathing to AS 13 Cementitious Toppings Cement to AS 3972; Lathing to AS 1397; Adm to AS 1379; AS 3661 for slip resistance of ped
Wall cladding - Part 3.5.3 of the BCA (Volume 2) Glazing: -		 Waterproofing Internal Waterproofing to be undertaken in accordance
• Glazing - Part 3.6 of the BCA (Volume 2) • AS 1288 (2006) Glass in buildings • AS 2047 (2014) Windows in buildings		Ceramic Tiling General tiling to the requirements of AS 3958; Adhesives to AS 2358 and AS 4992.1.
		Resilient Finishes Critical radiant flux and smoke development ra set out in AS ISO 9239.1.
		Carpets Critical radiant flux and smoke development r set out in AS ISO 9239.1. For carpet materials fixing methods and cleaning refer to AS 2455.
		Painting + Textured Membrane Coatings General painting requirements to AS 2311; De refer to AS 2633; Coating types to AS 4548; A requirements.

Powder Coatings

Application to aluminium and aluminium alloy substrates to AS 3715; Application to other metal substrates to AS 4506; Application to be in accordance with manufacturers requirements.

General Notes

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nd installation to AS 4654

Metal rainwater goods to AS 2179; Rooflights to NCC Spec

aluminium framed – powdercoat finish by an approved comply with AS2047 and BASIX Certificate and Thermal

ation to AS1288; To comply with BASIX and ABSA requirements

C1.10 and Spec C1.10; Sarking material to AS 4200; Insulation 1859; Welded safety mesh to AS 4389. ng compliance with BASIX requirements and AS 4859. *v*ith BASIX requirements.

2589; Fibre cement to AS 2908.2. with Specification C1.10 of the NCC Building Code of Australia

types and lining details; Light steel framing to AS 4600.

s pine to AS 1810; Softwood to AS 4785.3; Plywood to AS 2270 o AS 1859.2; Decorative overlaid panels to AS 1859.3; High ral requirements of AS 4386.

generally to AS 1554.

etary stair systems to AS 1657; Pipe rail and flat bar vith AS 1170. ant surfaces throughout in accordance with clause 11 of

ith Clause 12 of AS1428.1

1397.

dmixtures to AS 1478; Aggregate to AS 2758; Concrete to class pedestrian surfaces.

nce with NCC part F1.7 and AS 3740. Membranes to AS 4858.

58; Slip resistance classification to AS 4586; Tiling to AS 4662;

rate of selections to comply with NCC requirements and those

rate of selections to comply with NCC requirements and those als including broadloom carpet, carpet tiles and underlay, their 55

Definitions to AS 2310; For decorative painting and colours, ; Application to be in accordance with manufacturers

COMPLYING DEVELOPMENT ONLY - NOT FOR CONSTRUCTION

PROJECT: PROPOSED NEW DWELLING 465 Beauchamp St

Maroubra NSW 2035 DRAWING: SPECIFICATION

PROJECT NO: 2207 SCALE: SCALE: @A3 DRAWING NO: REV: PLOTTED: 18/5/2023

GENERAL NOTES

1.ALL WORKS TO BE IN ACCORDANCE WITH THE BUILDING CODE OF AUSTRALIA, AUSTRALIAN STANDARDS, STATUTORY REGULATIONS AND LOCAL AUTHORITY REQUIREMENTS, INCLUDING CONDITIONS OF CONSENT AND CDC GUIDELINES.

2. DO NOT SCALE OFF THIS DRAWING. ONLY USE DIMENSIONS PROVIDED.

3. CONTRACTOR TO VERIFY ALL DIMENSIONS ON SITE PRIOR TO COMMENCING WORK.

4. MOWA DRAWINGS TO BE READ IN CONJUNCTION WITH ALL CONTRACT DOCUMENTS FROM ALL CONSULTANTS.

5. CONTRACTOR TO NOTIFY MOWA OF ANY DISCREPANCIES, DIMENSIONAL INCONSISTENCIES, OR THE NEED FOR CLARIFICATION PRIOR TO MANUFACTURING.

6. CONTRACTOR TO ENSURE CONSISTENCY BETWEEN MATERIALS IS MAINTAINED

7. MOWA TO REVIEW ALL CONTRACTOR'S DETAILED DRAWINGS / SETTING OUT PRIOR TO CONSTRUCTION.

8. PROGRESS WORK TO BE VERIFIED AGAINST DRAWINGS FOLLOWING EXECUTION AND ARCHITECT TO BE NOTIFIED OF ANY DISCREPANCIES PRIOR TO CONTRACTOR PROCEEDING WITH NEXT TRADE.

ALL CONSTRUCTION TO COMPLY AT MINIMUM W/ BCA CLAUSES & AUSTRALIAN STANDARDS.

CLAUSE B 1.4 MATERIAL & FORMS CONSTRUCTIONS SPEC. C1.1 FIRE RESISTING CONSTRUCTION SPEC. C1.10 FIRE HAZARD PROPERTIES SPEC. C.11 PERFORMANCE OF EXTERNAL WALLS IN A FIRE CLAUSE C2.6 VERTICAL SEPARATION OF OPENINGS IN EXTERNAL WALL CLAUSE C2.12 SEPARATION OF EQUIPMENT CLAUSE C2.13 ELECTRICITY SUPPLY SYSYEM CLAUSE C2.13 GOINGS AND RISERS CLAUSE D2.14 LANDINGS CLAUSE D2.14 BALUSTRADES CLAUSE D2.17 HANDRAILS CLAUSE D2.17 HANDRAILS CLAUSE D2.10 OPERATION OF LATCH CLAUSE D2.17 WATERPROOFING OF WET AREAS CLAUSE F1.7 WATERPROOFING OF WET AREAS	
CLAUSE F5.4 SOUND INSULATION OF FLOORS CLAUSE F5.5 SOUND INSULATION OF WALLS CLAUSE F5.6 SOUND INSULATION OF SERVICES CLAUSE F5.7 SOUND INSULATION OF PUMPS	
ARTIFICIAL LIGHTING: TO COMPLY WITH BCA PART CLAUSE F4.4 & AS1680 BALUSTRADE HEIGHTS: TO COMPLY WITH BCA CLAUSE D2.16 DRAINAGE GUTTERS & DOWNPIPES: TO COMPLY WITH AS/NZS 3500 HOT WATER: SYSTEMS TO COMPLY WITH PART J7 OF BCA MASONRY: TO COMPLY WITH AS3700 MECH/ELEC/HYDRAULIC: BCA CLAUSE C3.15 & AS1530 4-2005 MECH/ELEC/HYDRAULIC: BCA CLAUSE C3.15 WITH BASIX REQUIREMENTS	
MECHANICAL EXHAUST VENTILATION: TO COMPLY WITH AS1668 & AS68.2 SMOKE ALARMS: TO COMPLY WITH BCA PART CLAUSE & SPEC E2.2.8 AS3786	

SMOKE ALARMS: TO COMPLY WITH BCA PART CLAUSE & SPEC E2.2 & AS3786 PENETRATIONS: THROUGH FIRE RATED CONSTRUCTION FOR MECH/ELEC/HYDRAULIC PENETRATIONS TO COMPLY WITH BCA CLAUSE C3.15 & AS1530 4-2005 SOUND TRANSMISSION: TO COMPLY WITH PART5 OF BCA STAIR CONSTRUCTION: TO COMPLY WITH BCA CLAUSE D2.13 WATERPROOFING OF WET AREAS: TO COMPLY WITH AS3740

Abbreviations

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	A	BWK	Brickwork	CPF	Concrete Polished Finish	EP	Edge Protection	GBR	Garbage Room	JF	Joinery Finish	MRR	Mirror Reverse	REP	Recessed Edge Pull	SO	Structural Opening	TRH	Toilet Roll Holder
	Align	BY	Balcony	CRT	Corner Trim	(EX)	Existing	GC	Glass Clear	<u><u><u></u>]H</u></u>	Joinery Hardware	MRV	Medium Rigid Vehicle	RES	Residential	SOP	Set Out Point	TSA	Tenant Supply Air
4)	Acoustic			CPL	Cover Plate	EXJ	Express Joint	GD	Glass, Decorative	JP	Joinery Pull	MSB	Main Switch Board Services Incl. Main Distribution Board & Frame.	RF	Refrigerator	SP	Stair Pressurisation	TWF	Timber Wall Finish
C	Air Conditioning		c	CS	Ceiling Suspended	EXH	Exhaust	GDR	Grated Drain			BI	Bollard	REF	Resilient Floor Finish	SPD	Spoon Drain	TYP.	Typical
C	Accessible	CAP	Capping	CSF	Cementitious Screed Finish	(EXP)	Exposed	GE	Grooved Edge		к	MTR	Meter	RH	Range Hood	SPT	Spout		rypical
CS	Access Control System	CPF	Concrete Polished Finish	CSK	Countersunk			GHR	Garbage Holding Room		Kitchen	MV	Mechanical Vent	RHS	Rectangular Hollow Section	SS	Stainless Steel		
2	Access Deck	CBC	Cubicle System	CSNF	Concrete Stencil Finish		F	GL	Ground Line			MV1							
DP	Adaptable	CBF	Concrete Broom Finish	CPT	Carpet	F	Fire Services	GPT	Gross Pollutant Trap	KB	Kerb	MVJ	Movement Joint	RL	Relative Level to AHD	SQE	Square Edge	U/G	Underground
	Access Hatch	CEA	Concrete Exposed Aggregate Finish	CST	Concrete Steel Trowel Finish	FB	Flush Button (Cistern)	GR	Grab Rail	KE	Kitchen Exhaust			RTL	Retail	(SR)	Semi Recessed	U/S	Underside
ID	Australian Height Datum	CF	Critical Face	СТ	Cleaners trolley	FC	Fibre Cement	GT	Glass, Translucent	KSF	Car key Safes		N	RU	Receptacle Unit	SS	Stainless Steel	UA	Unequal Angel
	Aluminium	CFC	Compressed Fibre Cement	CTFF	Ceramic Tile Floor Finish	FCC	Fire Control Centre	GCI	Glass Clear Internal			NGL	Natural Ground Level	RWH	Rain Water Head	SSCN	Shower Screen	UCT	Under Cut
IB	Ambulant	CFF	Concrete Float Finish	CTWF	Ceramic Tile Wall Finish	FCL	Finish Ceiling Level				L	NOM	Nominal	RWO	Rainwater Outlet	SSD	Sub-Surface Drainage System	UG	Upper Ground
	Access Panel	CGF	Concrete Groove Finish	CVJ	Coved Junction	FCR	Fire Control Room		н	L_01,02	Lift No.1, 2, etc.					SSL	Structural Slab Level	UNO	Unless Noted Otherwise
P	Anti-Slip Plate	СН	Ceiling Height	CWB	Car Wash Bay	FCU	Fan Coil Unit (AC)	н	Hydraulic Services	L	Living		0		S	ST_01	Stair No.1, 2, etc.	UT	Utility Space
VN	Awning	CHE	Chamfered Edge	CWS	Cold Water Supply	FEP_01,02	Fire Egress Passage No.1, 2, etc.	HC	Hose Cock	LB	Letterbox	(0)	Operable	s	Store	STL	Steel	UR	Urinal
		CHS	Circular Hollow Section			FES	Floor Edge Strip	HD	Handle	LCB	Lift Call Button	OFS	Overflow Spout	S	Storage	STN	Stair Nosing		
	В	(CI)	Cast In		D	FEX	Fire Extinguisher	HDR	Hand Dryer, Electric	LCL	Lift Call Lantern	OSD	On Site Detention Tank	SA	Supply Air	STY	Study		v
	Bathroom	CIS	Cistern	D	Dining	FFL	Finished Floor Level	HIR	High Impact Resistant	LG	Lower Ground	OSR	On Site Retention Tank	SB	Splash Back	SWD	Stormwater Drain	v	Void
2	Bedroom 1, Bedroom 2, etc.	CJ	Control Joint	DB	Distribution Board	FG	Fixed Glass	НК	Hook	LP	Low Point	OV	Oven	SCN	Screen	SWF	Stone Wall Finish	VIS	Visitor
_	Balustrade	СКТ	Cook Top	DG	Drip Groove	FGL	Finished Ground Level	HMR	High Moisture Resistance	LRA	Lobby Relief Air			SCOL	Steel Column	SWP	Stormwater Pit	VP	Vent Pipe
5	Box Gutter	CL	Centre Line	DJ	Dummy Joint	FH	Fire Hydrant	HP	High Point	LSA	Lobby Supply Air		Р	SD	Sliding Door	SCP	Stone Carpet Joint Profile	VB	Vehicle Bumper
s	Boom Gate System	CLD	Cladding	DP	Down Pipe	FHR	Fire Hose Reel	HR	Handrail	LT	Laundry Tub	Р	Pantry	SDH	Soap Dish Holder	SH	Shelf		
1	Bulkhead	CLK	Cloak Room	DPC	Damp Proof Course	FIP	Fire Indicator Panel	HRV	Heavy Rigid Vehicle	LV	Louvre	PB	Plasterboard	SDO	Spoon Drain Outlet	_			w
	Butt Joint	CLNR	Cleaner Store	DRY	Dryer	FLB	Floor Box	HWS	Hot Water Service	LY	Laundry	PCF	Powder Coat Finish	SDSP	Soap Dispenser	_	т	w	Waste
Р	Bicycle Parking	CMF	Concrete Micro Finish	DRW	Drawer	FLS	Flashing	HWU	Hot Water Unit	LK	Locker	PD	Pivot Door	SEC	Security Services	(T)	Thermal	WC	WC
R	Bicycle Rack	CMR	Cement Render	DW	Dishwasher	FMP	Fire Mimic Panel			LKS	Locker Seat	PDO	Planter Drainage Outlet	SFF	Stone Floor Finish	TCE	Terrace	WC_A	WC Accessible
s	Bicycle Storage	CNR	Corner	DWF	Decorative Wall Finish	FN 01.02	Furniture Type 01, 02, etc.		I	1		PEL	Pelmet	SGN	Signage	TD	Timber Deck	WC_F	WC - Female
											м	PI	Pit	SHS	Square Hollow Section	TDSP	Towel Dispenser Unit	WC_M	WC - Male
	Bollard	COF	Concrete Off-Form Finish	DPG	Down Pipe Guard	FRL	Fire Resistance Level	IB	Iron Board	м	Mechanical Services	PF	Paint Finish	SHP	Speed Hump	TE	Tooled Edge	WC_U	WC - Unisex
<	Blockwork	COL	Column			FS_01,02	Fire Stair No.1, 2, etc.	ID	Inside Diameter	MATV	Master Antenna Television Service	PV	Paving	SHR	Shower	TFF	Timber Floor Finish	WIR	Walk in Robe
	Bump Rail	СОМ	Commercial		E	FW	Floor Waste	IKS	Inksinerator waste disposal	MBP	Motor Bike Parking	PW	Partition Wall	SHRC	Shower Cubical	TFW	Trade Floor Waste	WM	Washing Machine
wo	Balcony Rain Water Outlet	COMS	Communications Services	E	Entry	FSP	Flooring Separation Profile	IL	Invert Level	MBX	Mail Box Assembly			SHRR	Shower Rose	TGSi	Tactile Ground Surface Indicator	WP	Weatherproof
N	Basin	CONC	Concrete	EA	Equal Angle			INS	Insulation	MDR	Metal Deck Roofing		R	SIM	Similar	тн	Threshold	WPM	Waterproof Membrane Syste
,	Bath Spout	COS	Check on Site	EFF	Epoxy Floor Finish		G	IO	Inspection Opening	MDSP	Multi-use Dispenser Unit	R	Robe	SJ	Silicon Joint	TND	Tundish	WS	Wheel Stop
	Benchtop	CP	Car parking Space	EJ	Expansion Joint	GA 01,02	Grease Arrestor No.1, 2, etc.			MGB	Mobile Garbage Bin	(R)	Recessed	SK	Sarking	TOW	Top of Wall	WR	Wardrobe Rail
н	Bath	CPC	Concrete Precast	ELEC	Electrical Services	GAL	Galvanised		L	MJ	Mitre Joint	RA	Return Air	SKL	Skylight	TPS	Tap set	End.	
P	Bottle Trap	CPD	Cupboard	EM	Entry Mat	GB	Gas Bayonet	J_01,02.	Joinery Type 01, 02, etc.	MOV	Microwave Oven	RASS	Roof Access Safety System	SKT	Skirting	TR	Towel Rail		
R	Boundary Trap	CPE	Car Park Exhaust	EN	Ensuite	GBC	Garbage Chute	јв	Jamb	MR	Mirror	RD	Roller Door	SNK	Sink	TRA	Tenant Return Air		

General Notes

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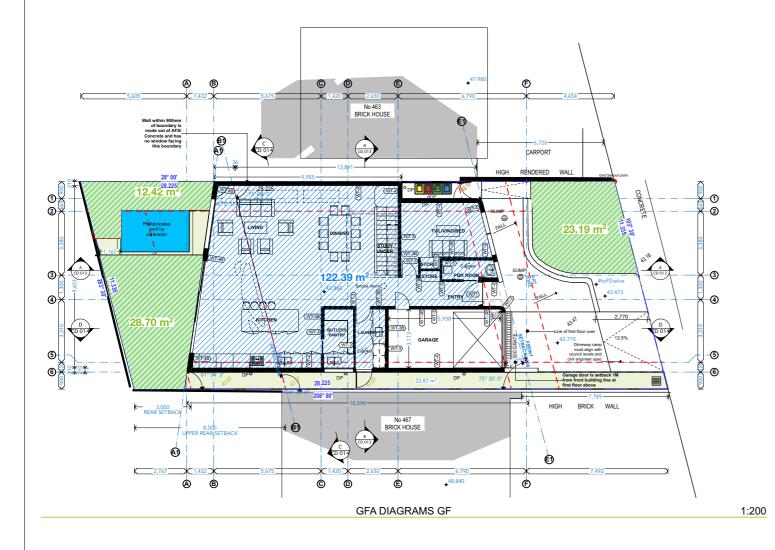
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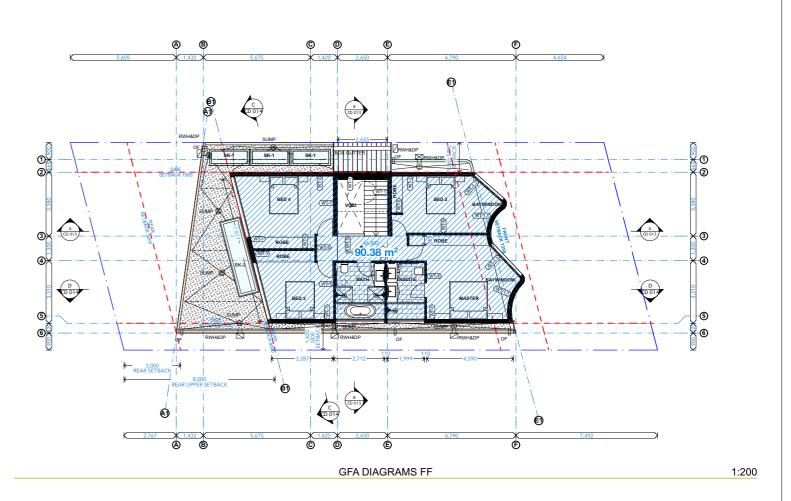


PROJECT: PROPOSED NEW DWELLING 465 Beauchamp St Maroubra NSW 2035 DRAWING: NOTES AND LEGEND PROJECT NO: 2207 SCALE: 1:1 @A3 DRAWING NO: REV: PLOTTED: 18/5/2023

CD 002

PROJECT:





LEGEND



LANDSCAPE

15% Required Landscape: 46.45 m²

Front Landscape: 23.19 m² 50% Required at Rear Landscape: 36.83 m² Rear Landscape: 41.12 m²

Total Landscape: 64.31 m²



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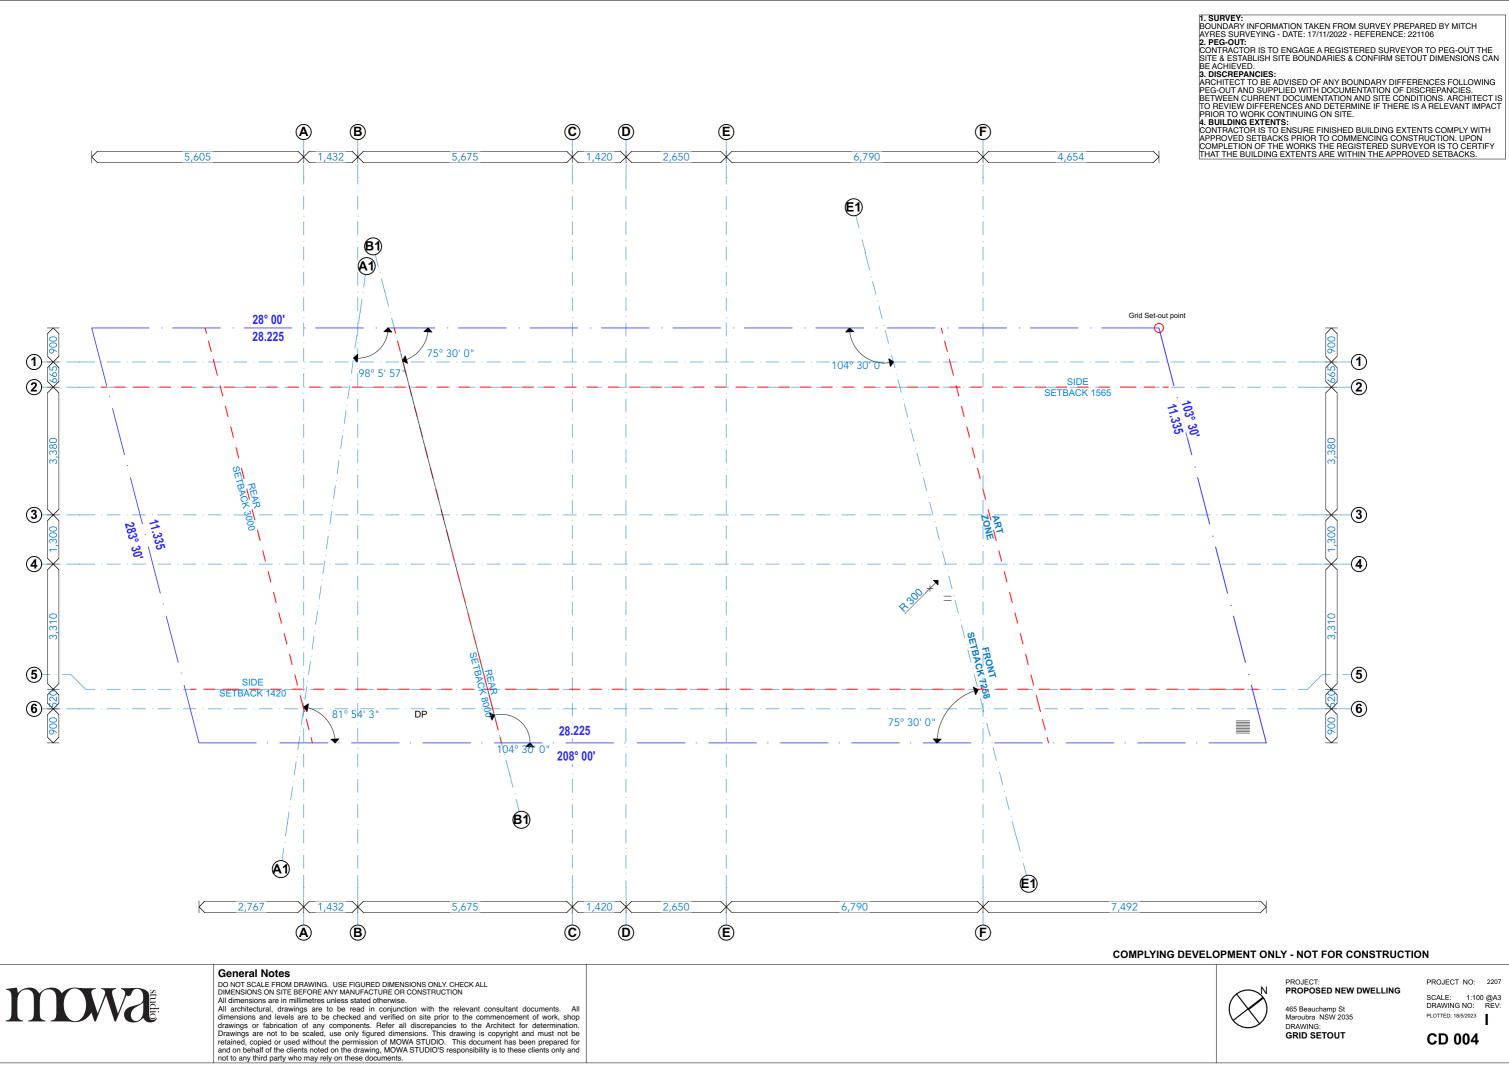
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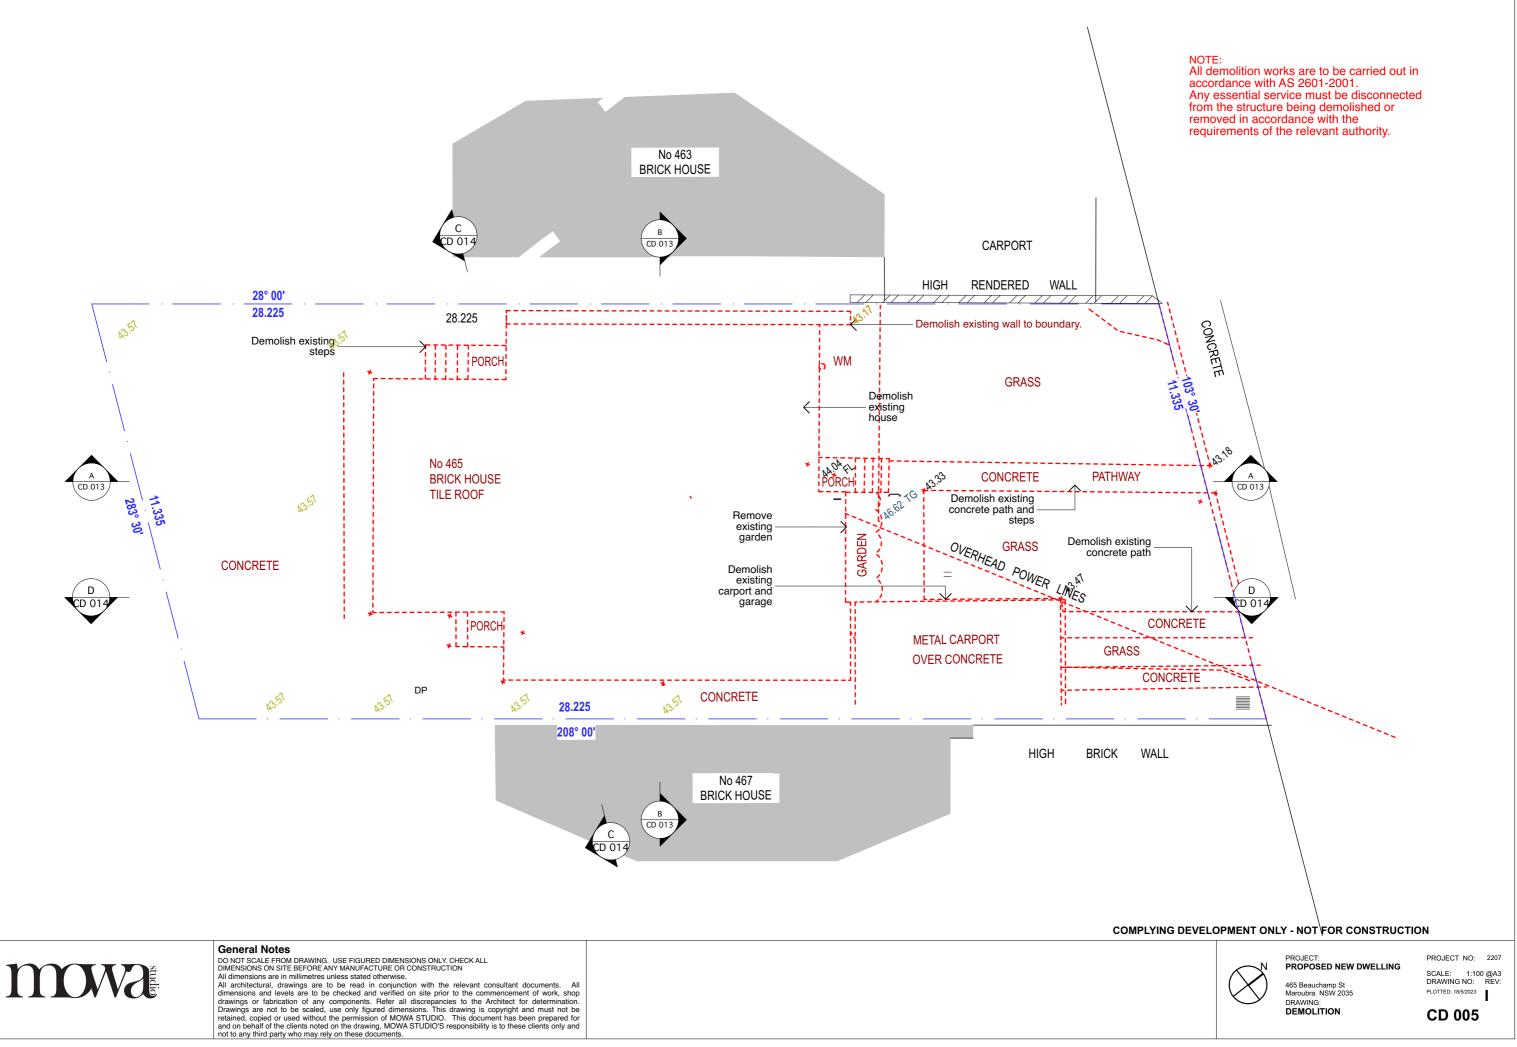



PROJECT: PROPOSED NEW DWELLING


465 Beauchamp St Maroubra NSW 2035 DRAWING: GFA/LANDSCAPE DIAGRAMS


PROJECT NO: 2207 SCALE: 1:1 @A3 DRAWING NO: REV: PLOTTED: 18/5/2023





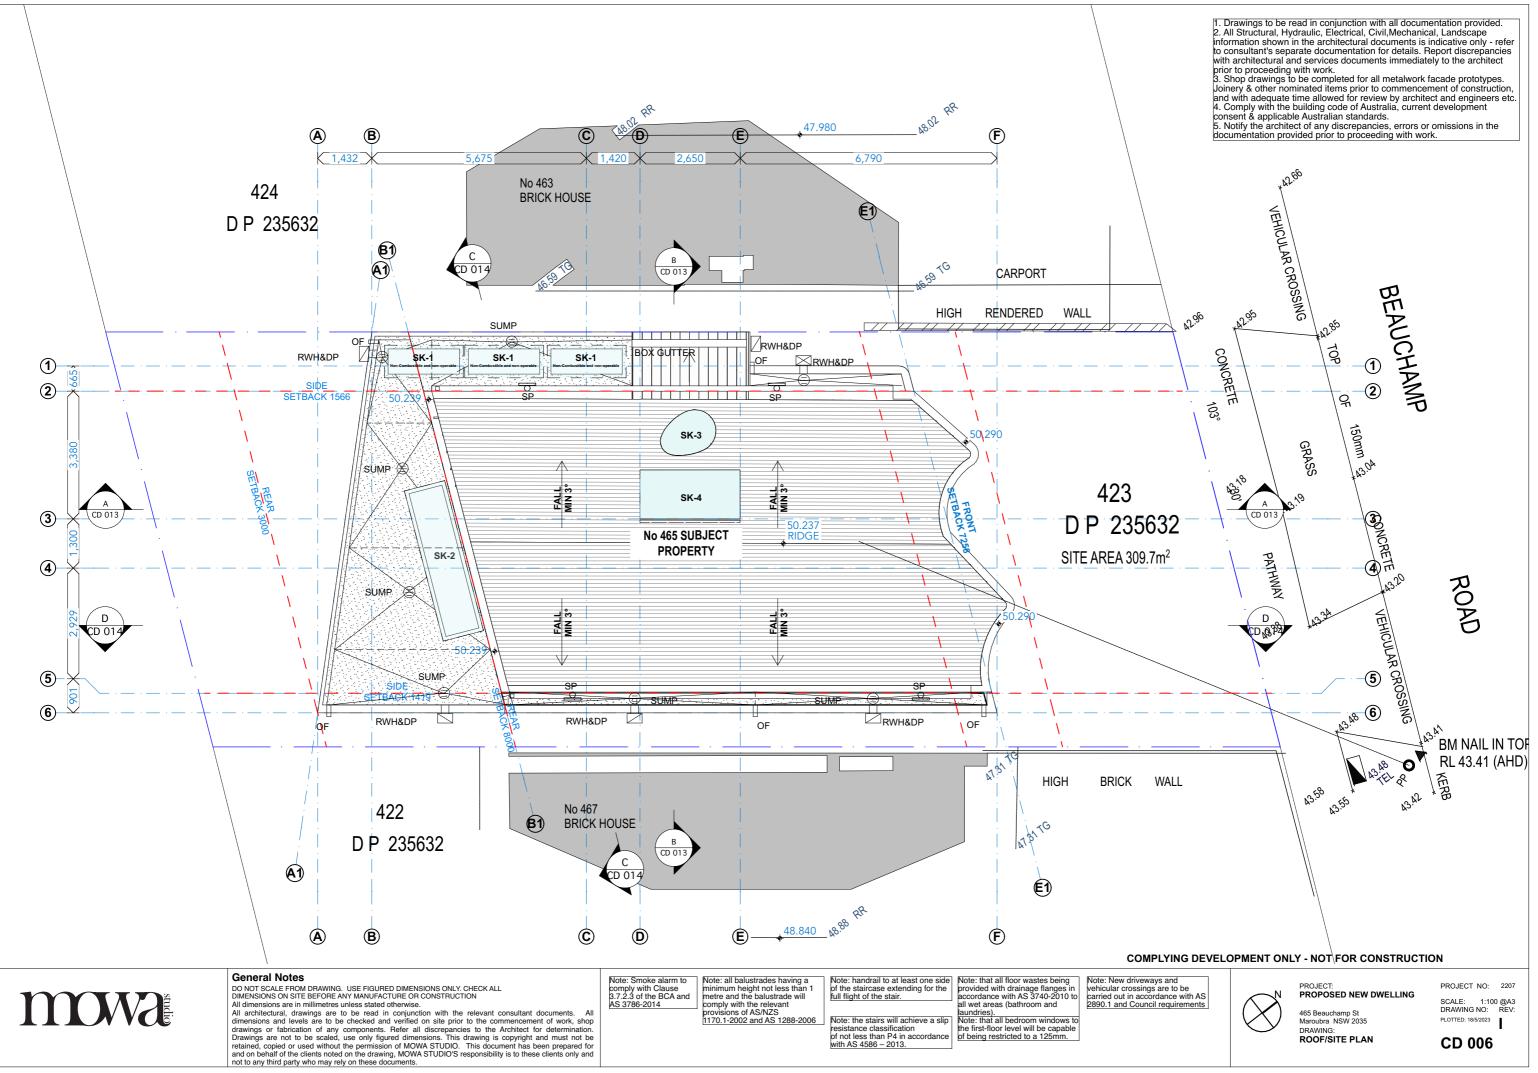

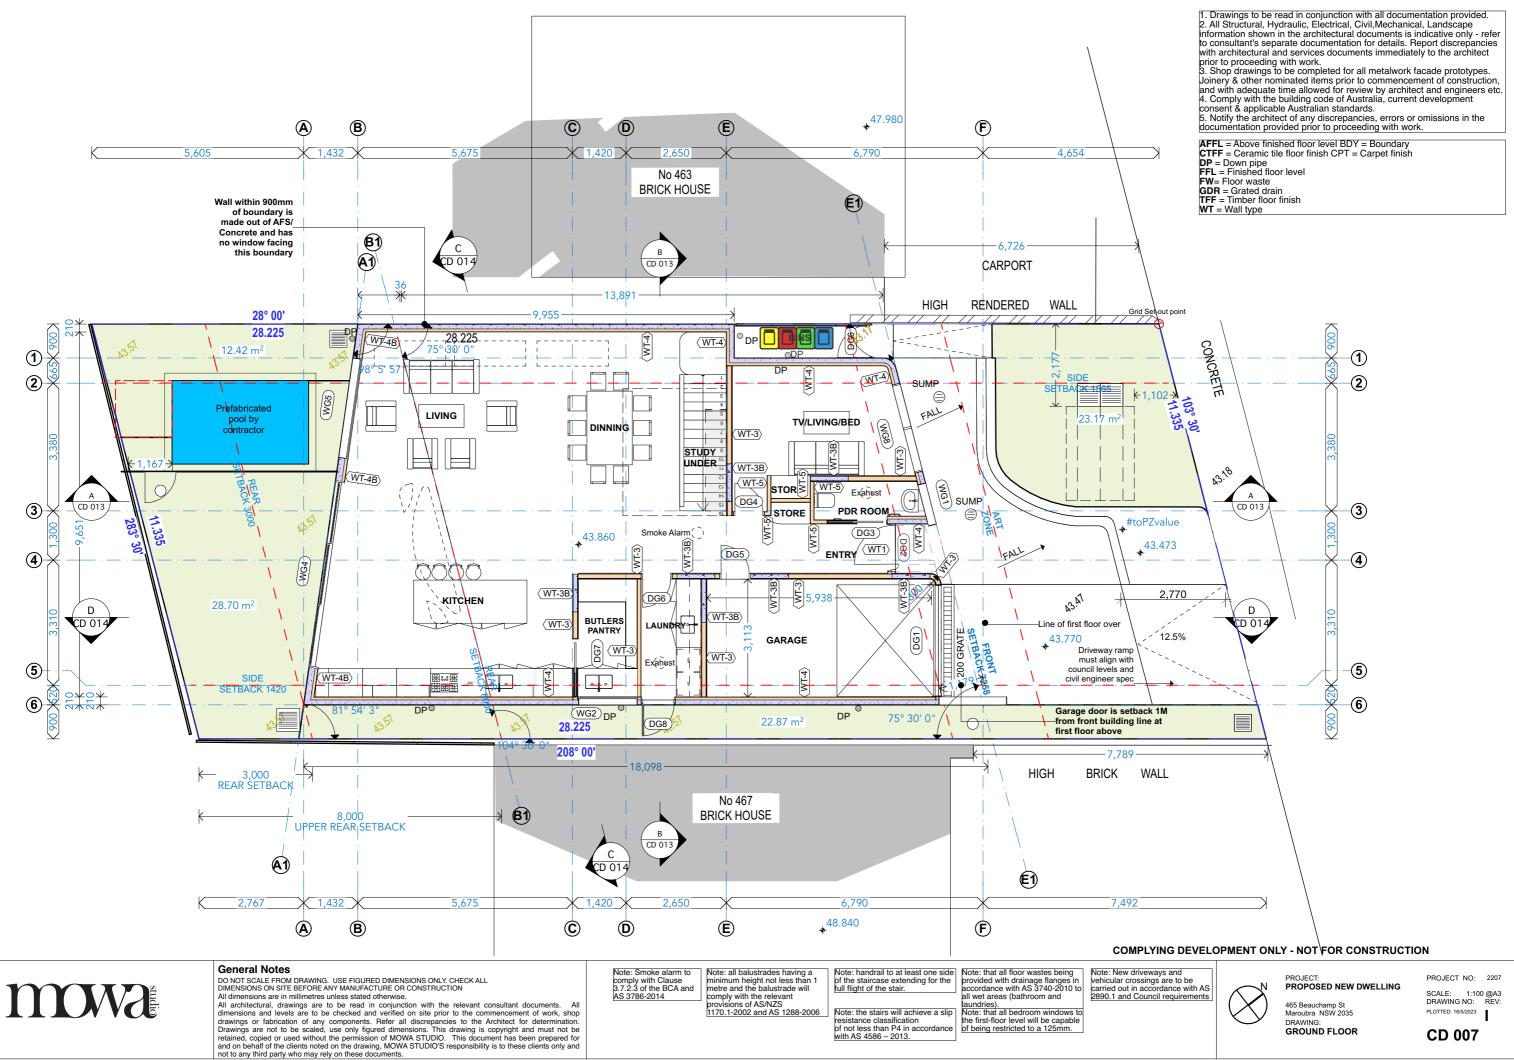

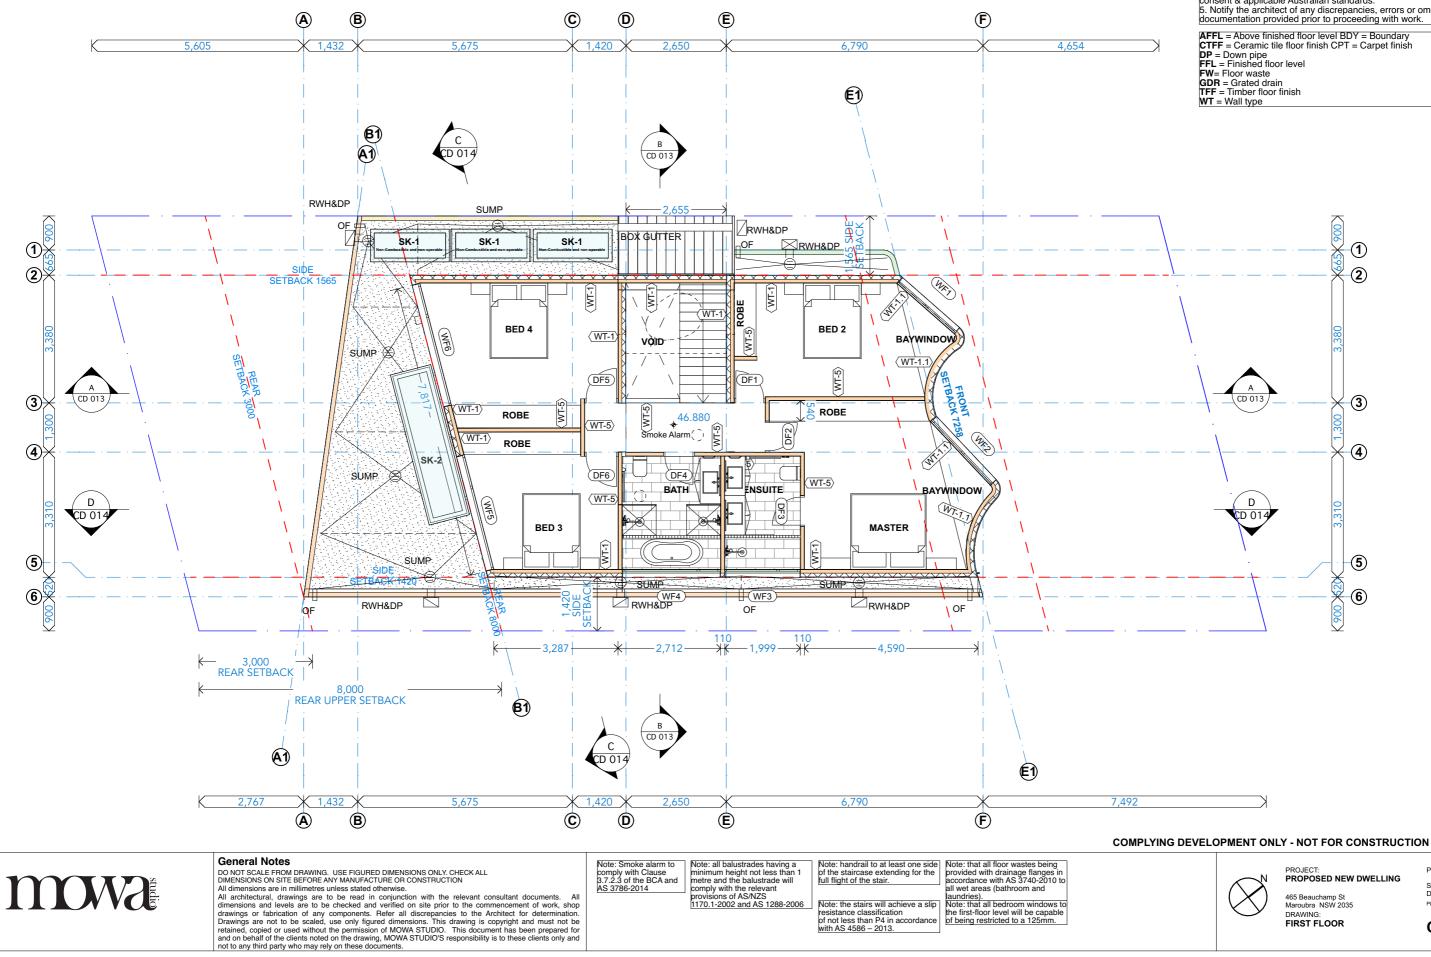

1. Drawings to be read in conjunction with all documentation provided. All Structural, Hydraulic, Electrical, Civil, Mechanical, Landscape information shown in the architectural documents is indicative only - refer to consultant's separate documentation for details. Report discrepancies with architectural and services documents immediately to the architect prior to proceeding with work. 3. Shop drawings to be completed for all metalwork facade prototypes.

Joinery & other nominated items prior to commencement of construction, and with adequate time allowed for review by architect and engineers etc. Comply with the building code of Australia, current development consent & applicable Australian standards.

Notify the architect of any discrepancies, errors or omissions in the documentation provided prior to proceeding with work.

PROJECT NO: 2207 SCALE: 1:100 @A3 DRAWING NO: REV: PLOTTED: 18/5/2023



Front Elevation

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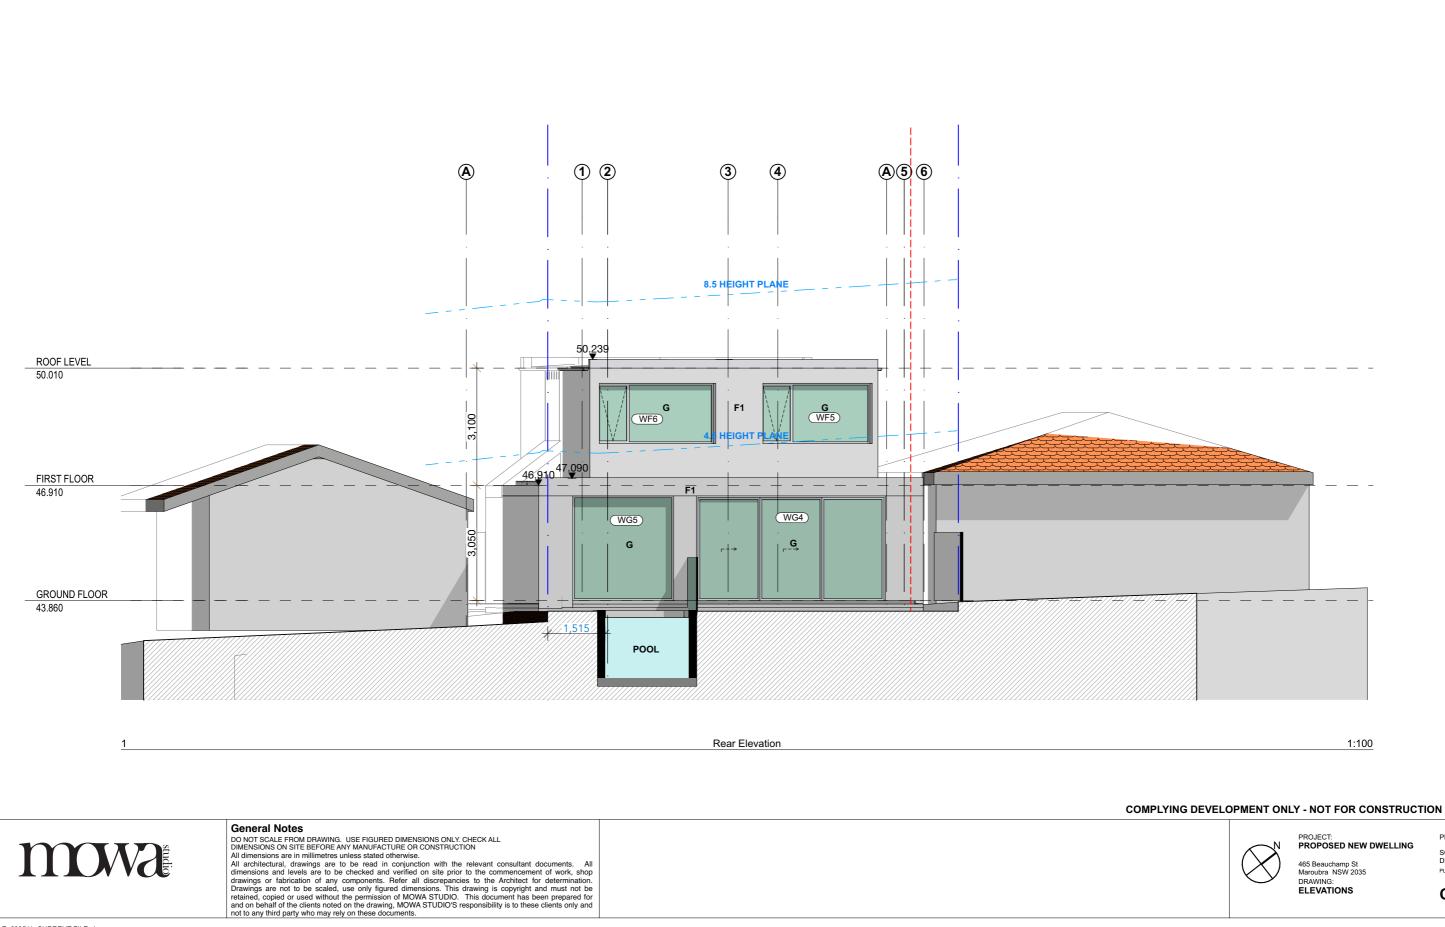
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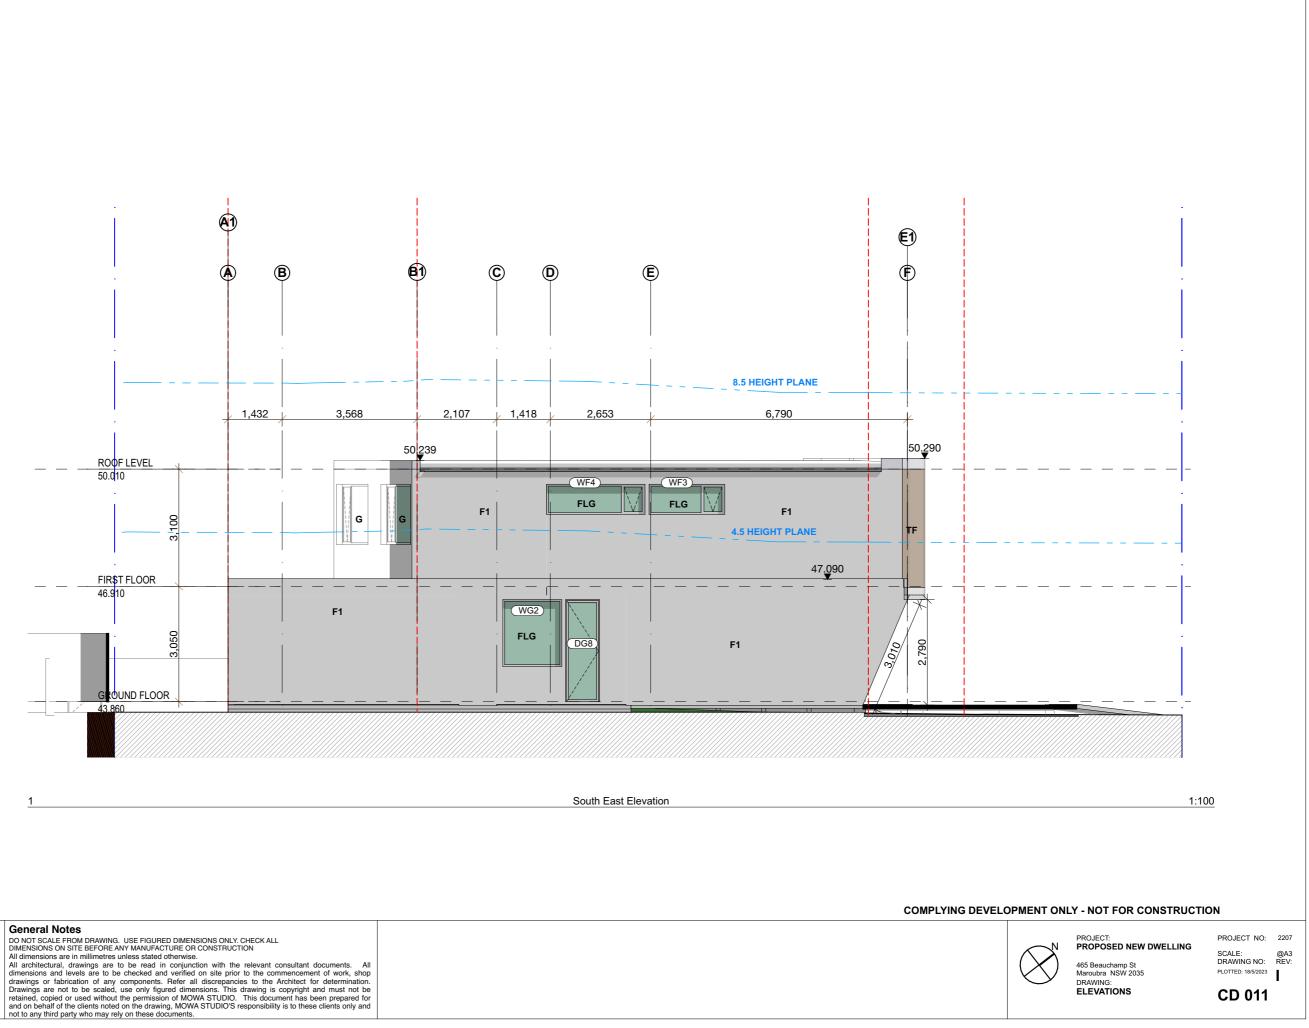
PROJECT: PROPOSED NEW DWELLING

465 Beauchamp St Maroubra NSW 2035 DRAWING: ELEVATIONS











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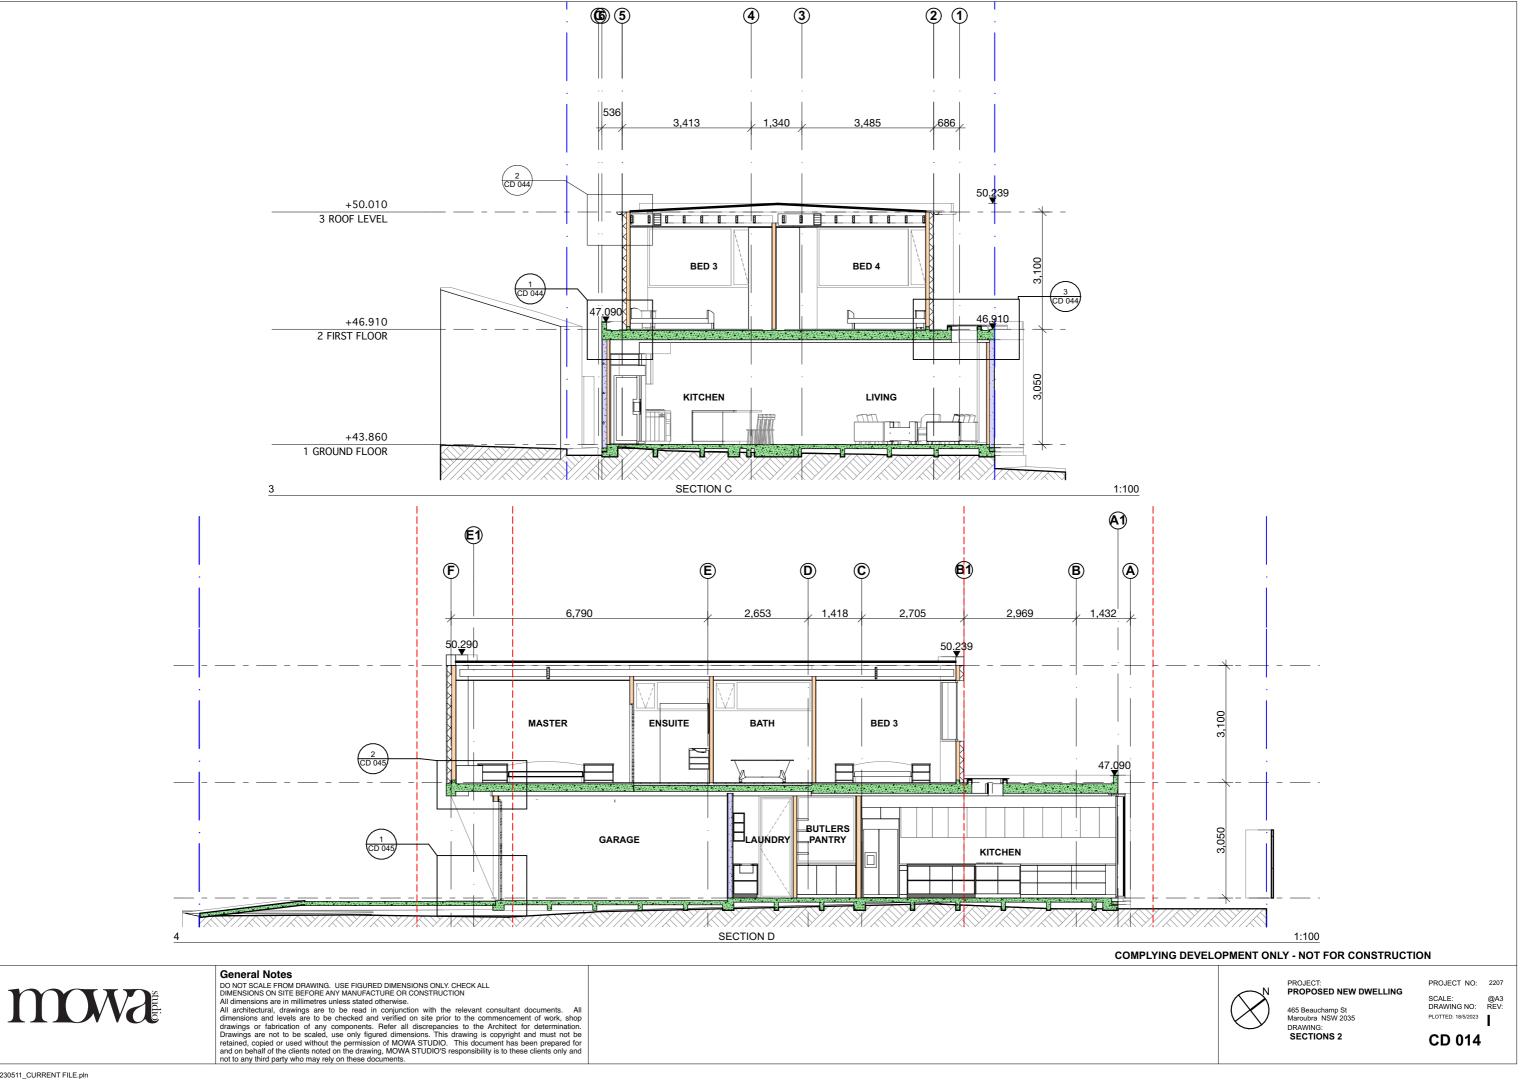
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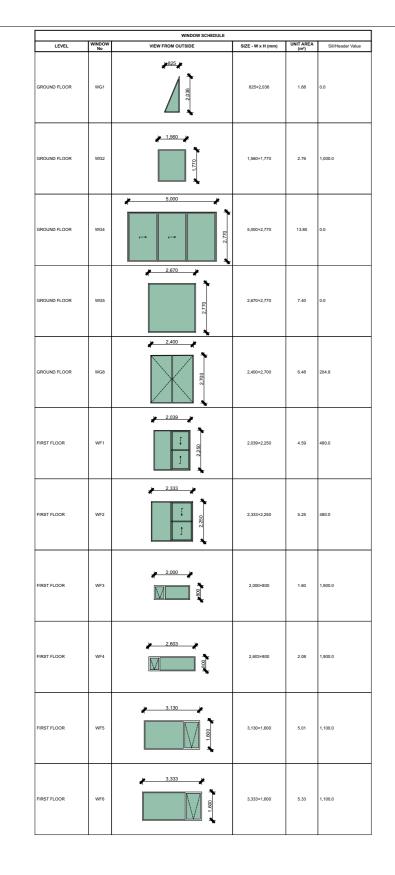


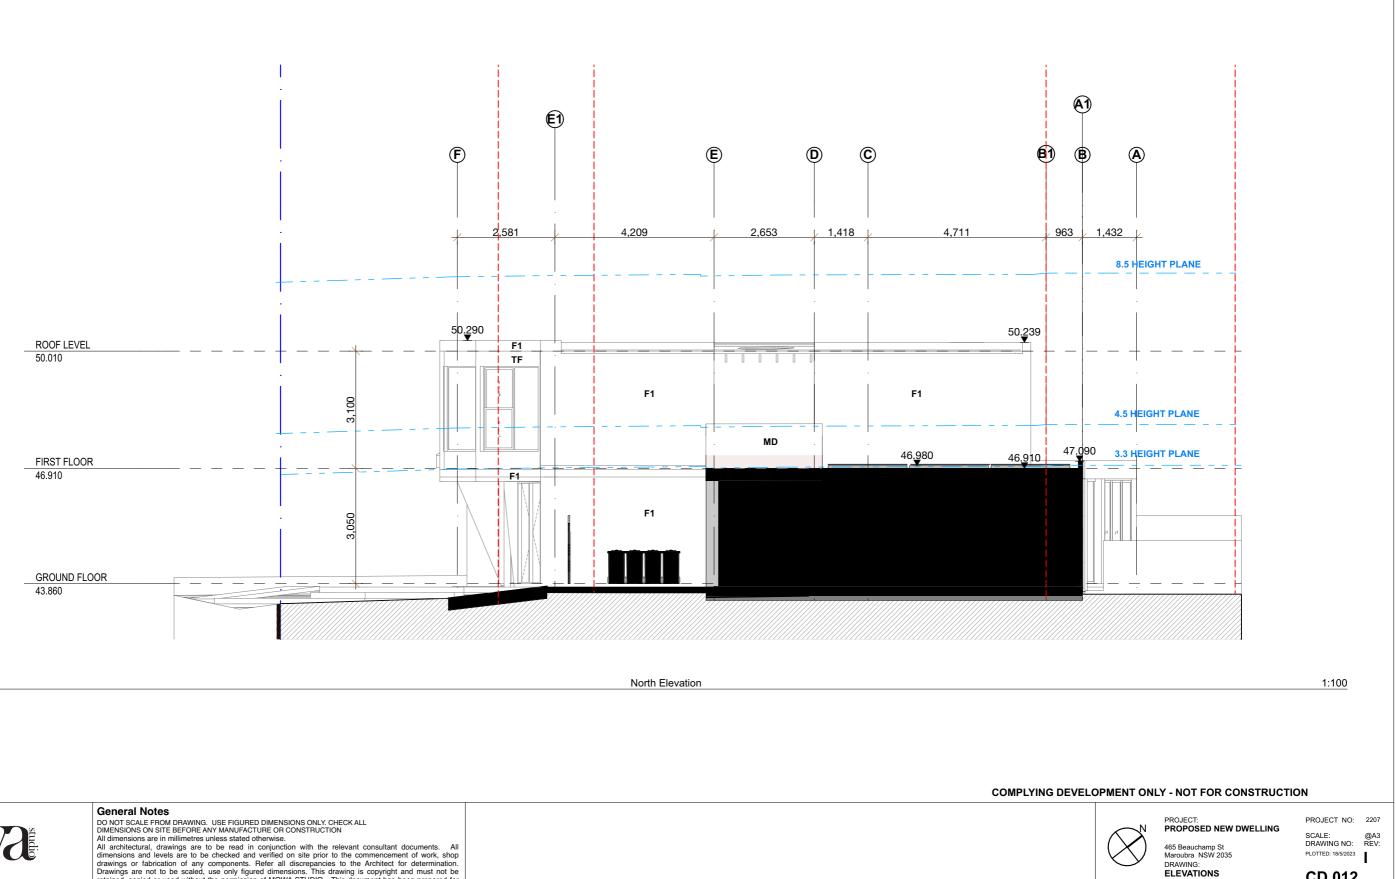
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465 Beauchamp St Maroubra NSW 2035 DRAWING: SECTIONS





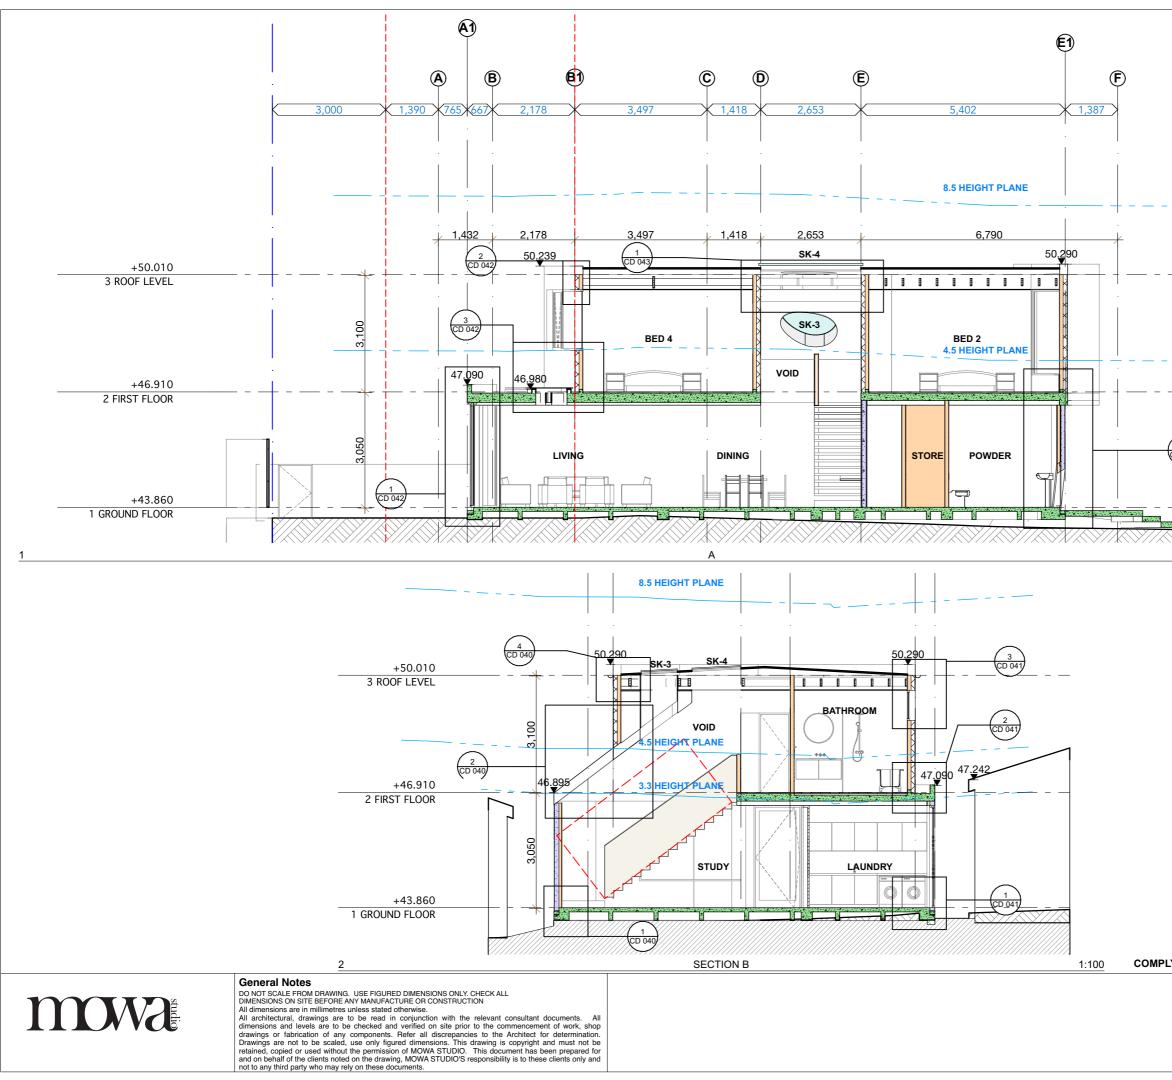

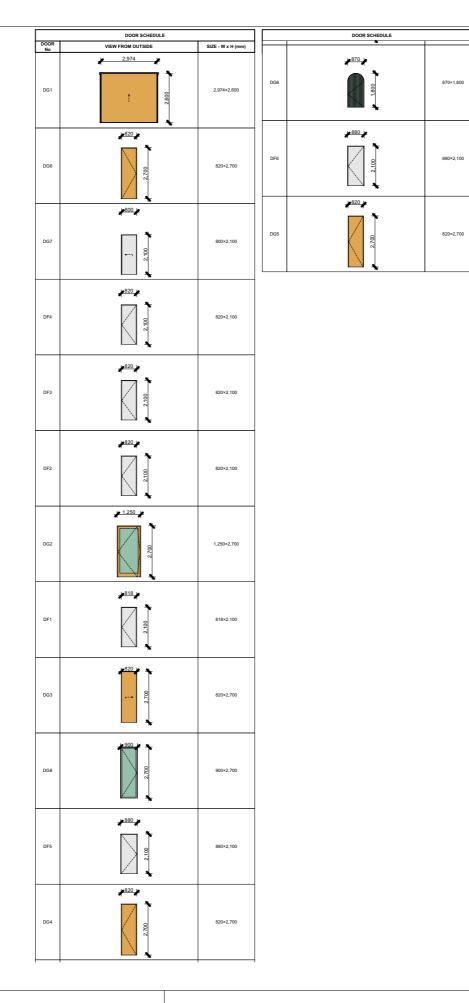

General Notes

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PROJECT: PROPOSED NEW DWELLING

465 Beauchamp St Maroubra NSW 2035 DRAWING: DOOR & WINDOW SCHEDULE CD 015

	Project name Street address		Beauchamp St Maroubra Street Maroubra 2035		Description	of project	
ngle Dwelling	Local Government Area	Randwick City Co	ouncil		Description	or project	
ficate number: 1372167S	Plan type and plan number Lot no.	deposited 235632 423	<u>.</u>		Project address		Assessor details and t
certificate confirms that the proposed development will meet the NSW mment's requirements for sustainability, if it is built in accordance with the	Section no. Project type	- separate dwelling	house		Project name Street address	Dwelling @ 465 Beauchamp St Maroubra 465 Beauchamp Street Maroubra 2035	Assessor number Certificate number
mitments set out below. Terms used in this certificate, or in the commitments, the meaning given by the document entitled "BASIX Definitions" dated 9/2020 published by the Department. This document is available at	No. of bedrooms Project score	4			Local Government Area Plan type and plan number	Randwick City Council Deposited Plan 235632	Climate zone Area adjusted cooling load (MJ/
basix.nsw.gov.au	Water	✔ 40	Target 40		Lot no. Section no.	423	Area adjusted heating load (MJ) Ceiling fan in at least one bedro
etary of issue: Friday, 10 February 2023 • valid, this certificate must be lodged within 3 months of the date of issue.	Thermal Comfort Energy	V Pass	Target Pass		Project type Project type	separate dwelling house	Ceiling fan in at least one living other conditioned area
Planning,	Energy	✓ 52	Target 50		No. of bedrooms	4	Project score
Industry & Environment					Site details Site area (m²)	310	Thermal Comfort
					Roof area (m ²) Conditioned floor area (m2)	153 194.0	Energy
					Unconditioned floor area (m2) Total area of garden and lawn (m2	2) 40	
	Certificate Prepared by						
	ABN (if applicable): 12130092661	e ideas (ss)					
	L						
K Planning, Industry & Environment www.basix.nsw.gov.au Version: 3.0 / DARWINI	IIA_3_20_0 Certificate No.: 1372167S	Friday, 10 February 2023	page 1/2	E	BASIX Planning, Industry & Environm	ent www.basix.nsw.gov.au Version: 3.0 / DARWINI	A_3_20_0 Certificate No.: 13721675
Thermal Comfort Commitments		Show on C DA plans plans & sp			Energy Commitments		
Simulation Method	nt page of this BASIX certificate (the "Assocs	r			Hot water The applicant must install the follo	wing hot water system in the development, or a syster	n with a higher energy ration: gas
The applicant must attach the explosion and construction certificate by carificate) by the development application and construction certificate application for the applying for a complying development certificate for the proposed development, to that a sessessor Certificate to the application for an occupation certificate for the proposed development.	he proposed development (or, if the applicant is application). The applicant must also attach the	is			Cooling system	of 6 stars.	
Assessor Certificate on the application for an occupation certificate for the projosed devi The Assessor Certificate must have been issued by an Accredited Assessor in accordar The details of the proposed development on the Assessor Certificate must be consisten	nce with the Thermal Comfort Protocol.					wing cooling system, or a system with a higher energy ar (average zone)	rating, in at least 1 living area: 1-phase
certificate, including the Cooling and Heating loads shown on the front page of this certil The applicant must show on the plans accompanying the development application for th	ificate. he proposed development, all matters which th	ie .			The applicant must install the follo airconditioning; Energy rating: 3 st	wing cooling system, or a system with a higher energy tar (average zone)	-
Assessor Certificate requires to be shown on those plans. Those plans must bear a star Assessor to certify that this is the case. The applicant must show on the plans accompa artificate (or complying development certificate, if applicable), all thermal performance :	mp of endorsement from the Accredited anying the application for a construction specifications set out in the Assessor					for day/night zoning between living areas and bedroom	ns
Certificate, and all aspects of the proposed development which were used to calculate the The applicant must construct the development in accordance with all thermal performant of the applicant must construct the development in accordance with all thermal performant the applicant must construct the development in accordance with all thermal performant the applicant must construct the development in accordance with all thermal performant the applicant must construct the development in accordance with all thermal performant the applicant must construct the development in accordance with all thermal performant the applicant must construct the development in accordance with all thermal performant the applicant must construct the development in accordance with all thermal performant the applicant must construct the development in accordance with all thermal performant the applicant must construct the development in accordance with all thermal performant the applicant must construct the development in accordance with all thermal performant the applicant must construct the development in accordance with all thermal performant the applicant must be applied with the applicant the applicant the applicant must be applied with the applicant the applicant the applicant the applicant the applicant the applicant the applica	those specifications. nce specifications set out in the Assessor				Heating system The applicant must install the follo	wing heating system, or a system with a higher energy	y rating, in at least 1 living area: 1-phase
2ertificate, and in accordance with those aspects of the development application or app which were used to calculate those specifications. The applicant must construct the floors and walls of the dwelling in accordance with the		te 🗸			airconditioning; Energy rating: 3 st The applicant must install the follo airconditioning; Energy rating: 3 st	wing heating system, or a system with a higher energy	y rating, in at least 1 bedroom: 1-phase
The applicant must construct the noors and wails of the owning in accordance with the						for day/night zoning between living areas and bedroon	ns.
loor and wall construction	Area				Ventilation		
	All or part of floor area square metres					wing exhaust systems in the development:	
	All or part of floor area					an, ducted to façade or roof; Operation control: manual	I switch on/off
	All or part of floor area				At least 1 Bathroom: individual fa	an, ducted to façade or roof; Operation control: manual façade or roof; Operation control: manual switch on/o	
	All or part of floor area				At least 1 Bathroom: individual fa Kitchen: individual fan, ducted to		ff
	All or part of floor area				At least 1 Bathroom: individual fa Kitchen: individual fan, ducted to Laundry: individual fan, ducted to Artificial lighting The applicant must ensure that th	façade or roof; Operation control: manual switch on/o façade or roof; Operation control: manual switch on/o a "primary type of artificial lighting" is fluorescent or ligh	ff ht emitting diode (LED) lighting in each ol
	All or part of floor area				At least 1 Bathroom: individual fa Kitchen: individual fan, ducted to Laundry: individual fan, ducted tr Artificial lighting The applicant must ensure that th following rooms, and where the w light emitting diod (LED) lampa:	façade or root: Operation control: manual switch on/o façade or root: Operation control: manual switch on/o a "primary type of artificial lighting" is fluorescent or ligi ord "dedicated" appears, the fittings for those lights mu	ff ht emitting diode (LED) lighting in each ol
floor - suspended floor above garage					At least 1 Bathroom: individual fa Kitchen: individual fan, ducted to Laundry: individual fan, ducted to Artificial lighting The applicant must ensure that the following rooms, and where the we light emitting diode (LED) lamps: • at least 4 of the bedrooms / str	façade or root; Operation control: manual switch on/o o façade or root; Operation control: manual switch on/o "primary type of artificial lighting" is fluorescent or light of "dedicated" appears, the fittings for those lights mudy; dedicated	ff Jff ht emitting diode (LED) lighting in each of st only be capable of accepting fluoresco
licor - suspended floor above garage		Friday, 10 February 2023	page 47		At least 1 Bathroom: individual fa Kitchen: individual fan, ducted to Laundry: individual fan, ducted to Artificial lighting The applicant must ensure that the following rooms, and where the we light emitting diode (LED) lamps: • at least 4 of the bedrooms / str	façade or root: Operation control: manual switch on/o façade or root: Operation control: manual switch on/o a "primary type of artificial lighting" is fluorescent or ligi ord "dedicated" appears, the fittings for those lights mu	ff Jff ht emitting diode (LED) lighting in each of st only be capable of accepting fluoresco
loor - suspended floor above garage		Friday, 10 February 2023	page 47		At least 1 Bathroom: individual fa Kitchen: individual fan, ducted to Laundry: individual fan, ducted to Artificial lighting The applicant must ensure that the following rooms, and where the we light emitting diode (LED) lamps: • at least 4 of the bedrooms / str	façade or root; Operation control: manual switch on/o o façade or root; Operation control: manual switch on/o "primary type of artificial lighting" is fluorescent or light of "dedicated" appears, the fittings for those lights mudy; dedicated	ff Jff ht emitting diode (LED) lighting in each of st only be capable of accepting fluoresco
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icor - suspended floor above garage Planning, industry & Environment www.basix.new.gov.au Version: 3.0 / DARWIN Thermal Comfort Commitments Simulation Method	IA_3_20_0 Certificate No.: 1372167S	Show on Show on C DA plans plans & sp	C/CDC Certifier		At least 1 Bathroom: individual fa Kitchen: individual fan, ducted to Laundry: individual fan, ducted to Artificial lighting The applicant must ensure that the following rooms, and where the we light emitting diode (LED) lamps: • at least 4 of the bedrooms / str	façade or root; Operation control: manual switch on/o o façade or root; Operation control: manual switch on/o "primary type of artificial lighting" is fluorescent or light of "dedicated" appears, the fittings for those lights mudy; dedicated	ff Jff ht emitting diode (LED) lighting in each of st only be capable of accepting fluoresco
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Natural lighting The applicant must install a window and install a window and/ The applicant must install a window and/or Swimming pool The development must not nent must not inco rate anv The applicant must install a timer for the swir Other The applicant must install a gas cooktop & e The applicant must install a fixed outdoor clo BASIX Planning, Industry & Environment www

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andscape he applicant must plant indigenous or low water use species of vegetation throughout 20 square metres of the site.			
ixtures	~	~	_
he applicant must install showerheads with a minimum rating of 4 star (> 4.5 but <= 6 L/min plus spray force and/or coverage tests) in	1		
I showers in the development. he applicant must install a toilet flushing system with a minimum rating of 5 star in each toilet in the development.			- -
he applicant must install taps with a minimum rating of 5 star in the kitchen in the development.		•	~
he applicant must install basin taps with a minimum rating of 5 star in each bathroom in the development.		~	+
		 	
wimming pool he swimming pool must not have a volume greater than 11 kiloitres.		1	-
e swimming pool must have a pool cover.	 	 	
		 	
e swimming pool must be outdoors.	 Image: A second s	 ✓ 	
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nergy Commitments • at least 3 of the living / dining rooms; dedicated • the kitcher; dedicated • all bathrooms/toilets; dedicated • the laundry; dedicated • all hallways; dedicated atural lighting		Show on CC/CDC	Certifier
hergy Commitments et least 3 of the living / dining rooms; dedicated the kitcher; dedicated et lathrooms/toilets; dedicated the laundry; dedicated et laundry; dedicated atural lighting he applicant must install a window and/or skylight in the kitchen of the dwelling for natural lighting.		Show on CC/CDC	Certifier
nergy Commitments at least 3 of the living / dining rooms; dedicated the kitcher; dedicated all bathrooms/hollet;, dedicated the laundry; dedicated all hallways; dedicated all hallways; dedicated aurual lighting re applicant must install a window and/or skylight in the kitchen of the dwelling for natural lighting. re applicant must install a window and/or skylight in 3 bathroom(s)hole(s) in the development for natural lighting.	Show on DA plans	Show on CC/CDC plans & specs	Certifier check
hergy Commitments et least 3 of the living / dining rooms; dedicated the kitcher; dedicated et lathrooms/toilets; dedicated the laundry; dedicated et laundry; dedicated atural lighting he applicant must install a window and/or skylight in the kitchen of the dwelling for natural lighting.	Show on DA plans	Show on CC/CDC plans & specs	Certifier check
hergy Commitments at least 3 of the living / dining rooms; dedicated at least 3 of the living / dining rooms; dedicated at least 3 of the living / dining rooms; dedicated at least 3 of the living / dedicated at least 4 of the living / dedicated at least	Show on DA plans	Show on CC/CDC plans & specs	Certifier check
hergy Commitments at least 3 of the living / dining rooms; dedicated at least 3 of the living / dining rooms; dedicated at least 3 of the living / dining rooms; dedicated all bathrooms/holiets; dedicated all bathrooms/holiets; dedicated at least 3 of the living / dining dedicated at least 3 of the living / dining dedicated at least 3 of the living / dining dedicated at least 3 of the living / dining dedicated at least 3 of the living / dining dedicated at least 4 of the living / dining dedicated at least 4 of the living / dining dedicated at least 4 of the living / dining dedicated at least 4 of the living / dining dedicated at least 4 of the living / dining dedicated at least 4 of the living dedicated at	Show on DA plans	Show on CC/CDC plans & specs	Certifier check
hergy Commitments e at least 3 of the living / dining rooms; dedicated the kitchen; dedicated the kitchen; dedicated the laundry; dedicated the laundry; dedicated atural lighting the applicant must install a window and/or skylight in the kitchen of the dwelling for natural lighting. the applicant must install a window and/or skylight in 3 bathroom(s)hole(s) in the development for natural lighting. winnning pool the development must install a timer for the swimming pool pump in the development. ther	Show on DA plans	Show on CC/CDC plans & specs	Certifier check
hergy Commitments at least 3 of the living / dining rooms; dedicated at least 3 of the living / dining rooms; dedicated the kitcher; dedicated all bathrooms/toilets; dedicated atural lighting he applicant must install a window and/or skylight in the kitchen of the dwelling for natural lighting. he applicant must install a window and/or skylight in 3 bathroom(s)/toilet(s) in the development for natural lighting. wimming pool he development must not incorporate any heating system for the swimming pool. he applicant must install a timer for the swimming pool pump in the development.	Show on DA plans	Show on CC/CDC plans & specs	Certifier check

COMPLYING DEVELOPMENT ONLY - NOT FOR CONSTRUCTION



PROJECT: PROPOSED NEW DWELLING

465 Beauchamp St Maroubra NSW 2035 DRAWING: BASIX



*D*utux ™ Vivid White™







Black aluminum windows

White aluminum windows

F1 White paint finish to walls, roof, capping



Polished concrete floor

F2 Charcoal paint finish to wall, external door



Timber decking



PS privacy screen breeze blocks



FLG Fluted glass

ma

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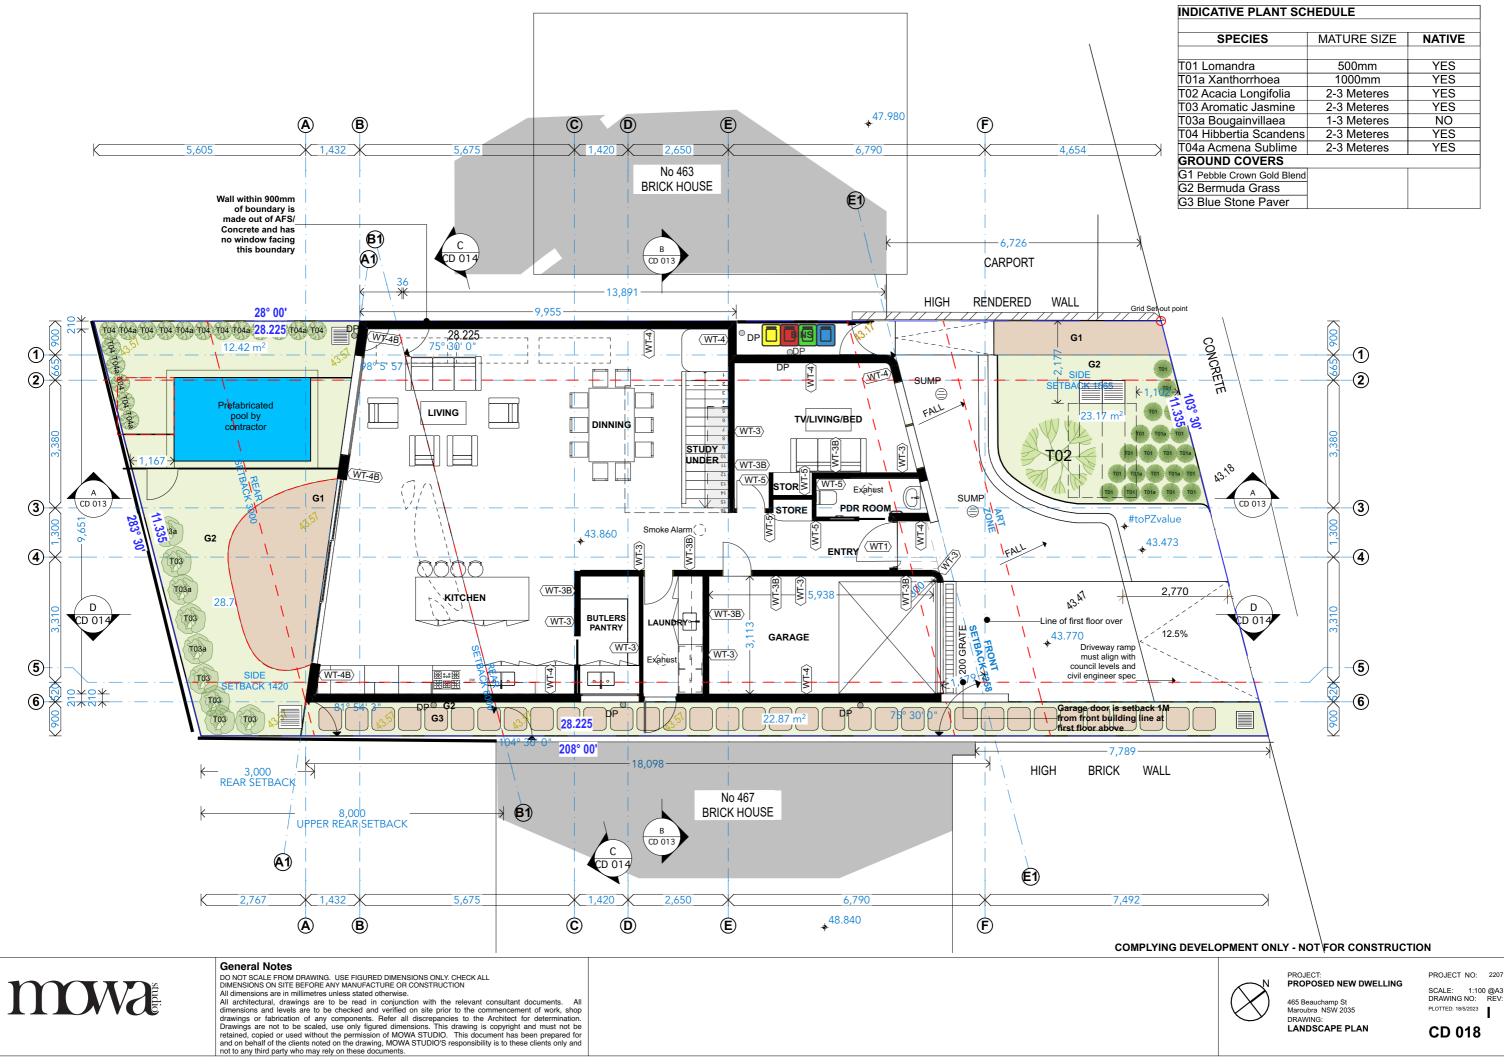
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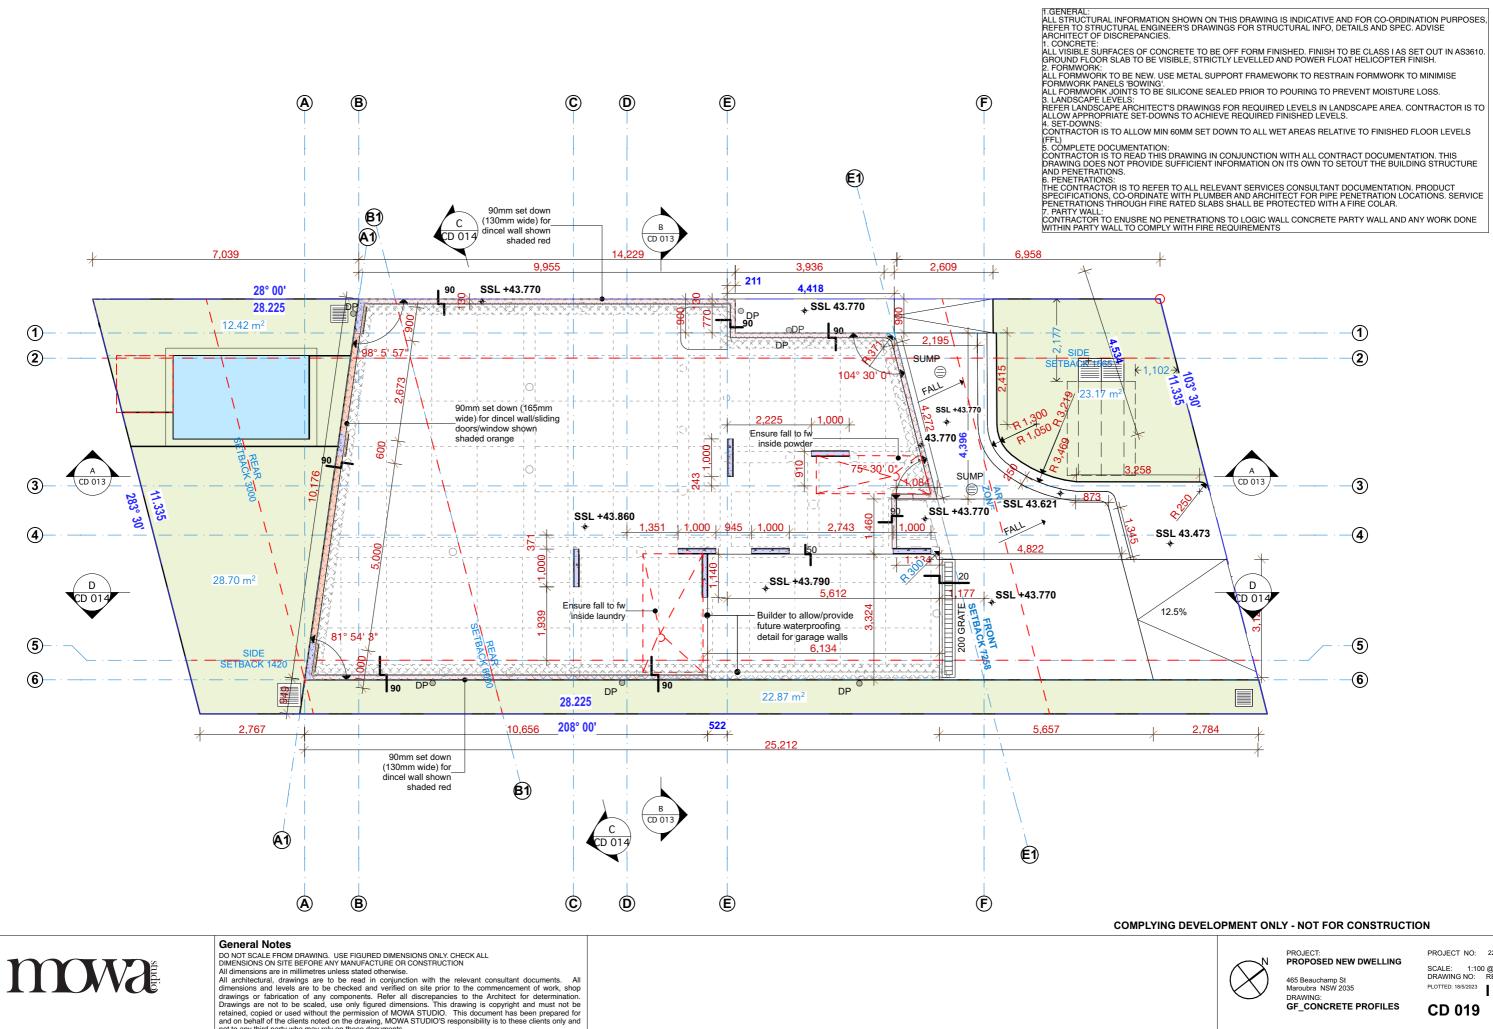
PROJECT: PROPOSED NEW DWELLING

465 Beauchamp St Maroubra NSW 2035 DRAWING: FINISHES SCHEDULE





SPECIES	MATURE SIZE	NATIVE
T01 Lomandra	500mm	YES
T01a Xanthorrhoea	1000mm	YES
T02 Acacia Longifolia	2-3 Meteres	YES
T03 Aromatic Jasmine	2-3 Meteres	YES
T03a Bougainvillaea	1-3 Meteres	NO
T04 Hibbertia Scandens	2-3 Meteres	YES
T04a Acmena Sublime	2-3 Meteres	YES
GROUND COVERS		
G1 Pebble Crown Gold Blend		
G2 Bermuda Grass		
G3 Blue Stone Paver		




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PROPOSED NEW DWELLING

Maroubra NSW 2035 DRAWING: GF_CONCRETE PROFILES






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GENER/

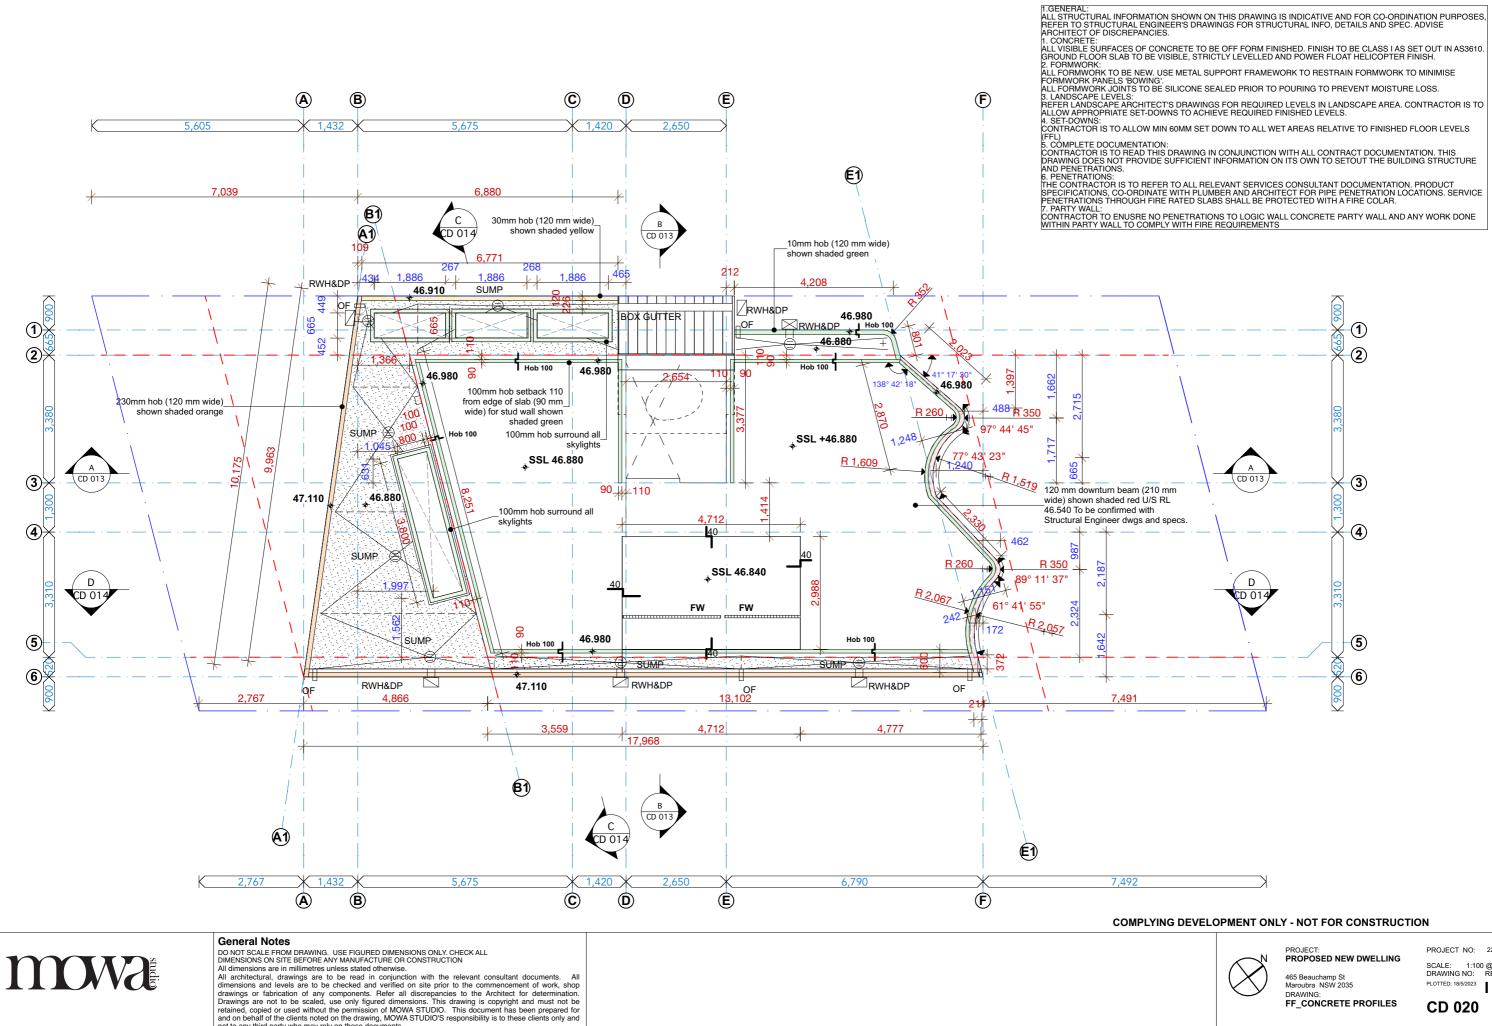PROJECT NO: 2207 SCALE: 1:100 @A3 DRAWING NO: REV: PLOTTED: 18/5/2023

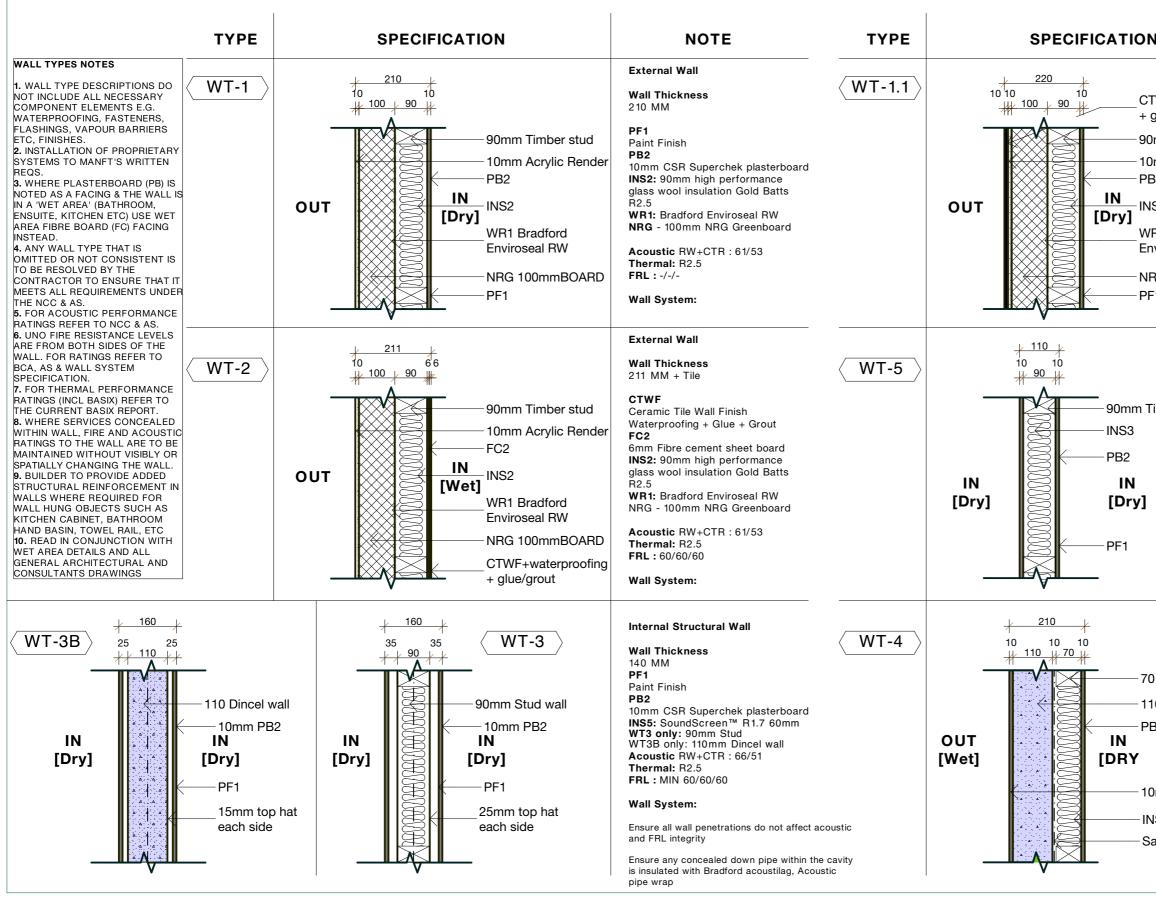

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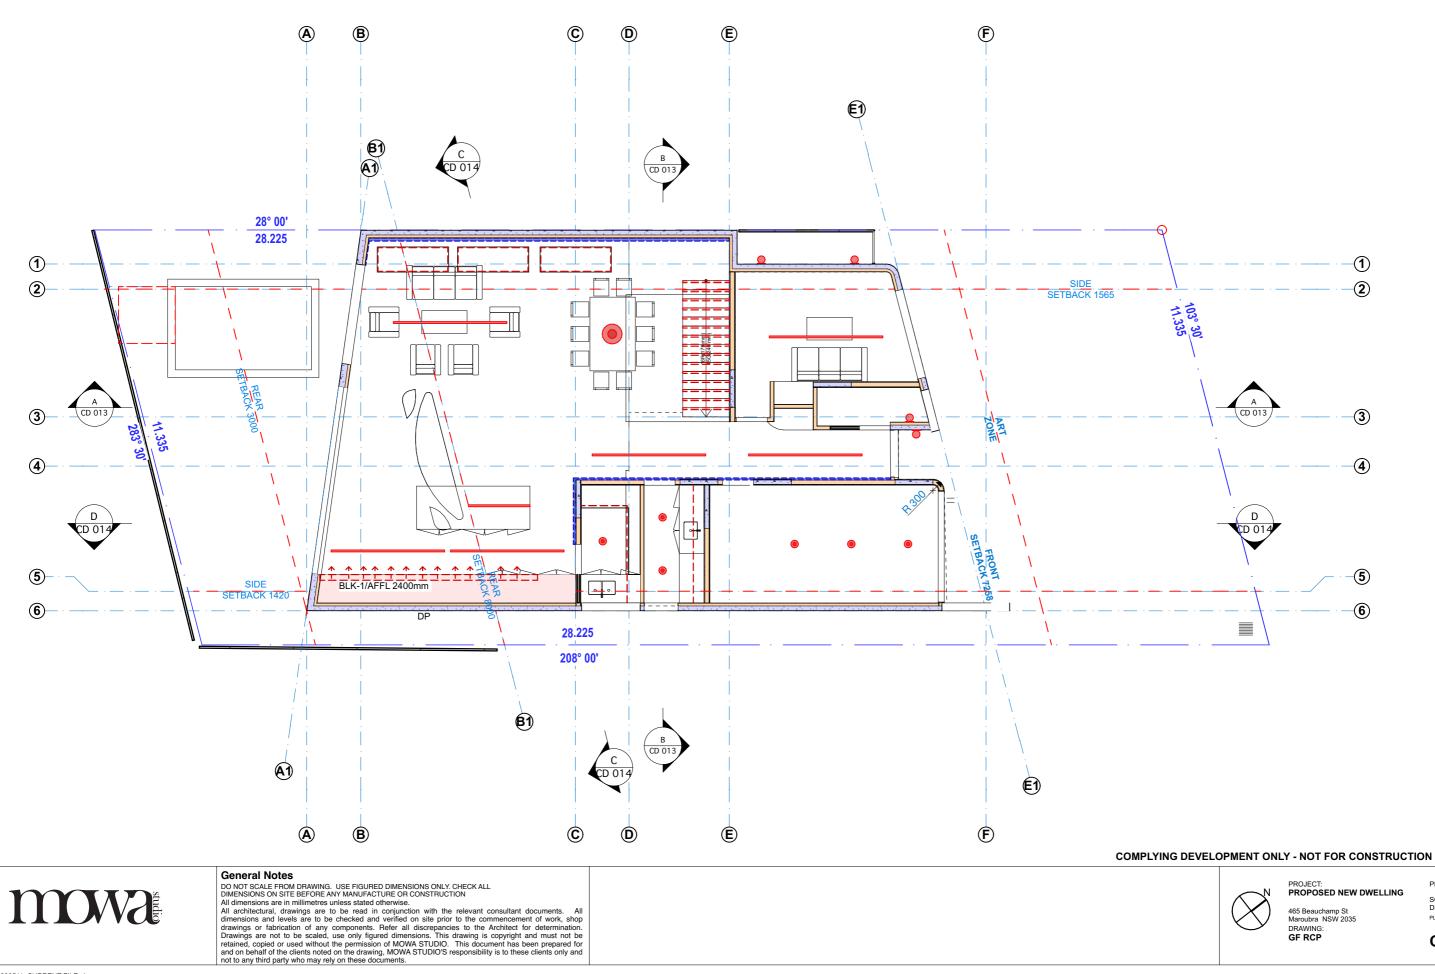
N	NOTE
	External Wall
TWF+waterproofing glue/grout	Wall Thickness 220 MM PF1
0mm Timber stud 0mm Acrylic Render B2 NS2	Paint Finish PB2 10mm CSR Superchek plasterboard INS2: 90mm high performance glass wool insulation Gold Batts R2.5 WR1: Bradford Enviroseal RW
/R1 Bradford nviroseal RW	NRG - 100mm NRG Greenboard CTWF Ceramic Tile Wall Finish Waterproofing + Glue + Grout
IRG 100mmBOARD F1	Acoustic RW+CTR : 61/53 Thermal: R2.5 FRL : -/-/-
	Wall System:
	Internal Wall
Timber stud	Wall Thickness 110 MM PF1 Paint Finish PB2 10mm CSR Superchek plasterboard INS3: 70mm SoundScreen™ R2.0 Acoustic RW+CTR : 42/33 Thermal: R2.0 FRL : - Wall System: CSR 2024
	waii System: Con 2024
	External Wall
0 mm stud frame	Wall Thickness 210 MM
10mm Dincel	PF1 Paint Finish PB2 10mm CSR Superchek plasterboard
2 ^{B2}	INS5: SoundScreen [™] R1.7 60mm DINCEL WALL: 110mm Acoustic RW+CTR : 64/50 Thermal: R2.5 FRL : 60/60/60
0mm Acrylic Render	Wall System: AFS
NS5 Sarking	Ensure all wall penetrations do not affect acoustic and FRL integrity Ensure any concealed down pipe within the

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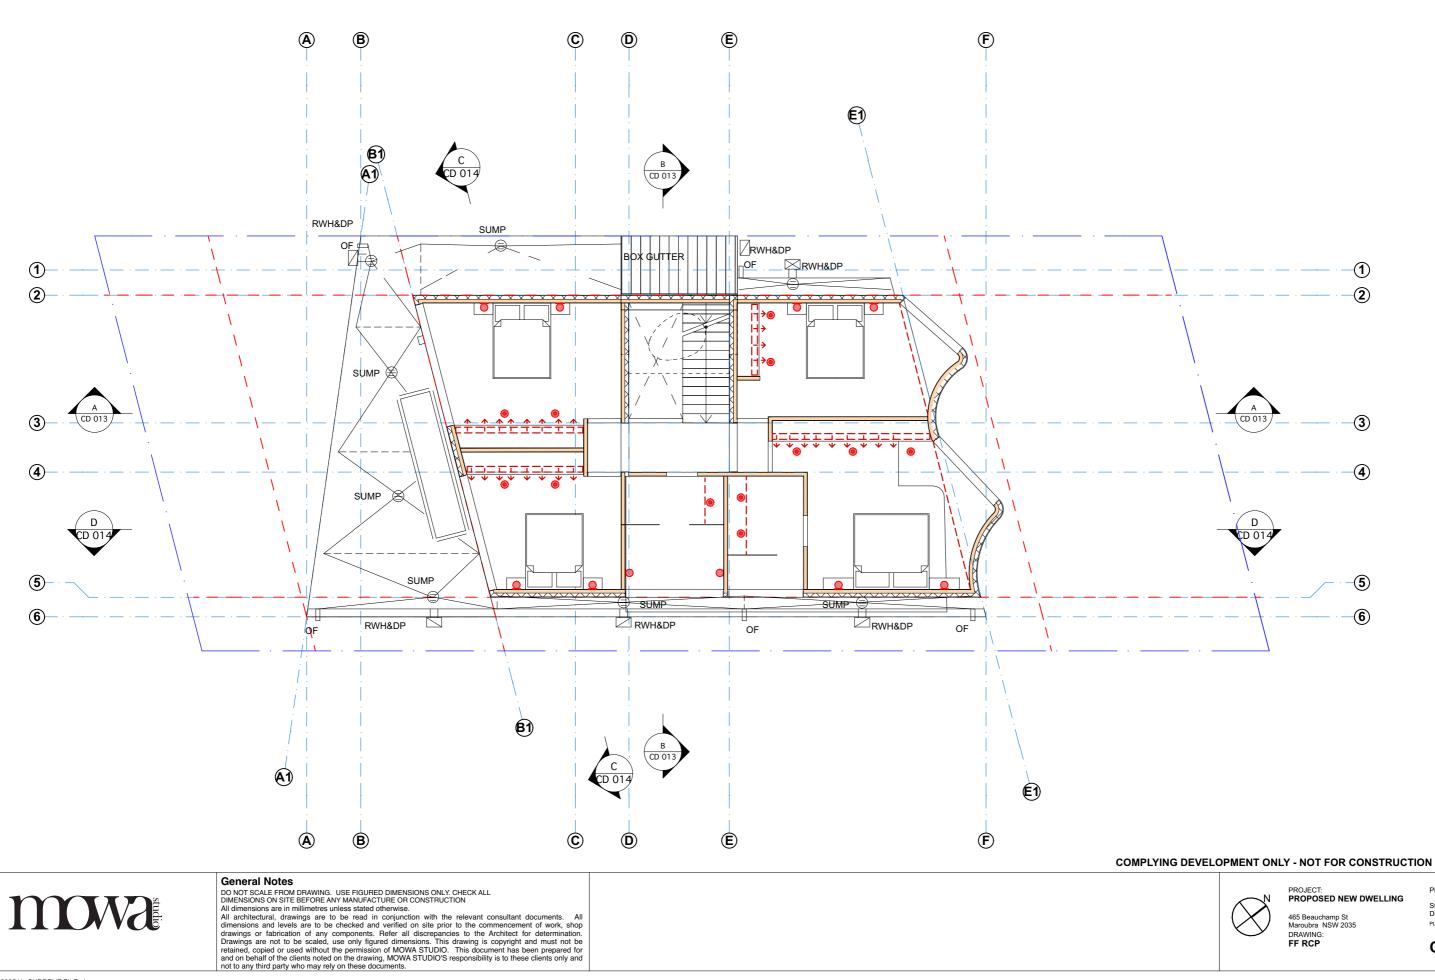
PROJECT PROPOSED NEW DWELLING 465 Beauchamp St

Maroubra NSW 2035 DRAWING: WALL TYPE SCHEDULE PROJECT NO: 2207 SCALE: SCALE: @A3 DRAWING NO: REV: PLOTTED: 18/5/2023




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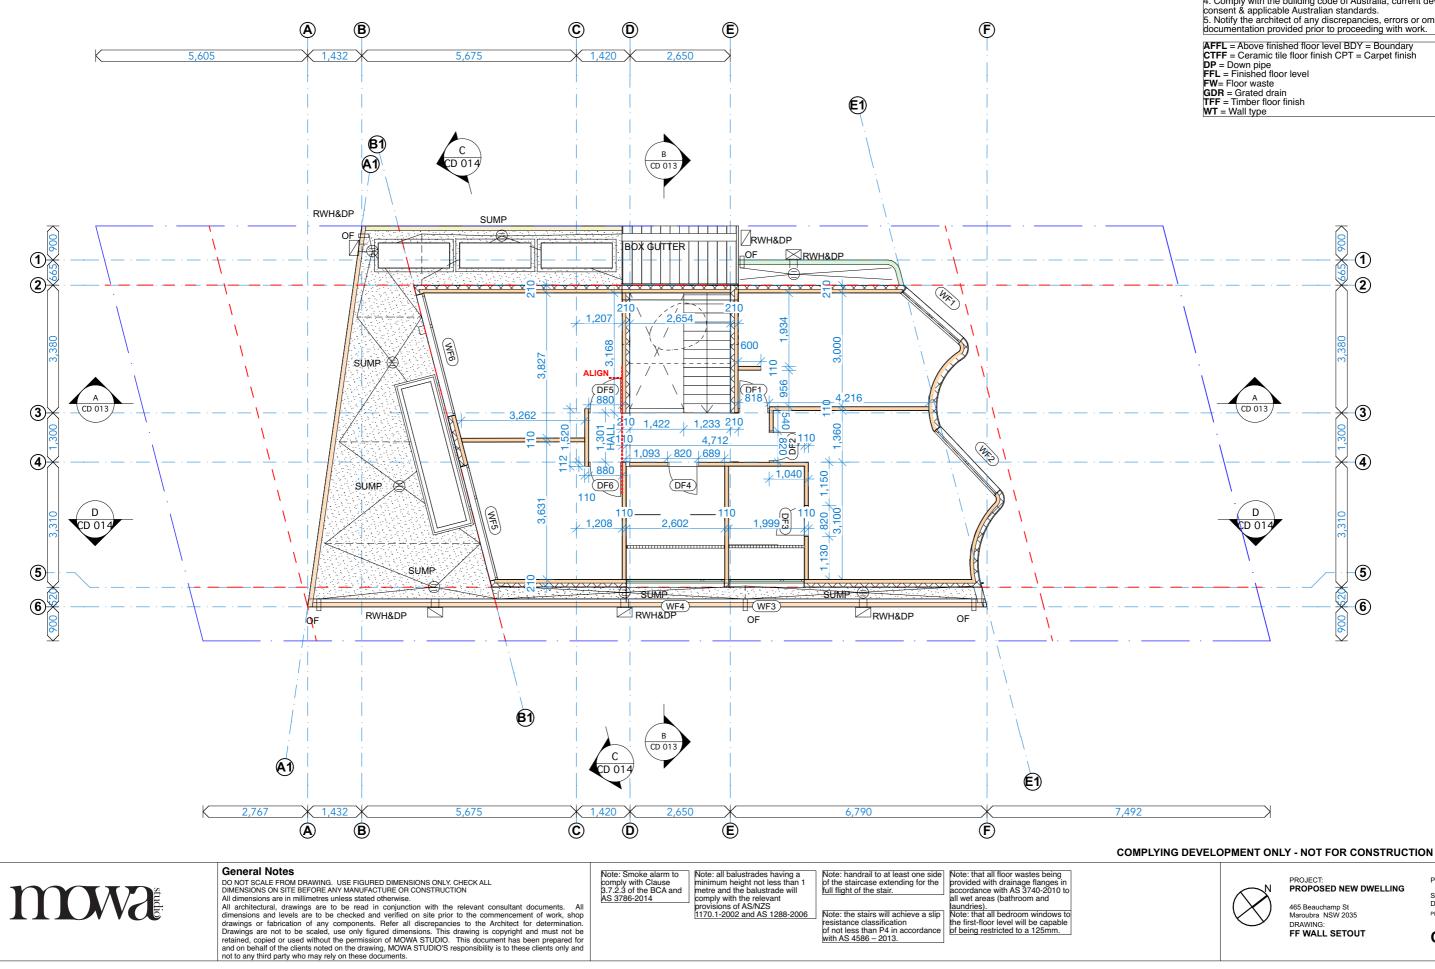


1. Drawings to be read in conjunction with all documentation provided. All Structural, Hydraulic, Electrical, Civil, Mechanical, Landscape information shown in the architectural documents is indicative only - refer to consultant's separate documentation for details. Report discrepancies with architectural and services documents immediately to the architect prior to proceeding with work. 3. Shop drawings to be completed for all metalwork facade prototypes. Joinery & other nominated items prior to commencement of construction, and with adequate time allowed for review by architect and engineers etc. Comply with the building code of Australia, current development consent & applicable Australian standards. 5. Notify the architect of any discrepancies, errors or omissions in the documentation provided prior to proceeding with work.

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PROPOSED NEW DWELLING



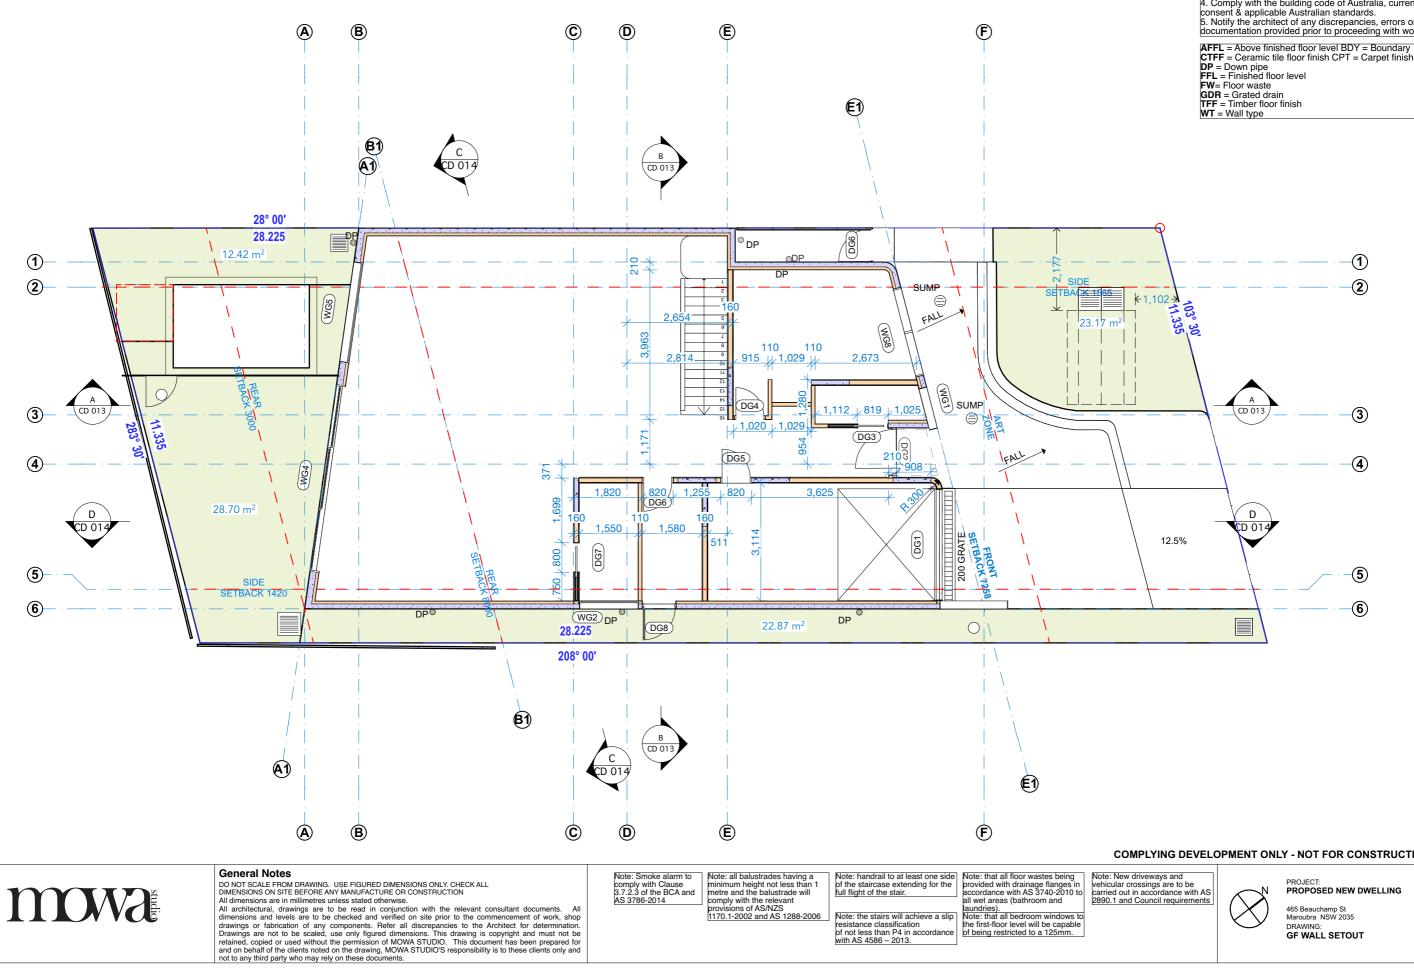


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INTERIOR
(STAIR VOID)

PBD LINING - UP TO SKYLIGHT FRAME AS REQUIRED

> FRAME AS REQUIRED

(STAIR VOID)

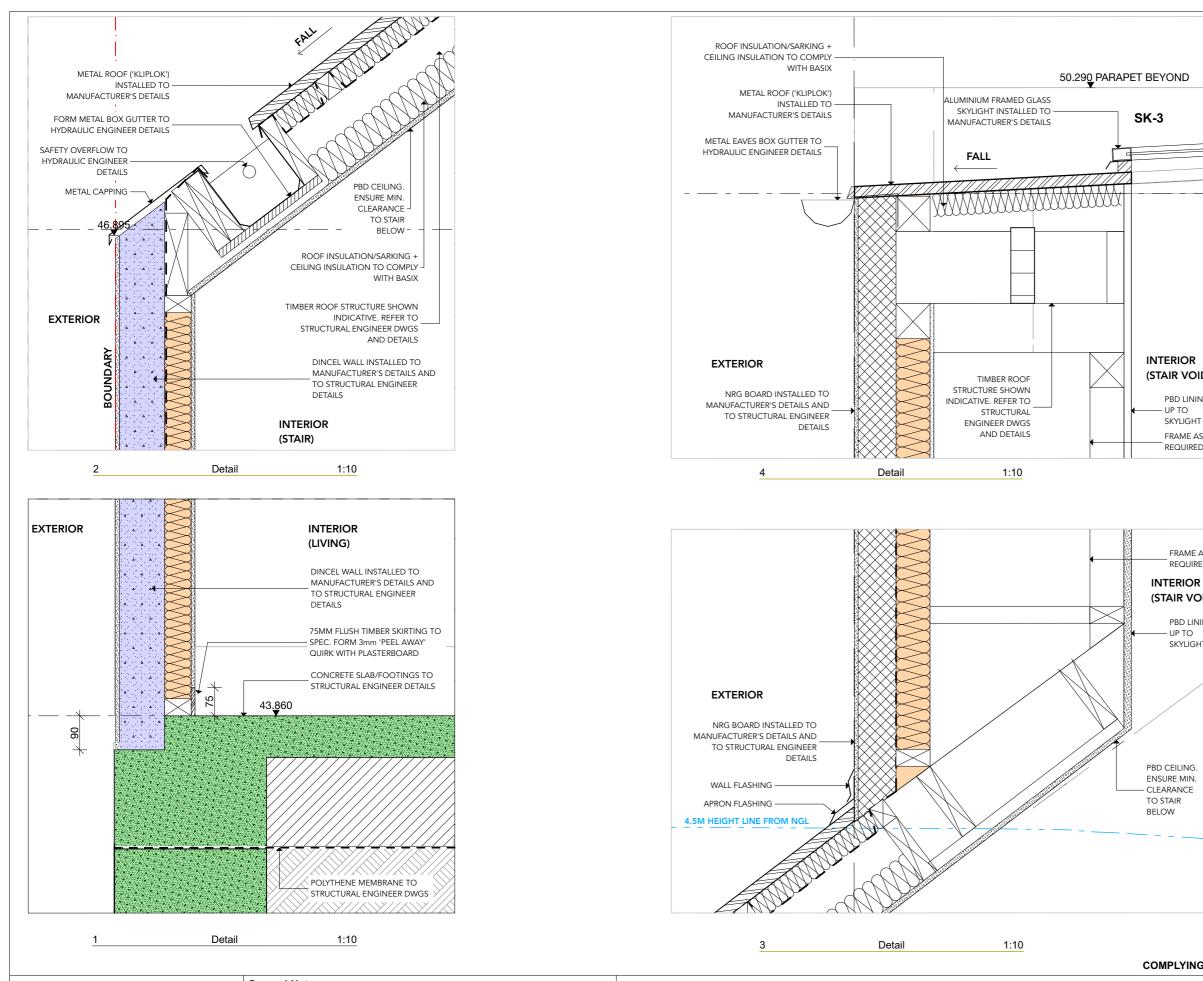PBD LINING UP TO SKYLIGHT

ENSURE MIN. CLEARANCE


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PROJECT: PROPOSED NEW DWELLING

465 Beauchamp St Maroubra NSW 2035 DRAWING: DETAILS





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DF INSULATION/SARKING + LING INSULATION TO COMPLY H BASIX	
TAL ROOF ('KLIPLOK') TALLED TO NUFACTURER'S DETAILS	
IETAL EAVES BOX GUTTER TO HYDRAULIC ENGINEER DETAILS	
G BOARD INSTALLED TO ANUFACTURER'S DETAILS AND STRUCTURAL ENGINEER TAILS	
EXTERIOR	
UMINIUM FRAMED GLASS	
NDOW INSTALLED TO ANUFACTURER'S DETAILS 	
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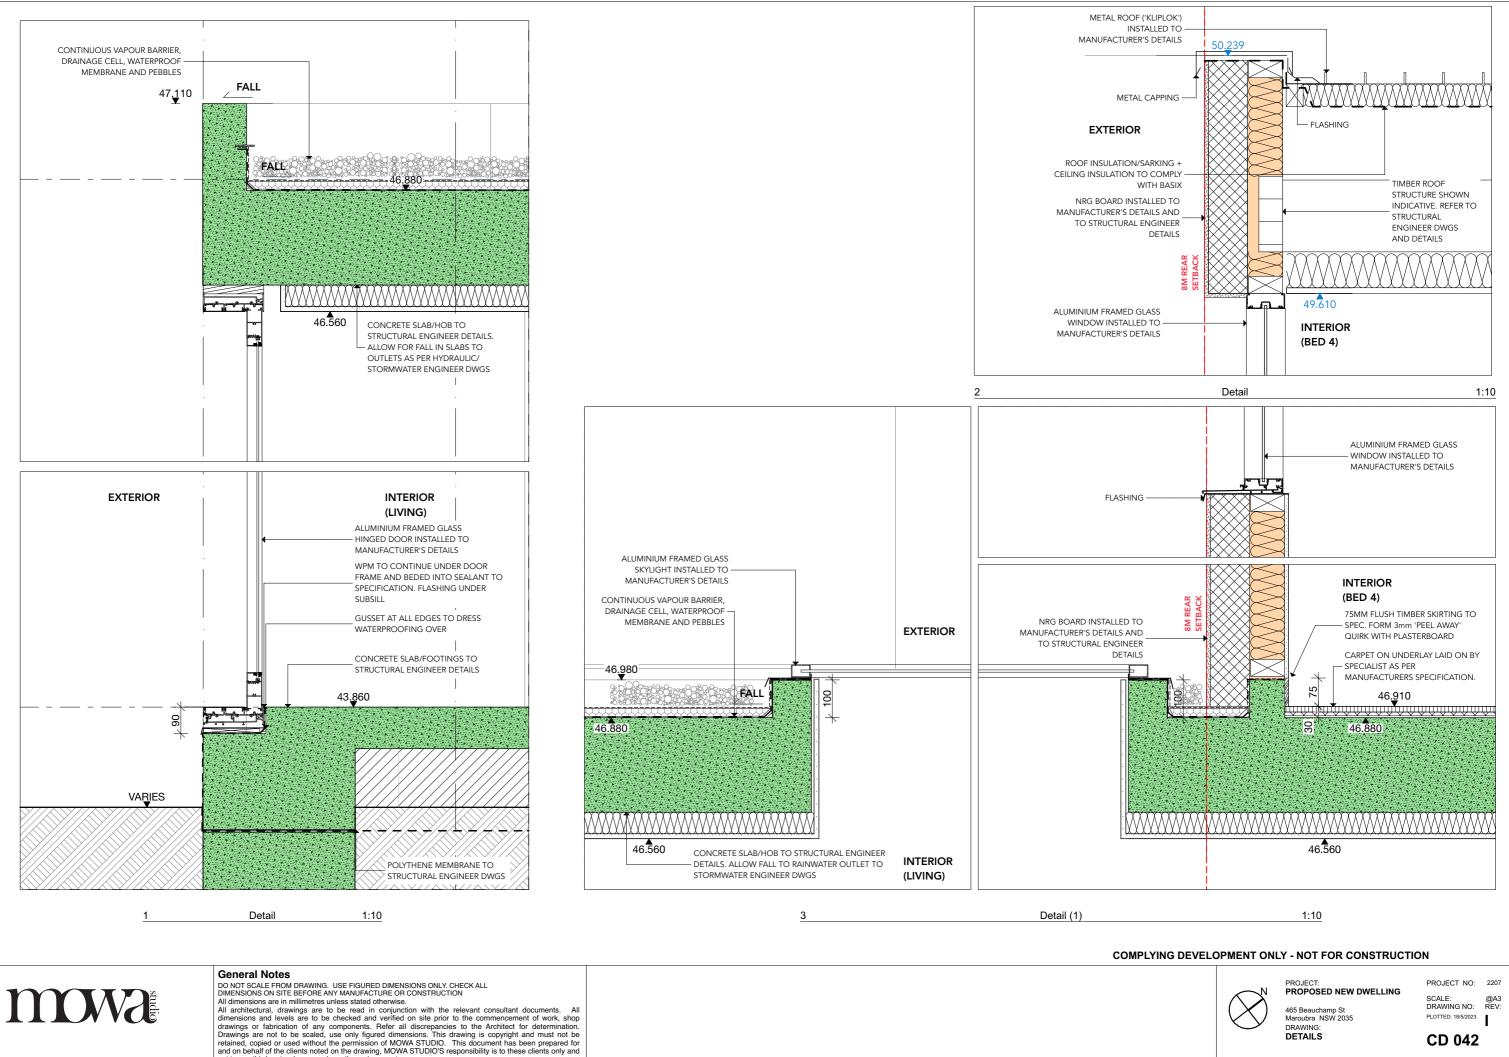
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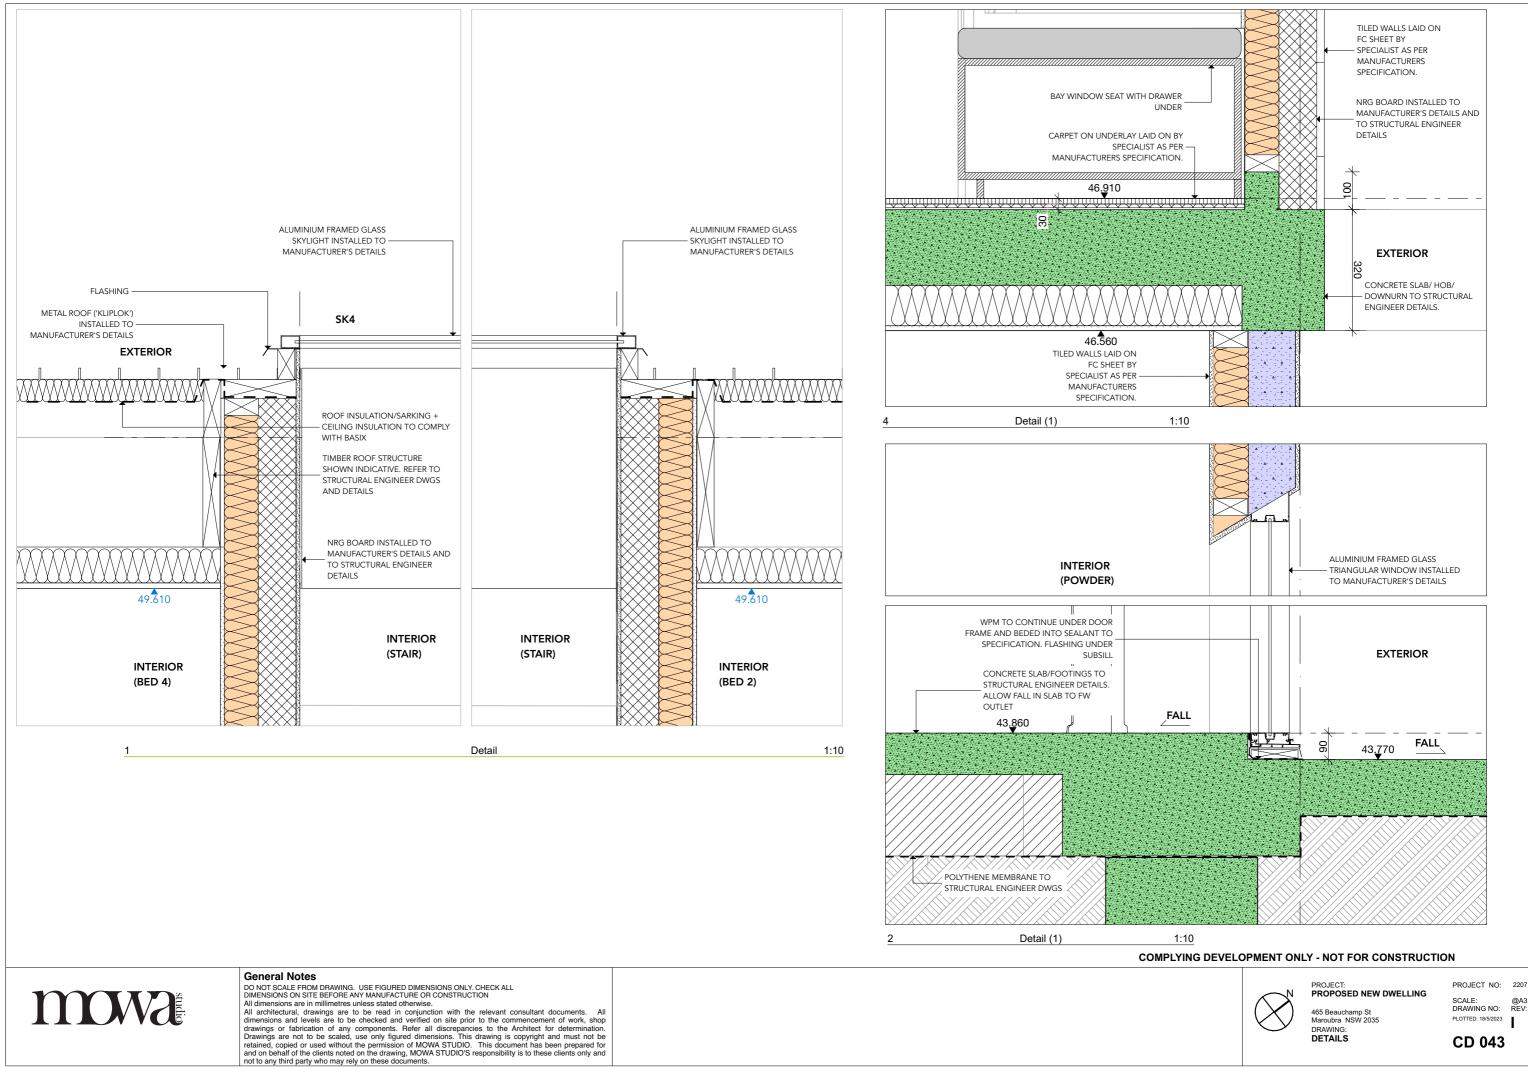
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465 Beauchamp St Maroubra NSW 2035 DRAWING: DETAILS

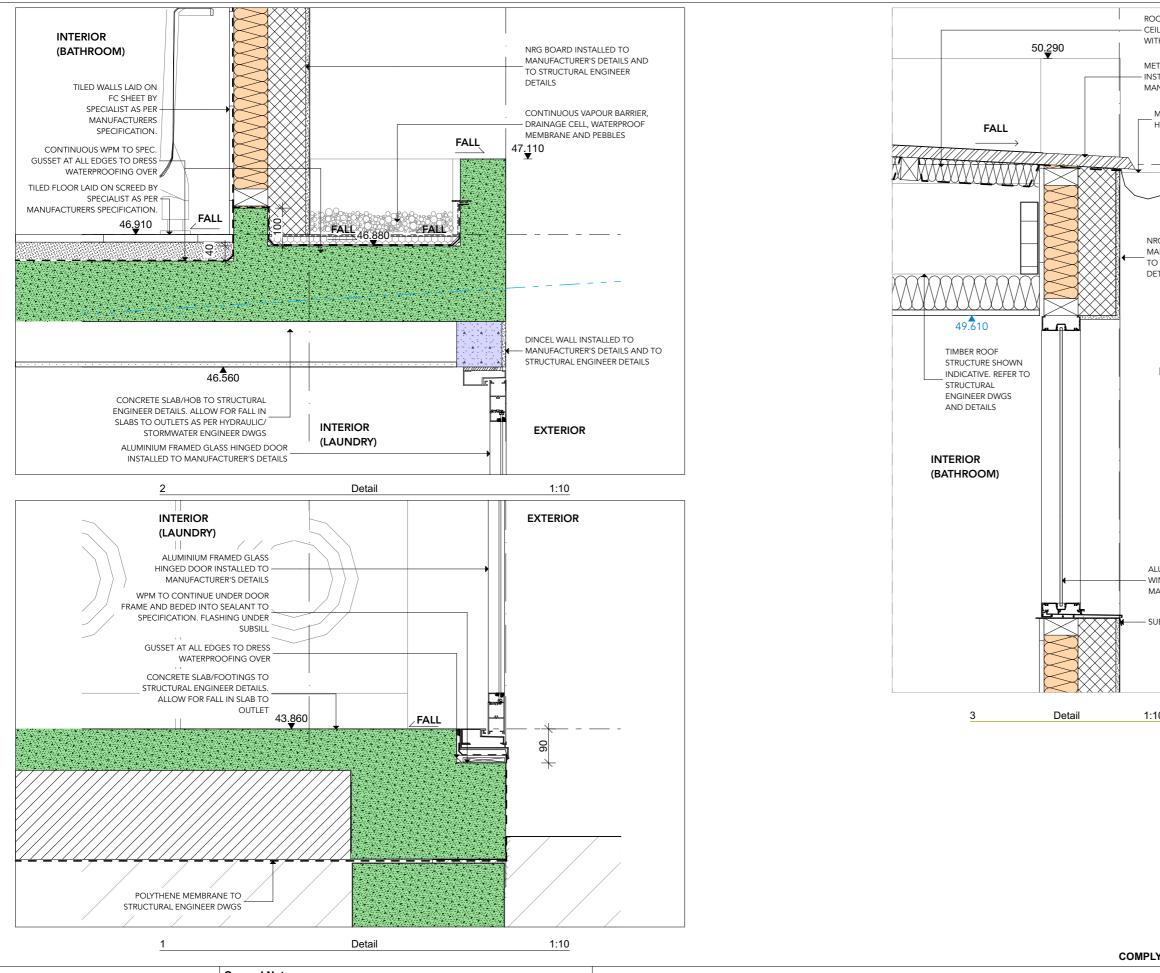





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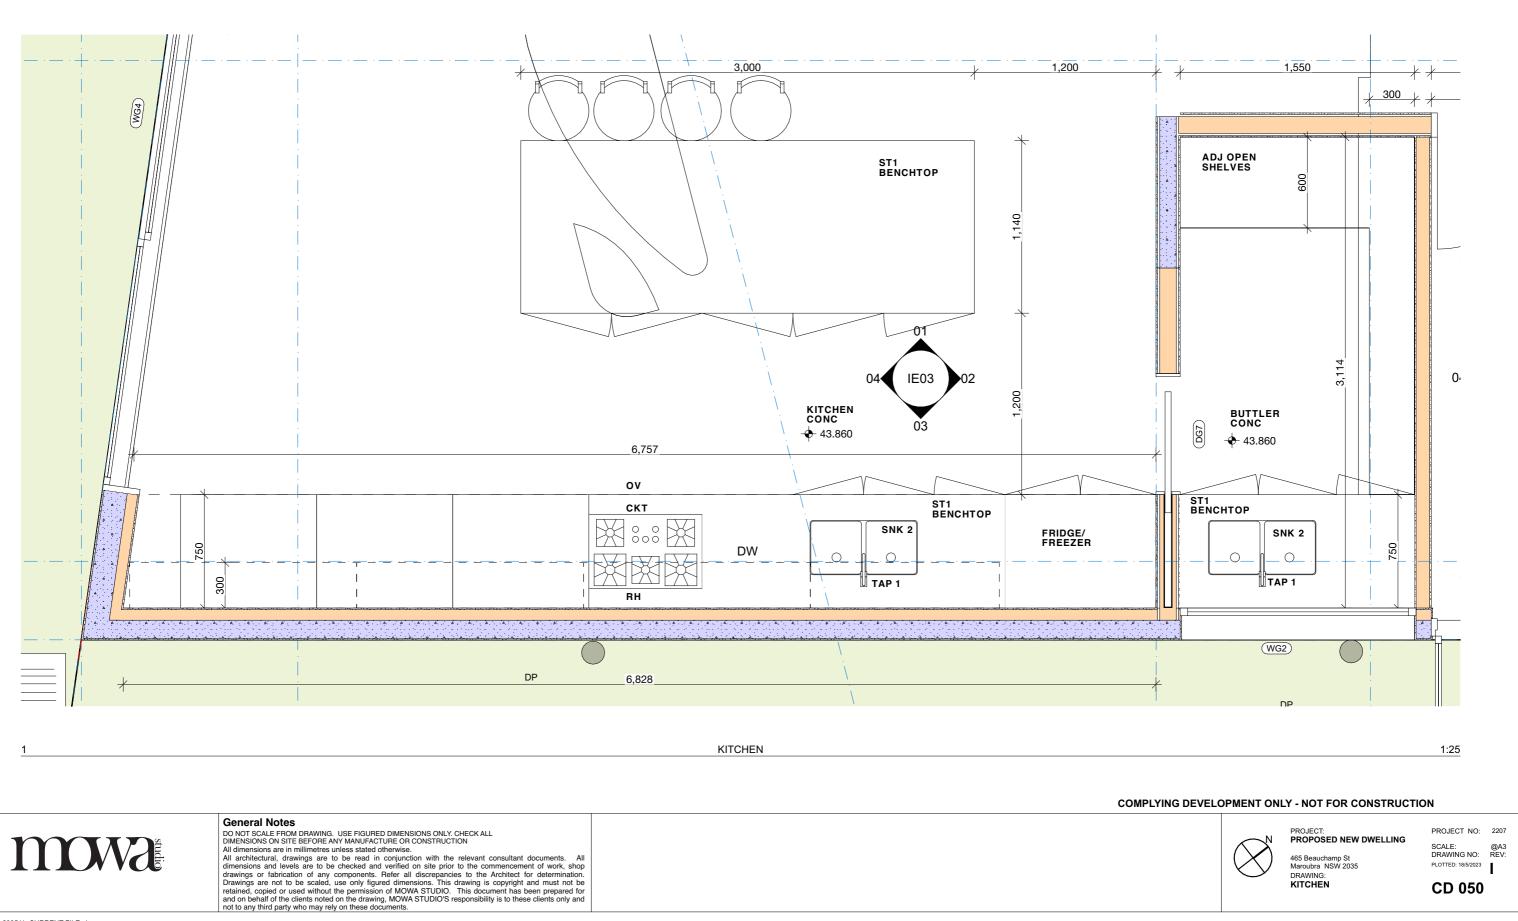
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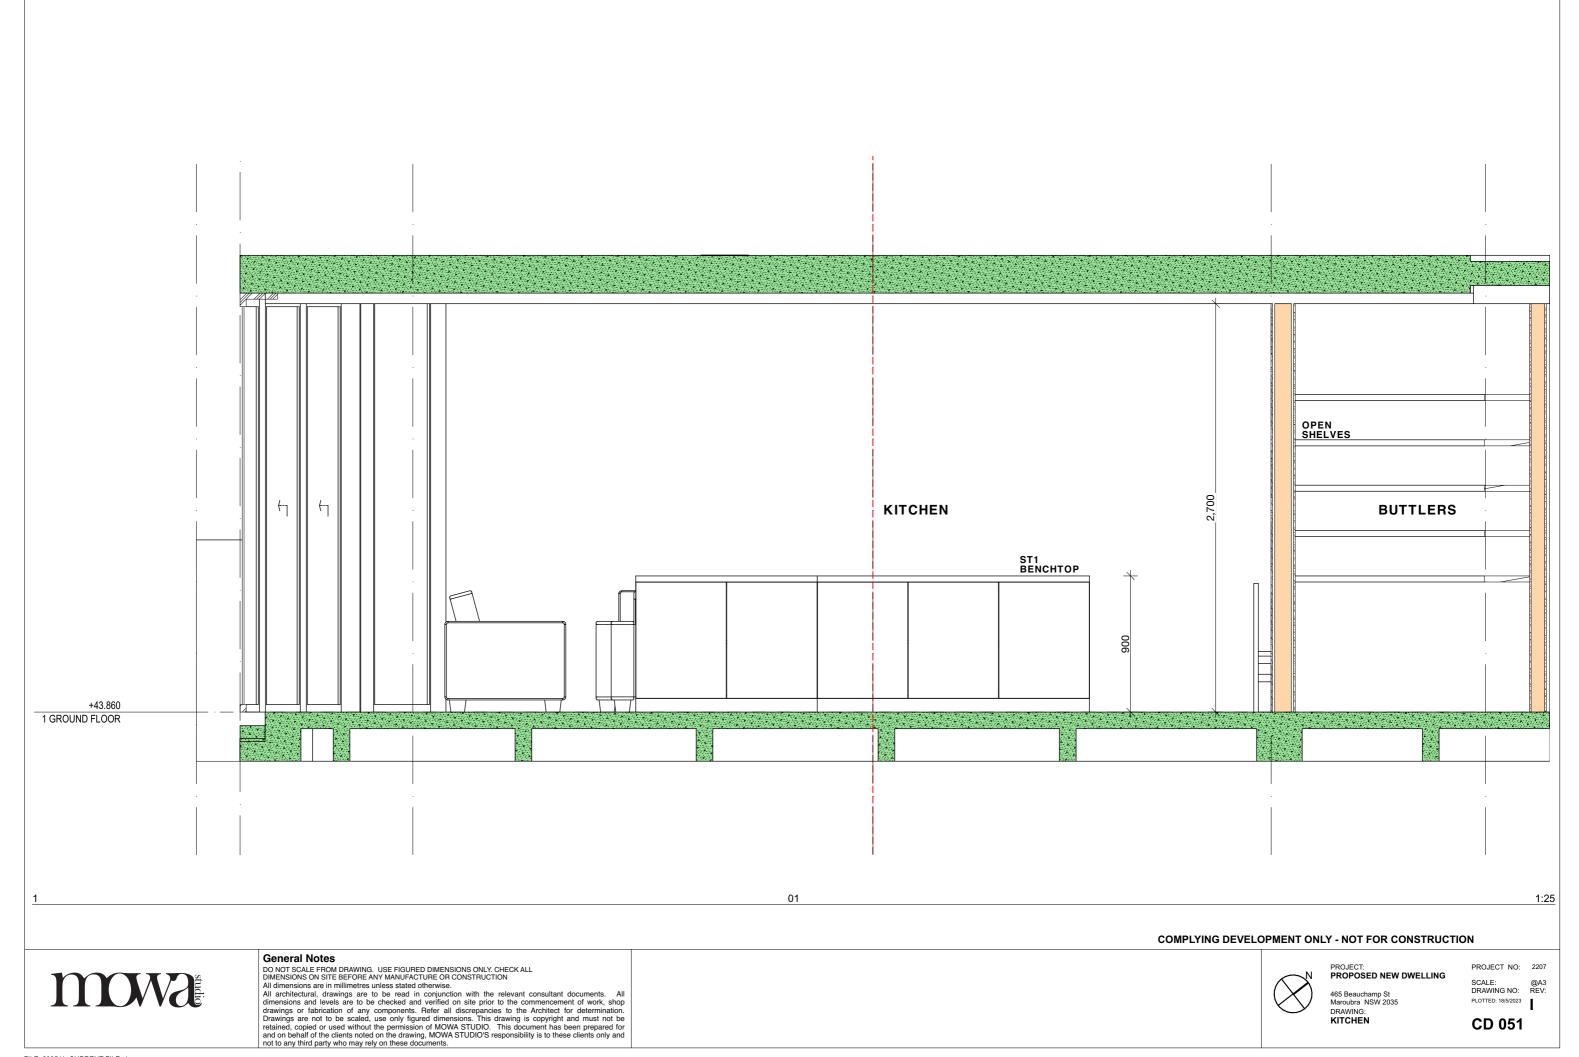



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465 Beauchamp St Maroubra NSW 2035 DRAWING: DETAILS



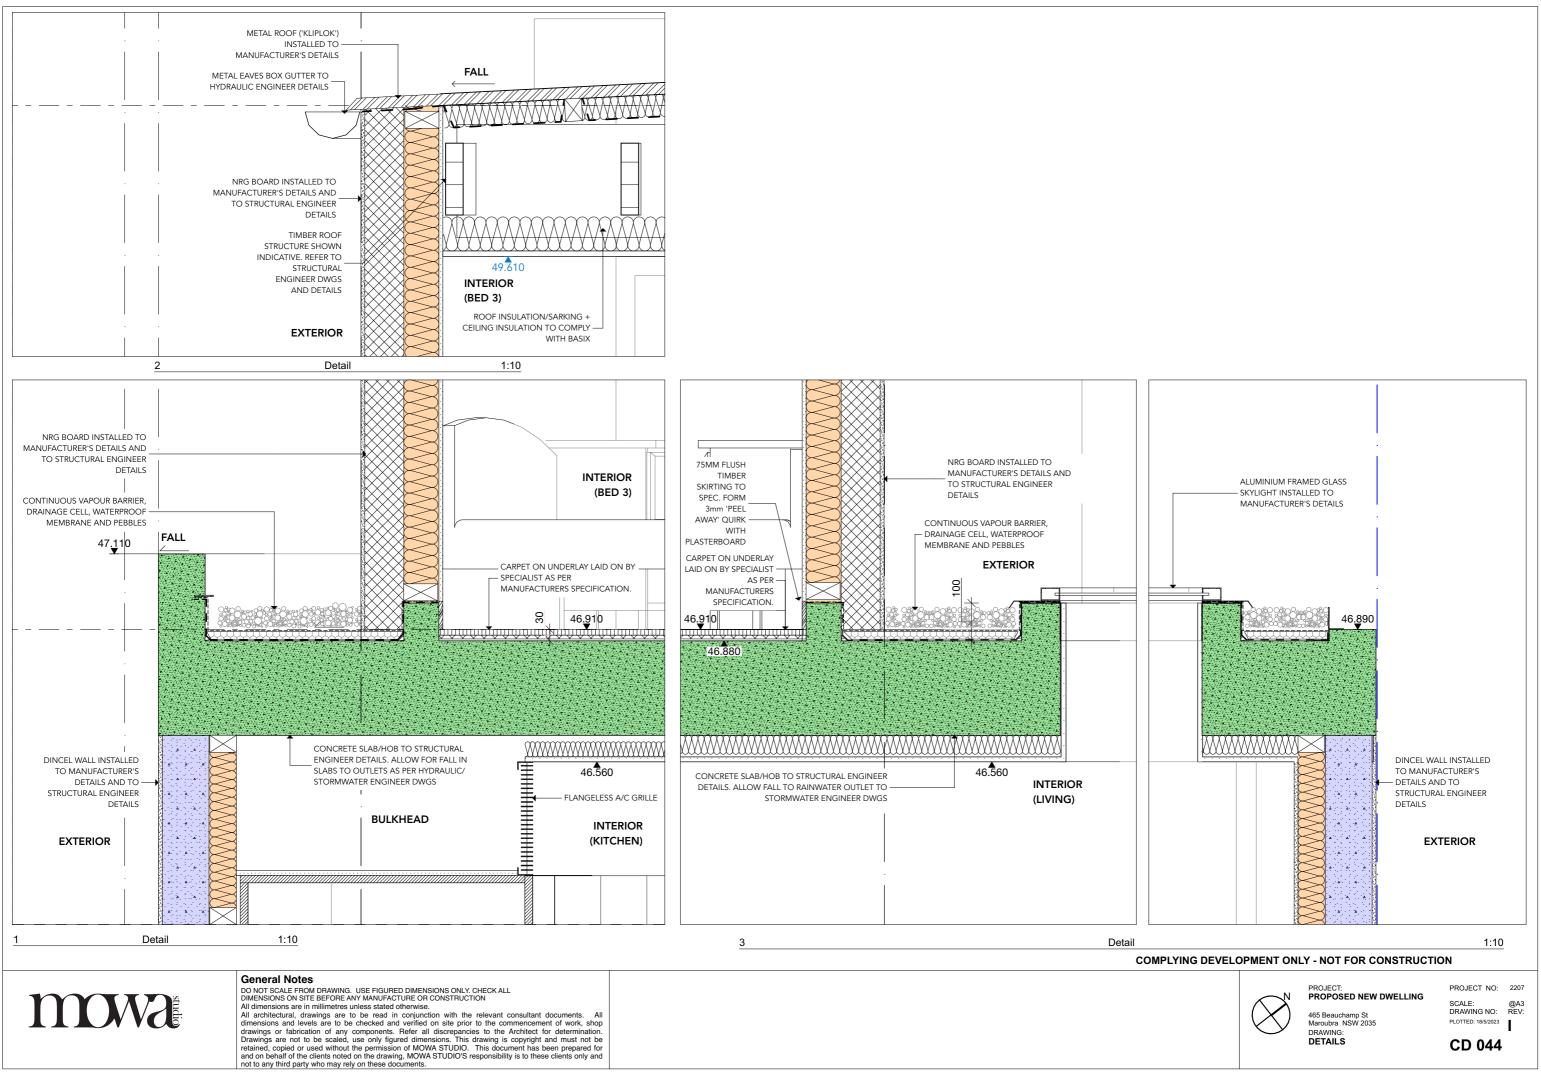

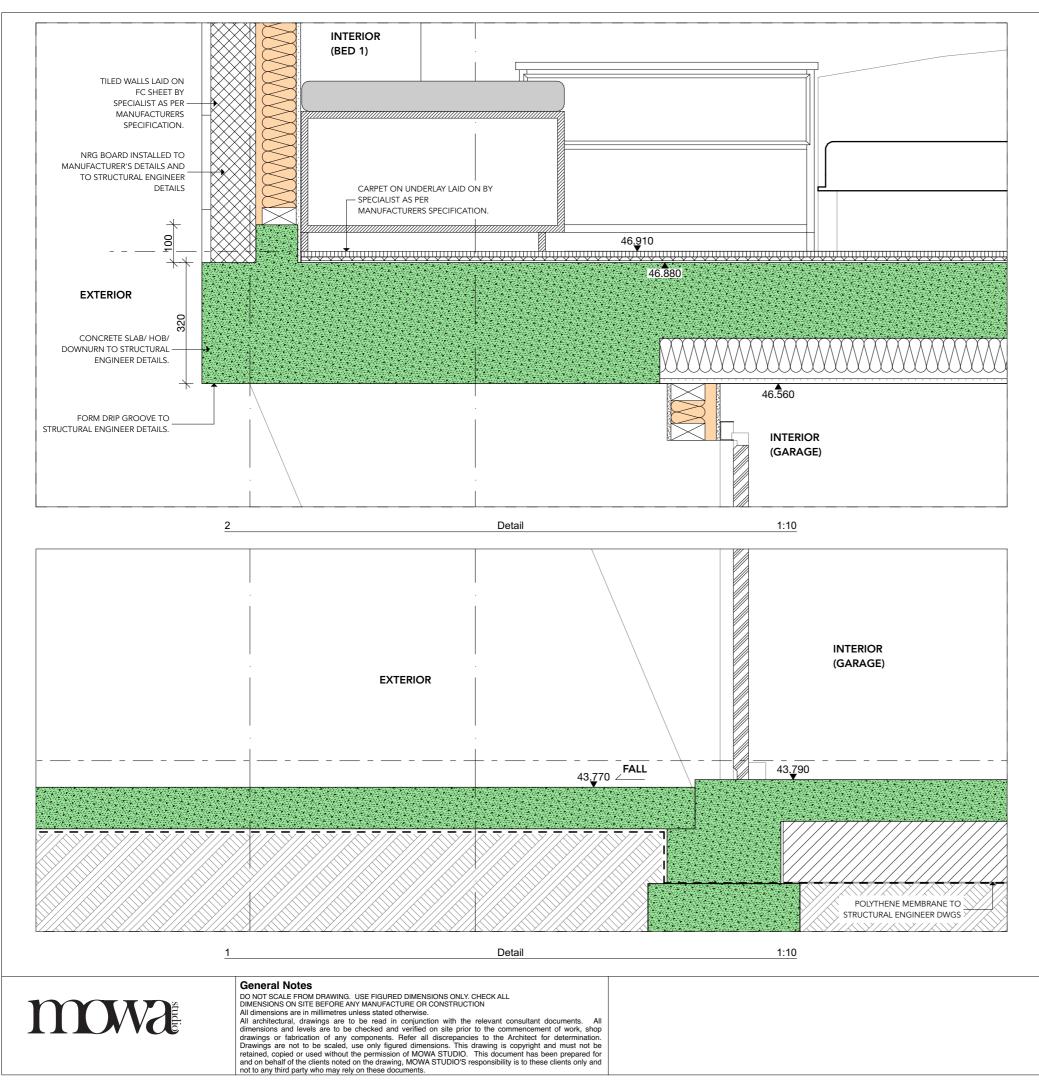



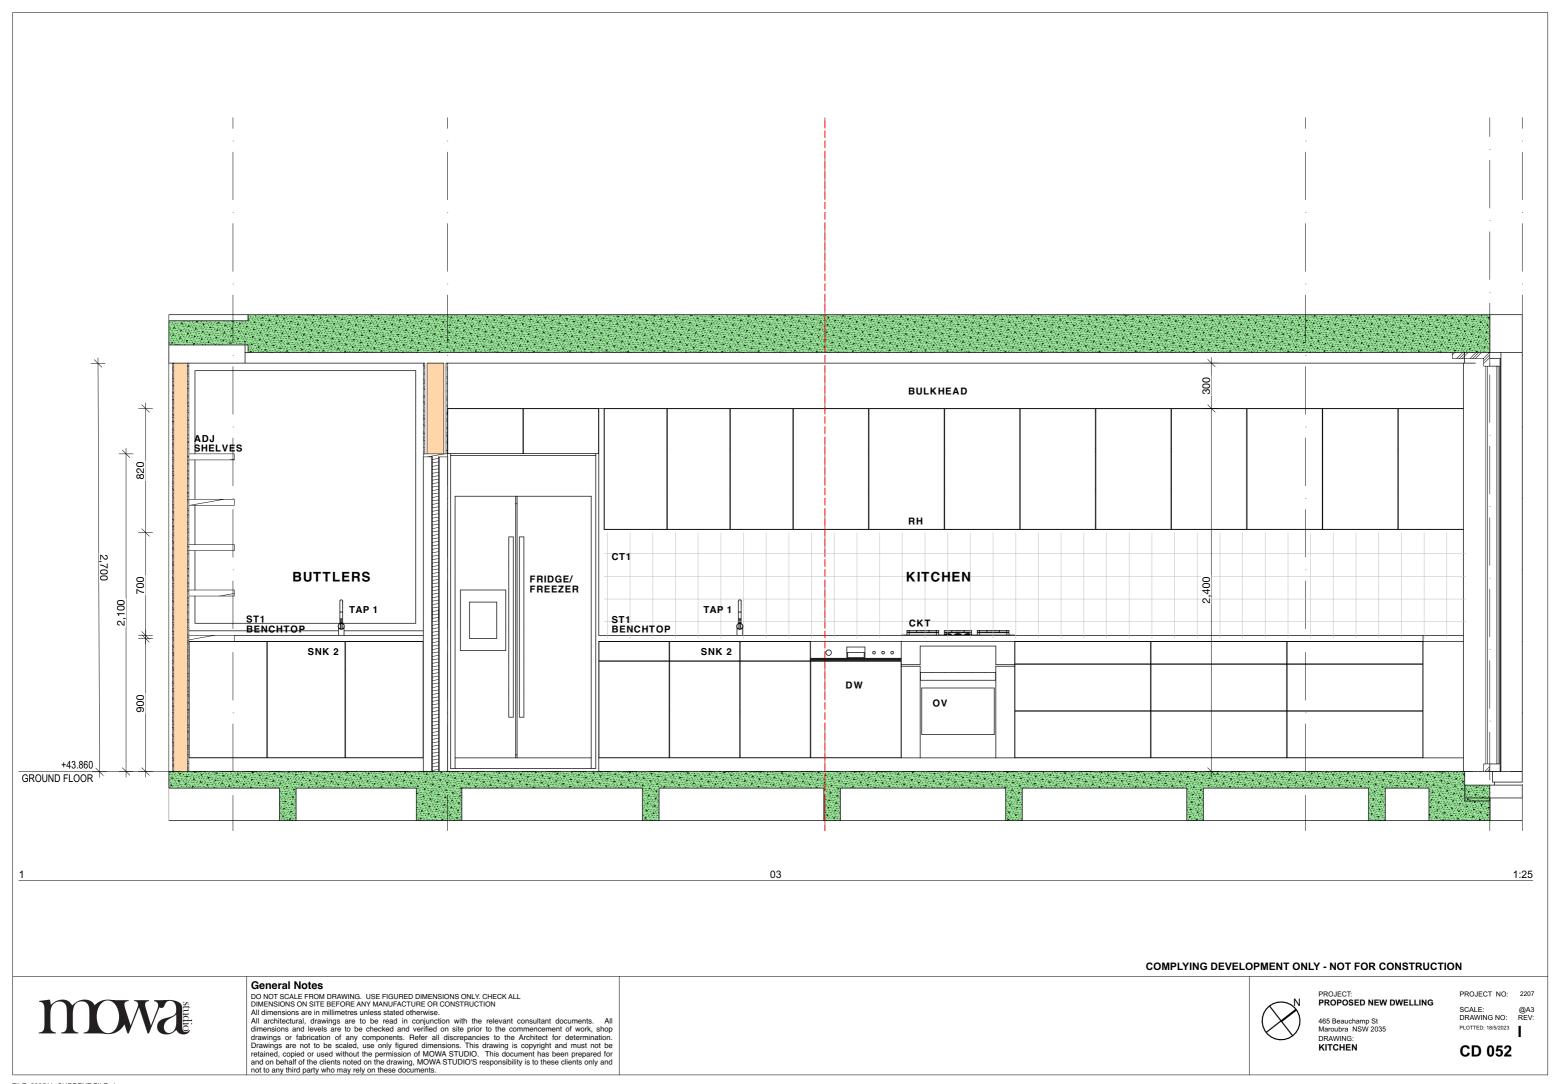


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465 Beauchamp St Maroubra NSW 2035 DRAWING: KITCHEN

SCALE: @A3 DRAWING NO: REV: PLOTTED: 18/5/2023





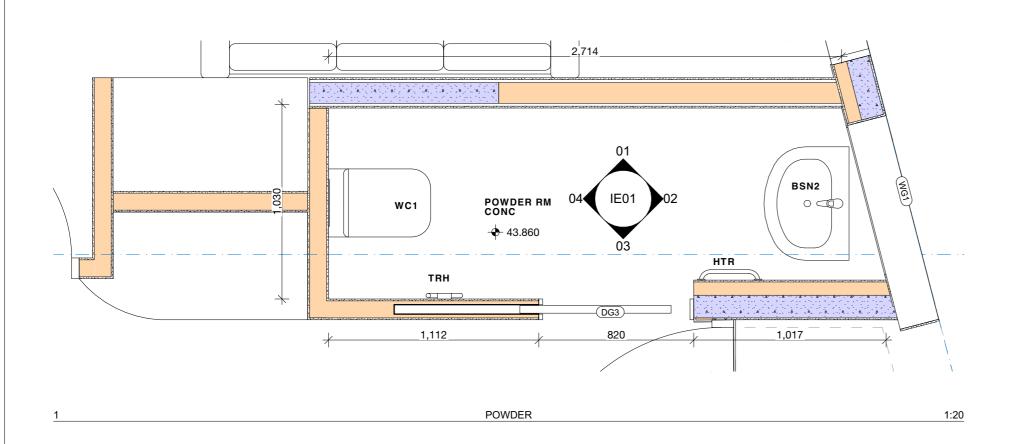

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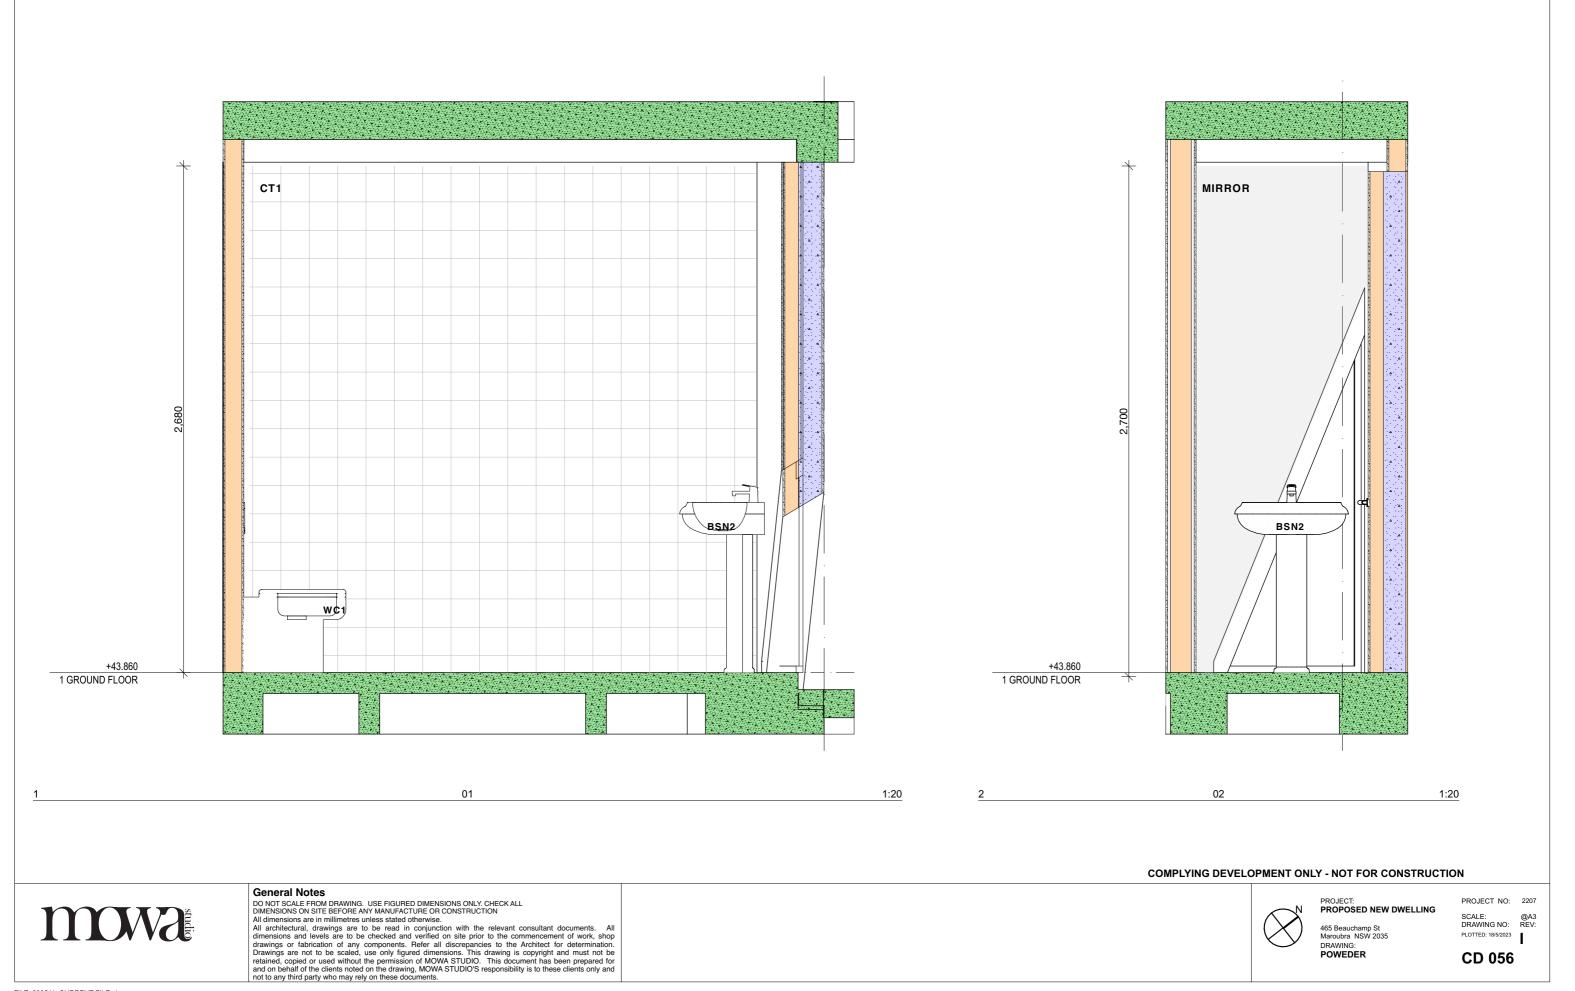
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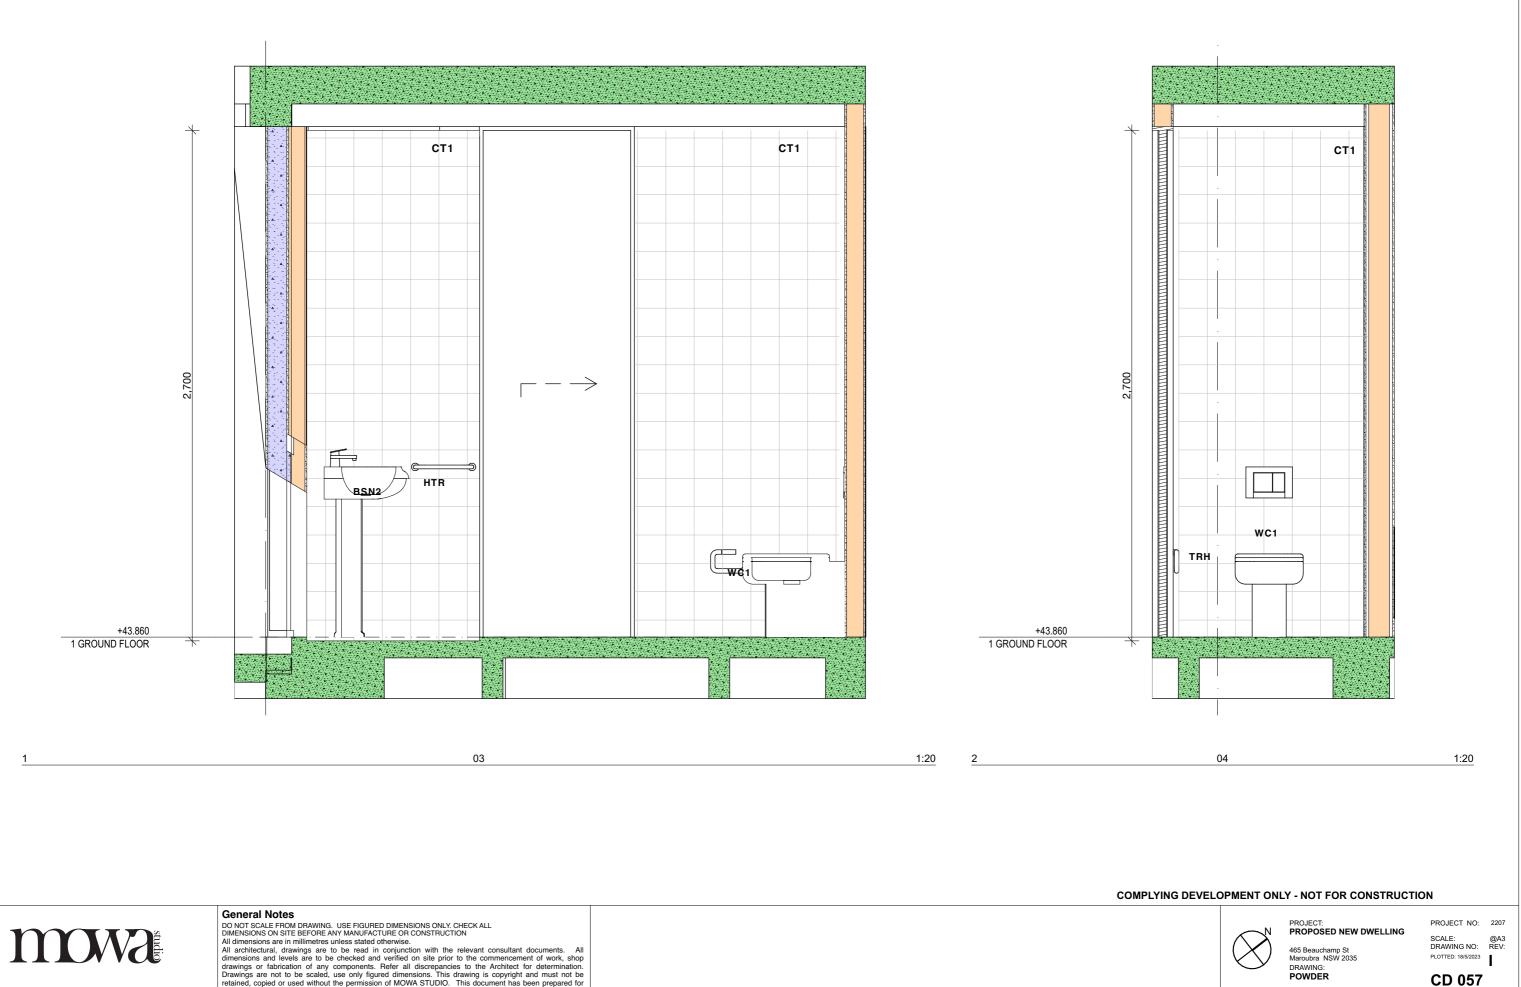



PROJECT: PROPOSED NEW DWELLING

465 Beauchamp St Maroubra NSW 2035 DRAWING: **POWDER**







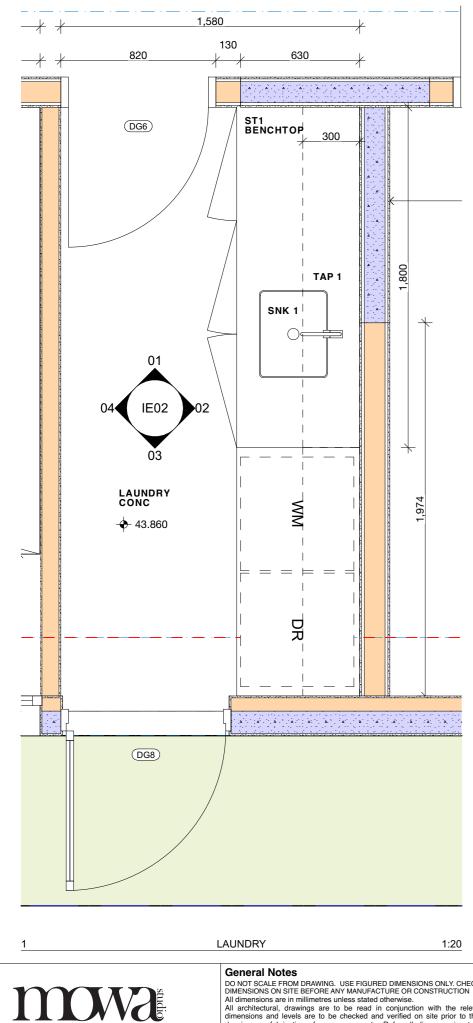


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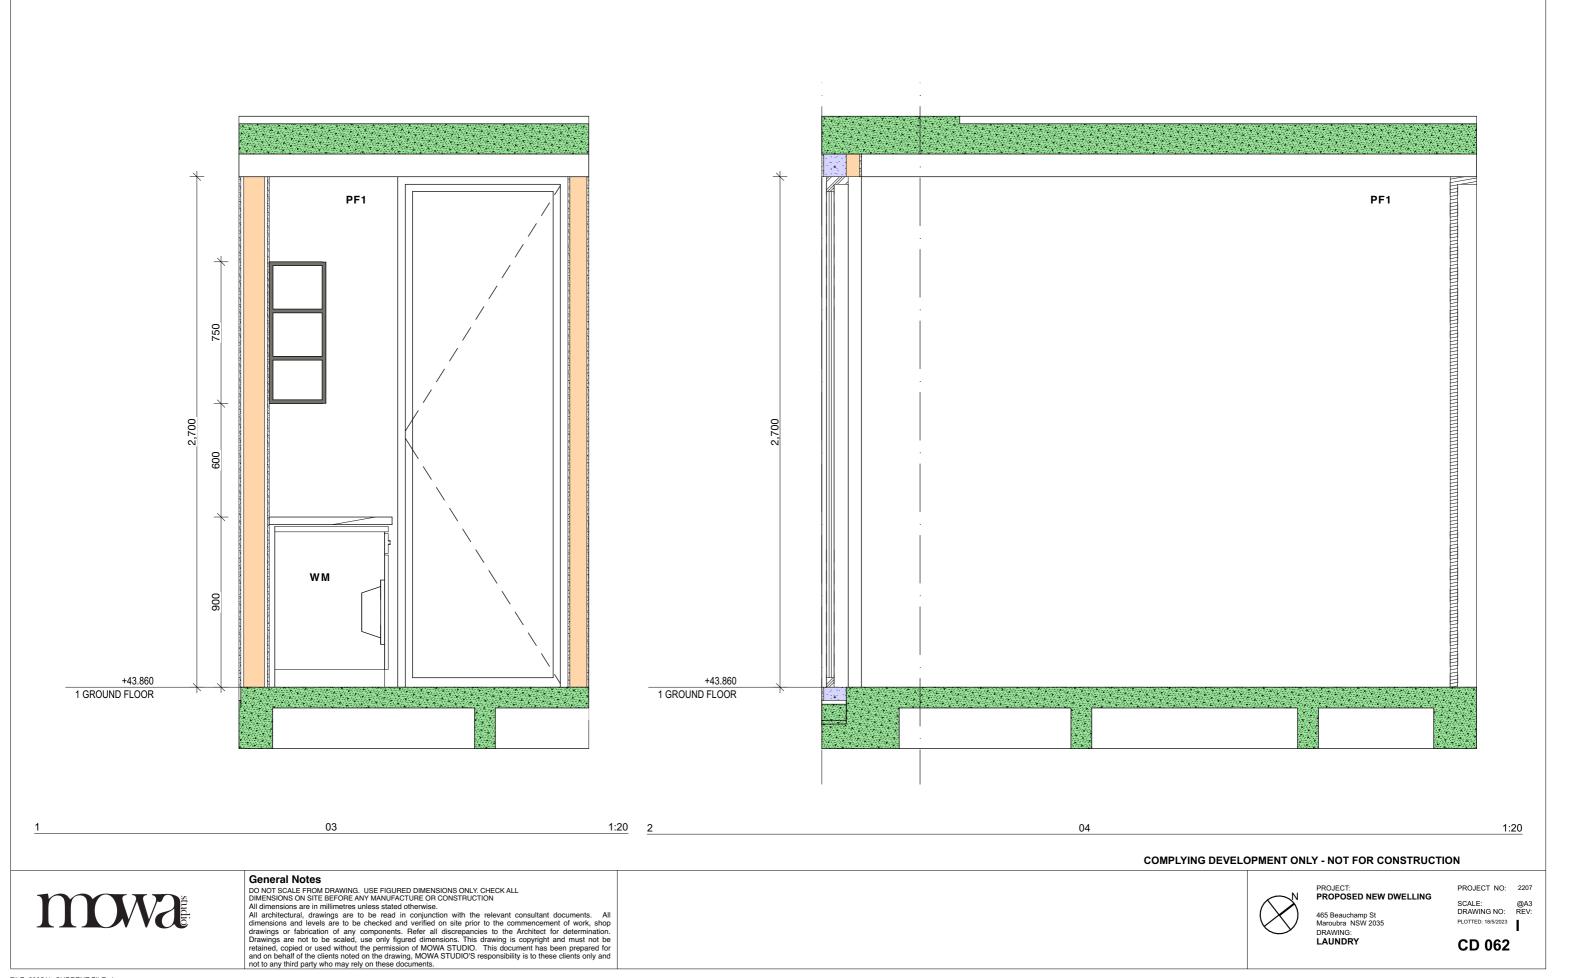



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465 Beauchamp St Maroubra NSW 2035 DRAWING: LAUNDRY







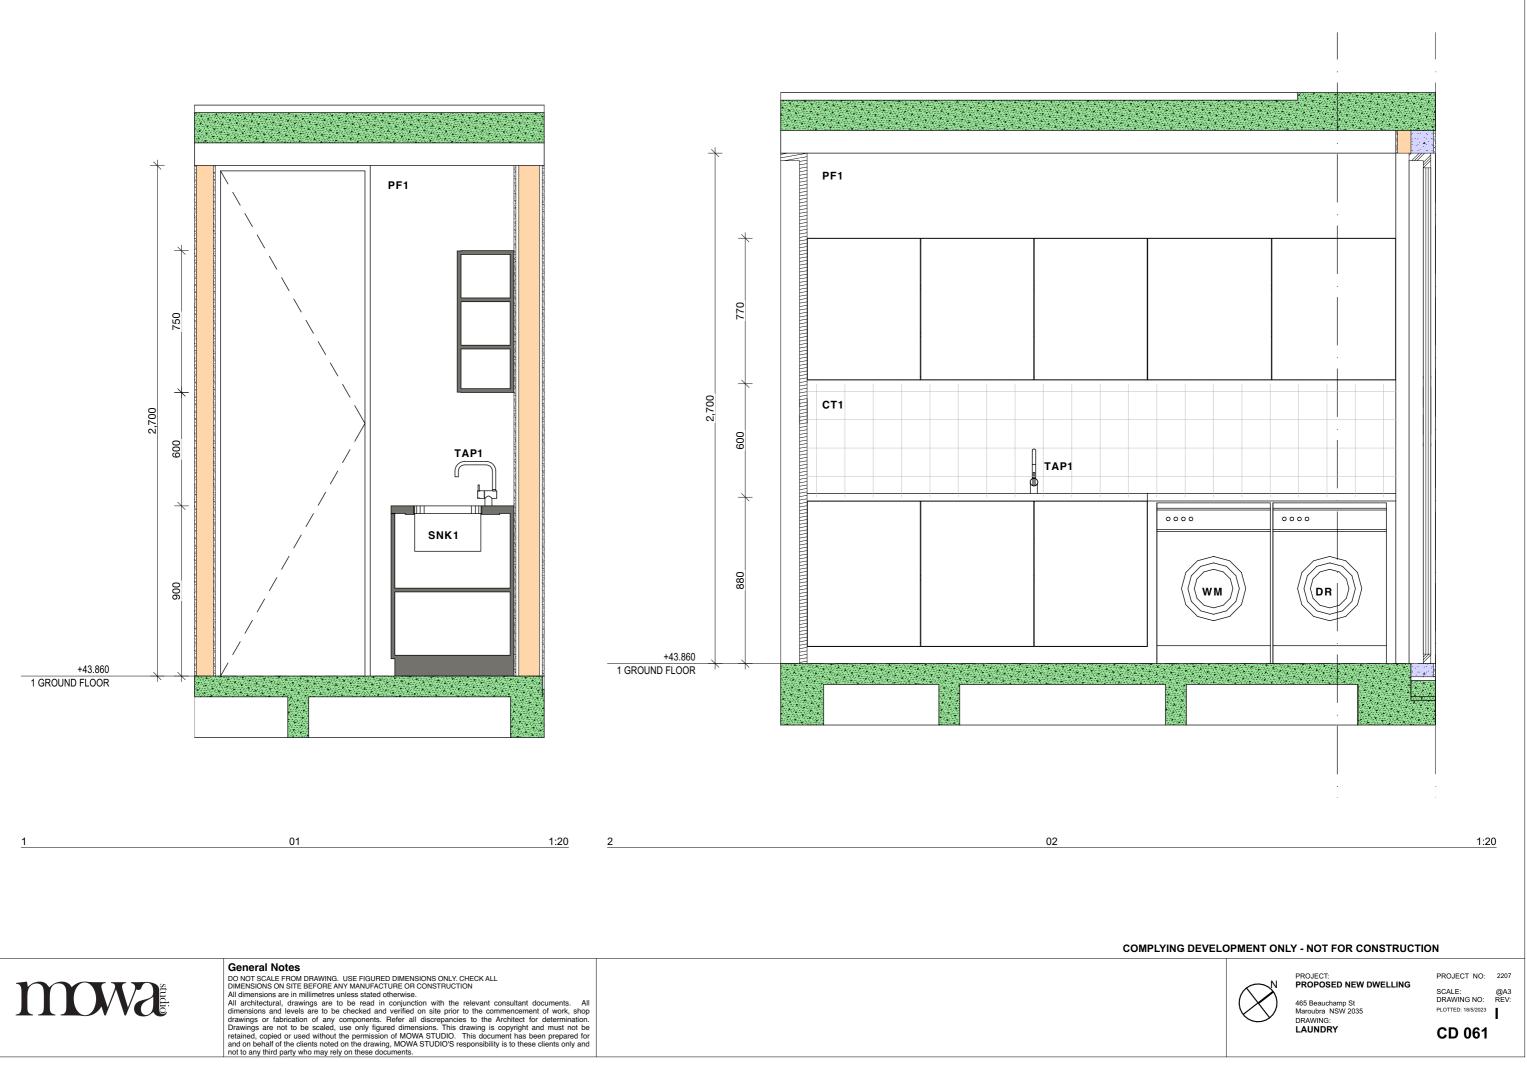

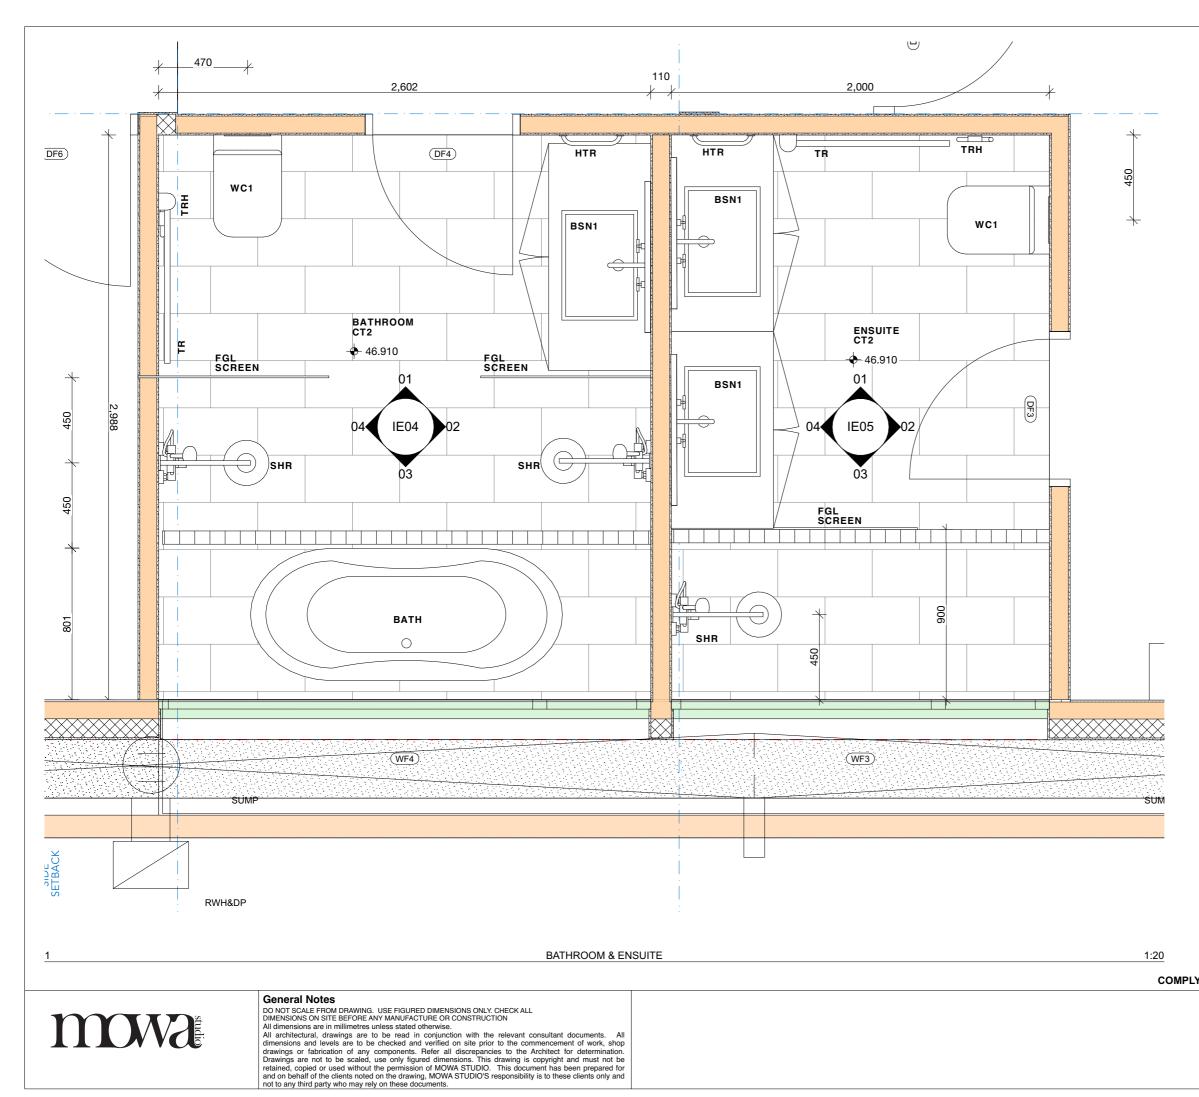
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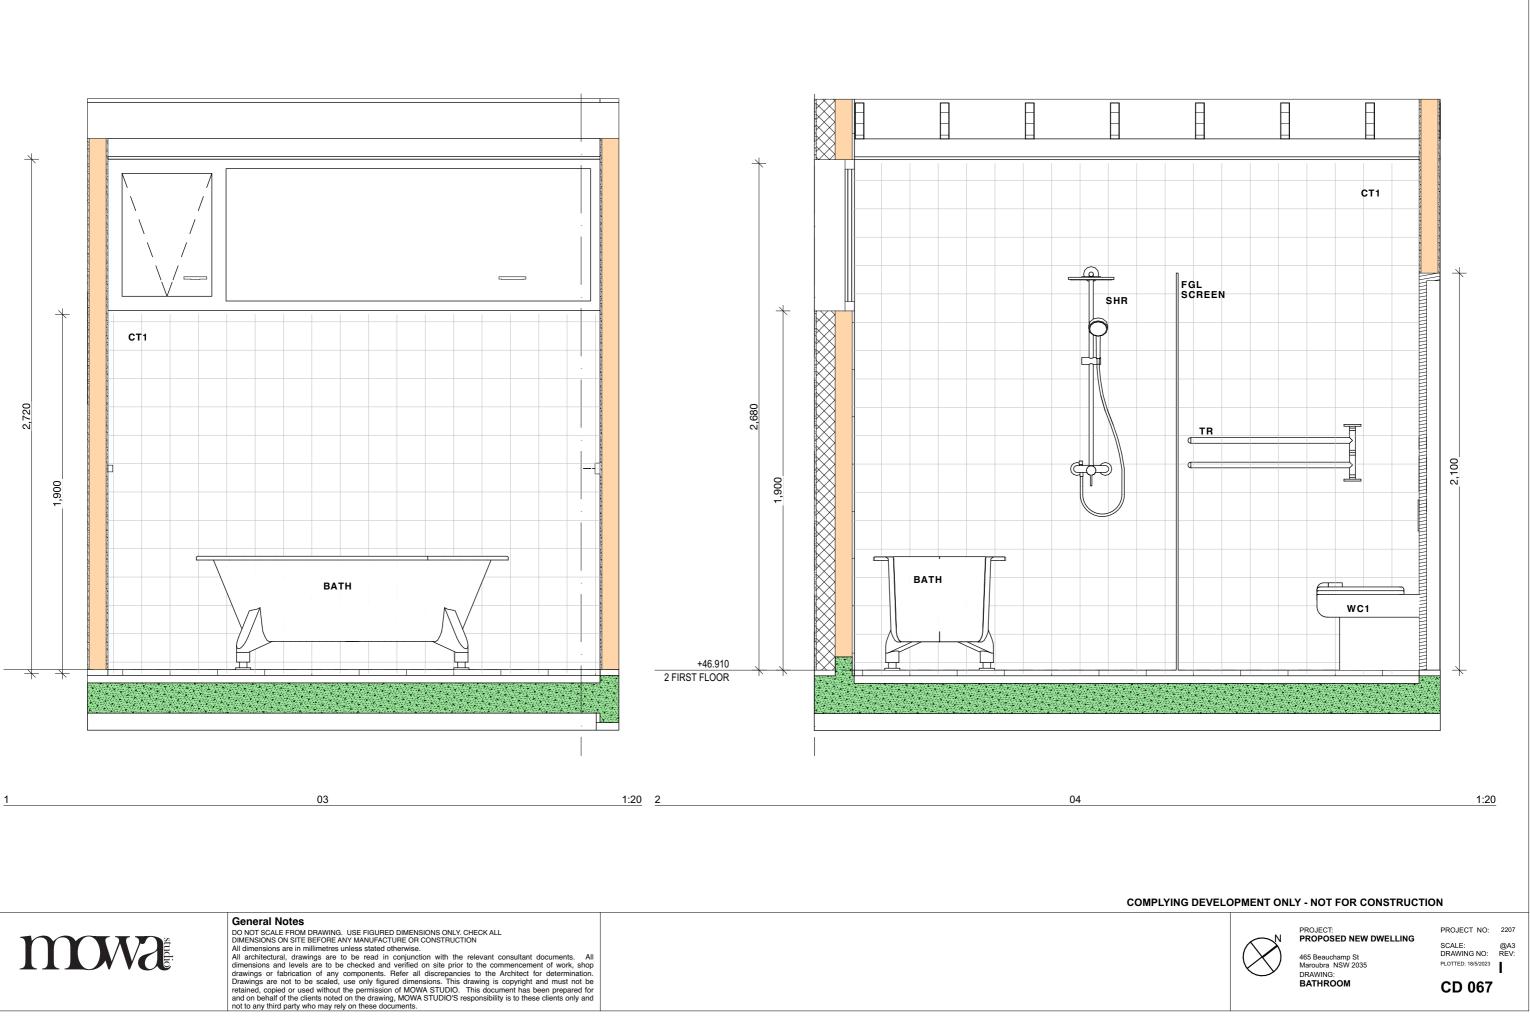



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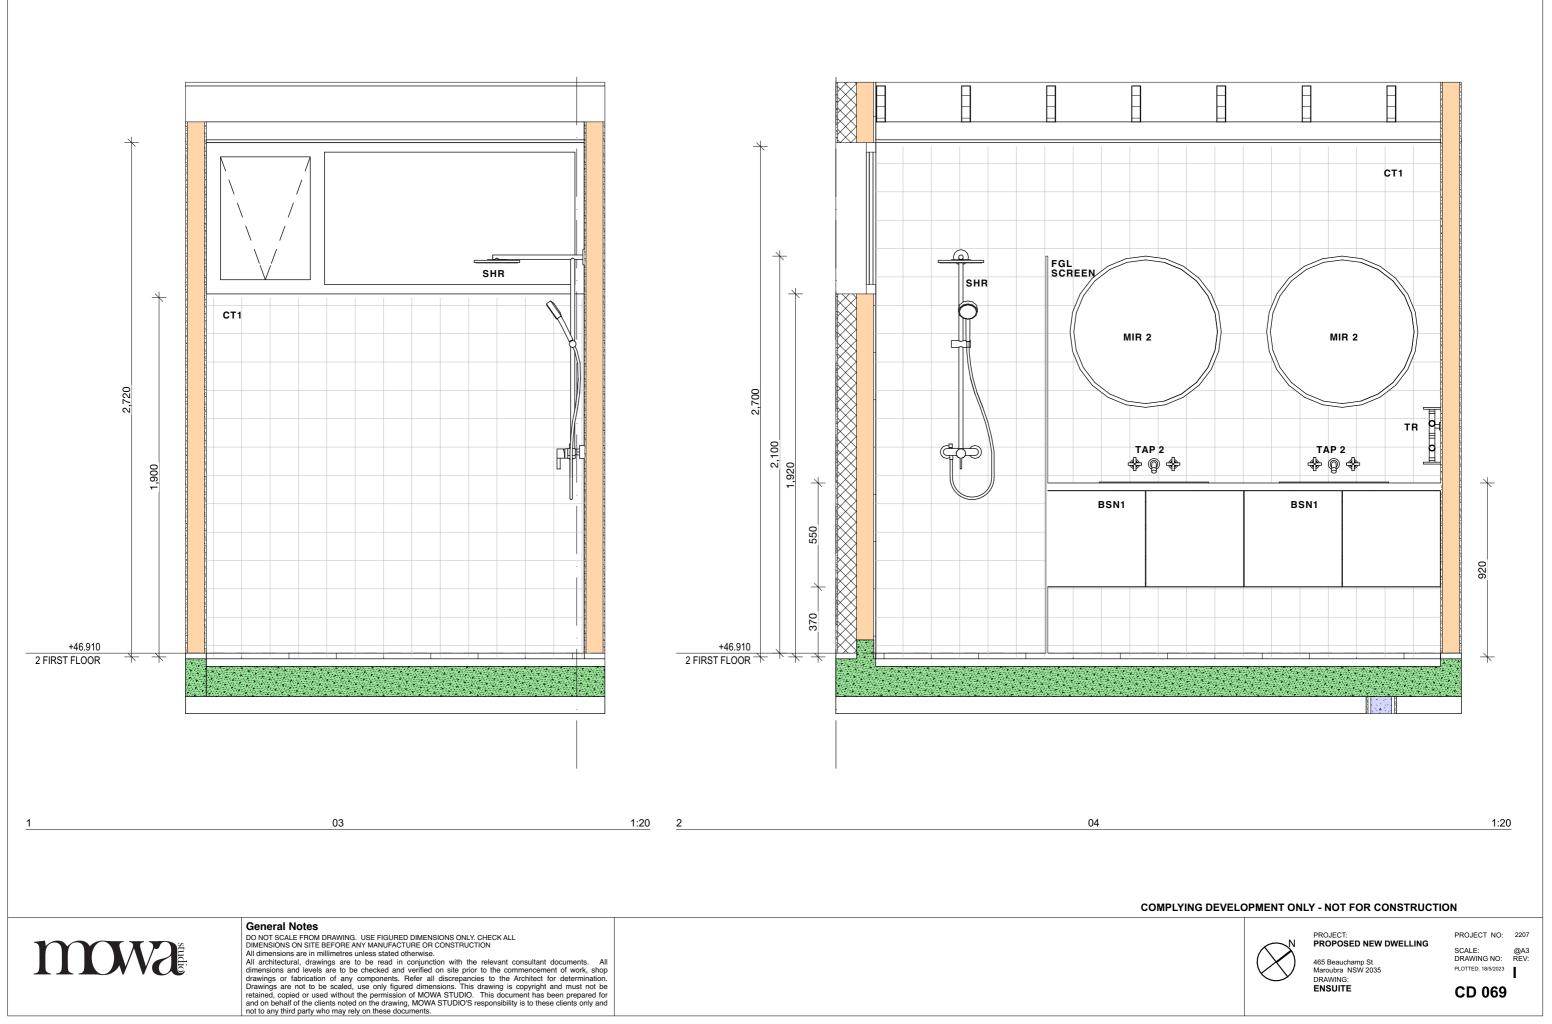
465 Beauchamp St Maroubra NSW 2035 DRAWING: BATHROOM & ENSUITE








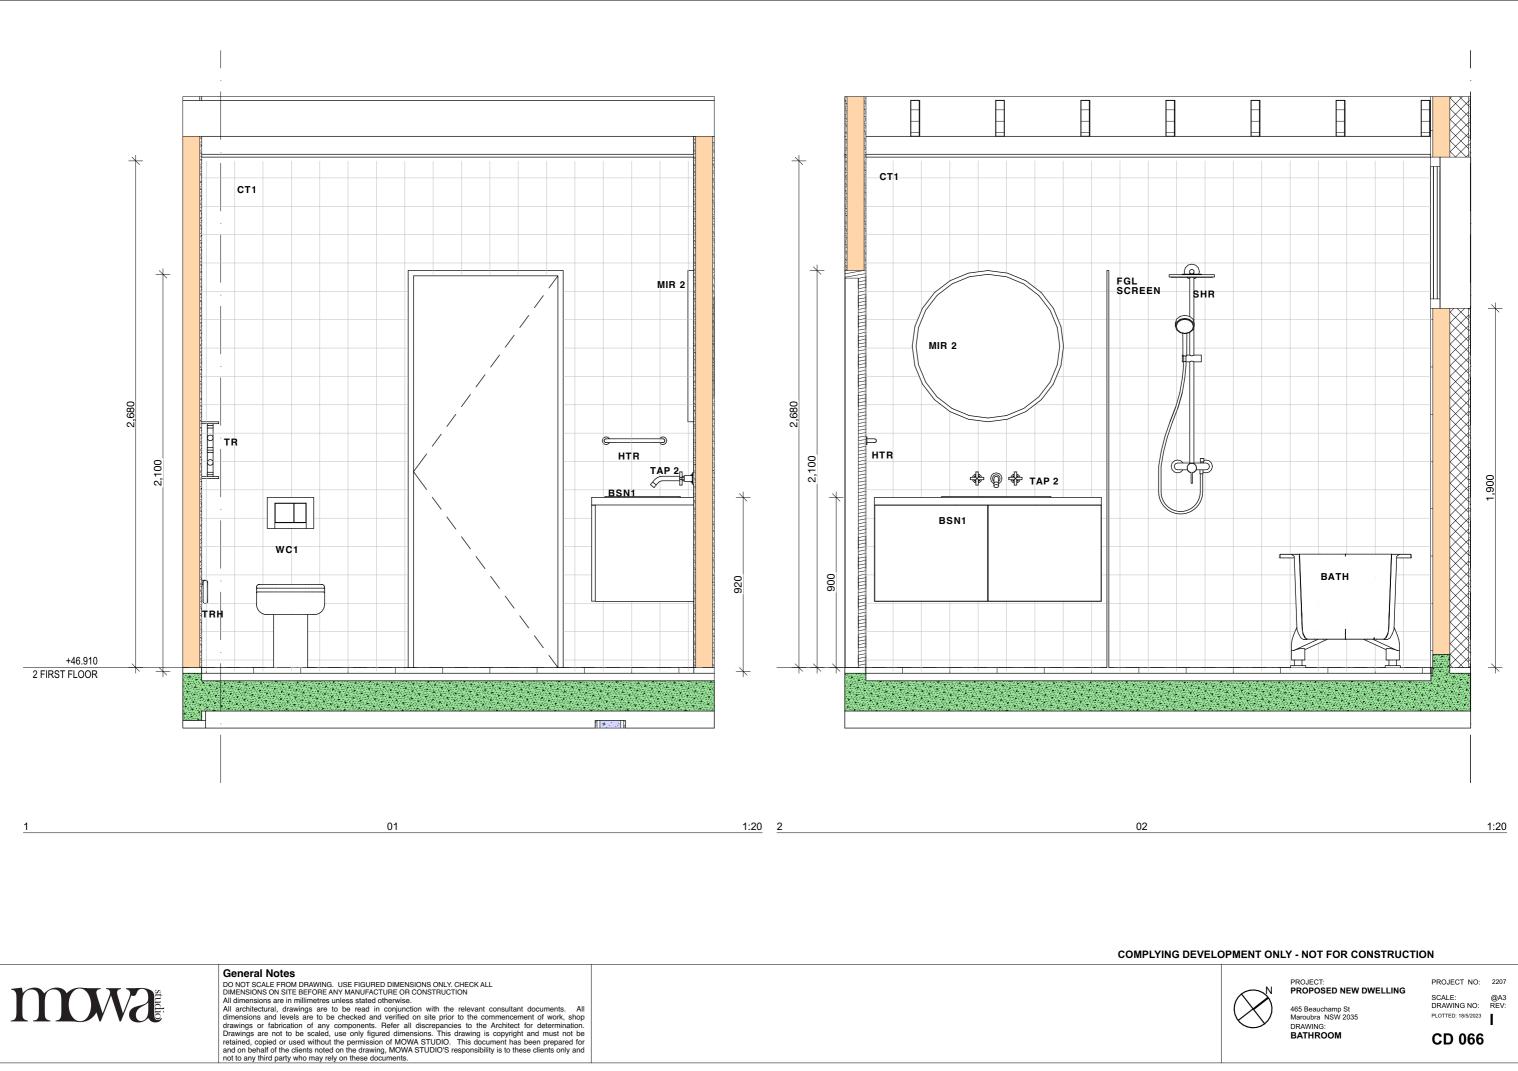

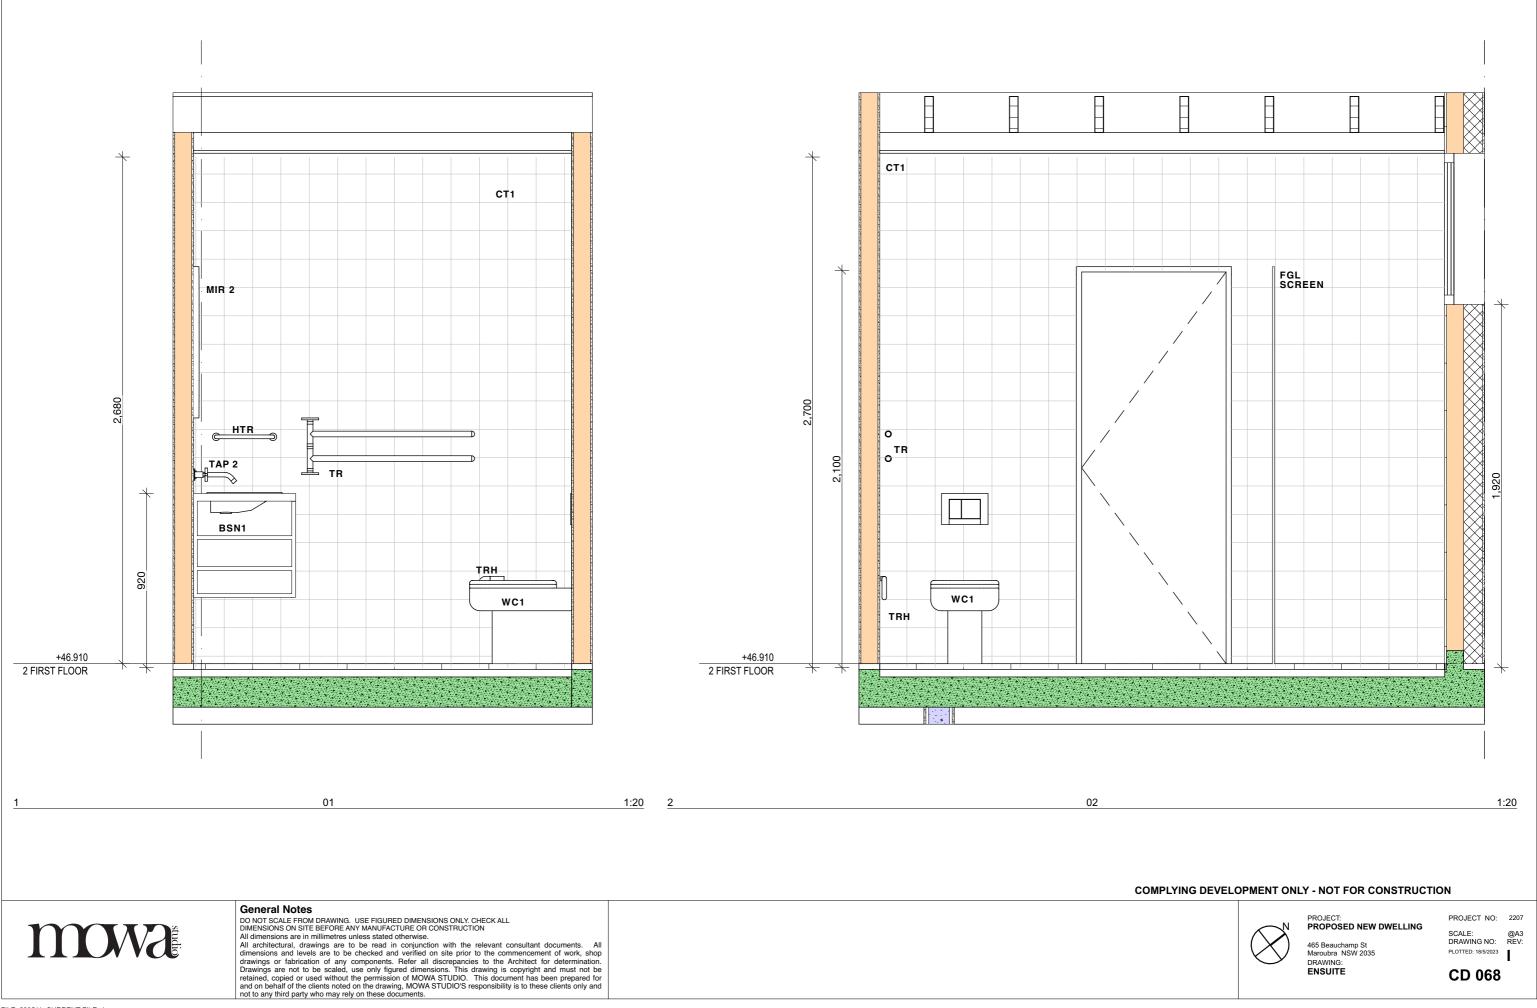

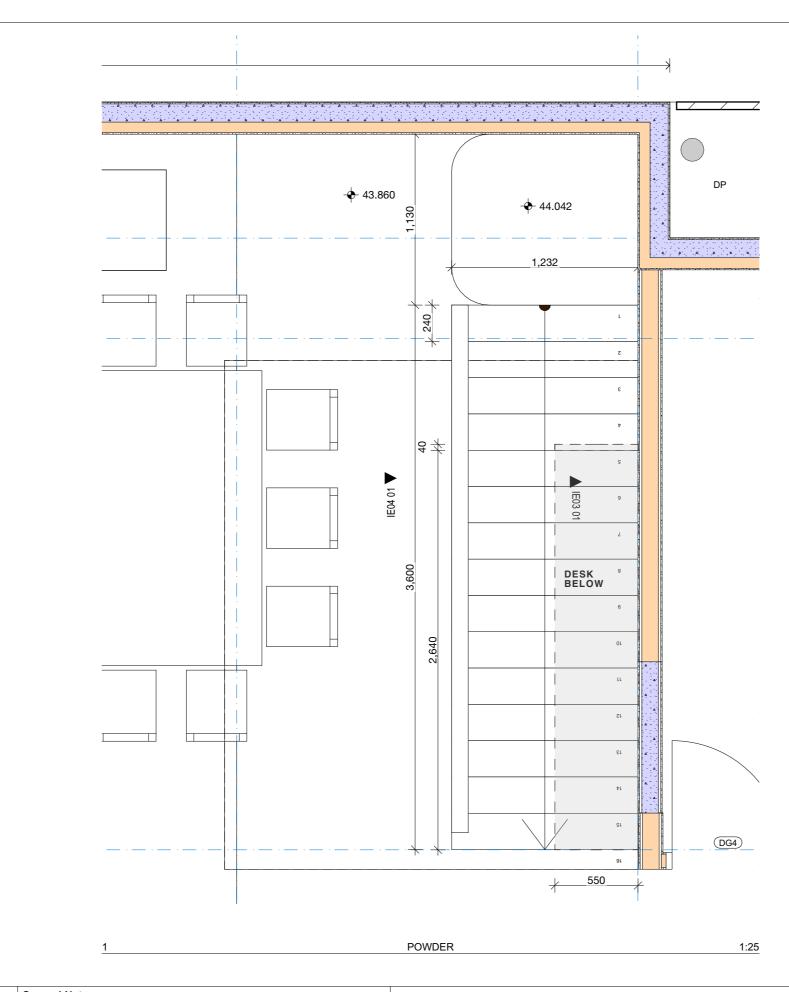

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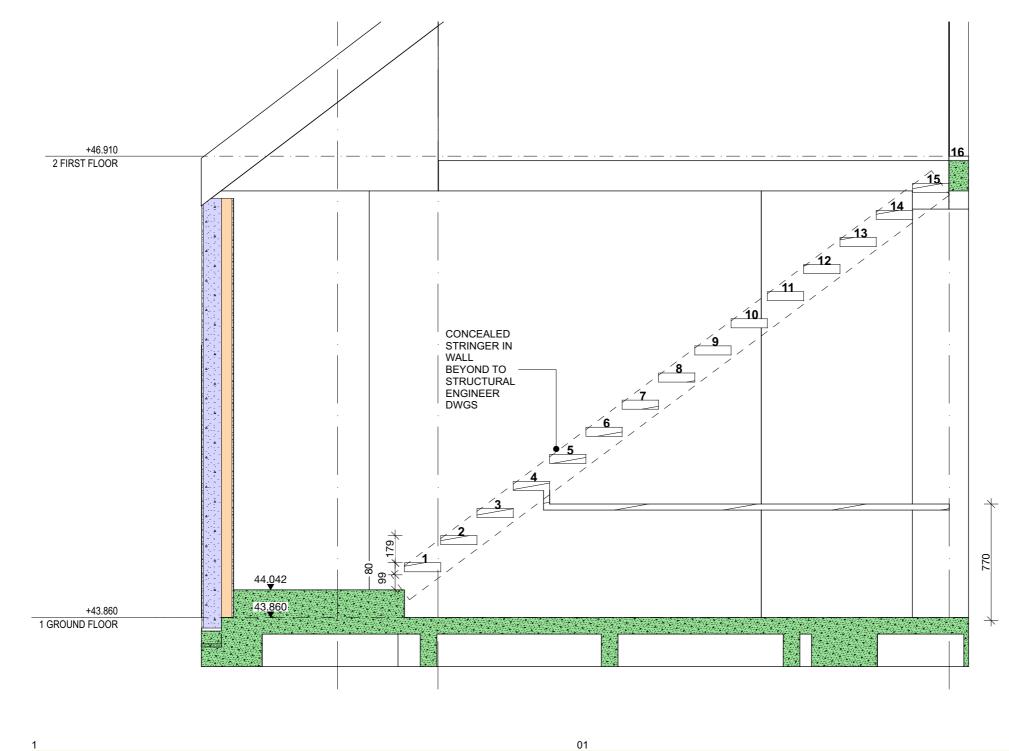
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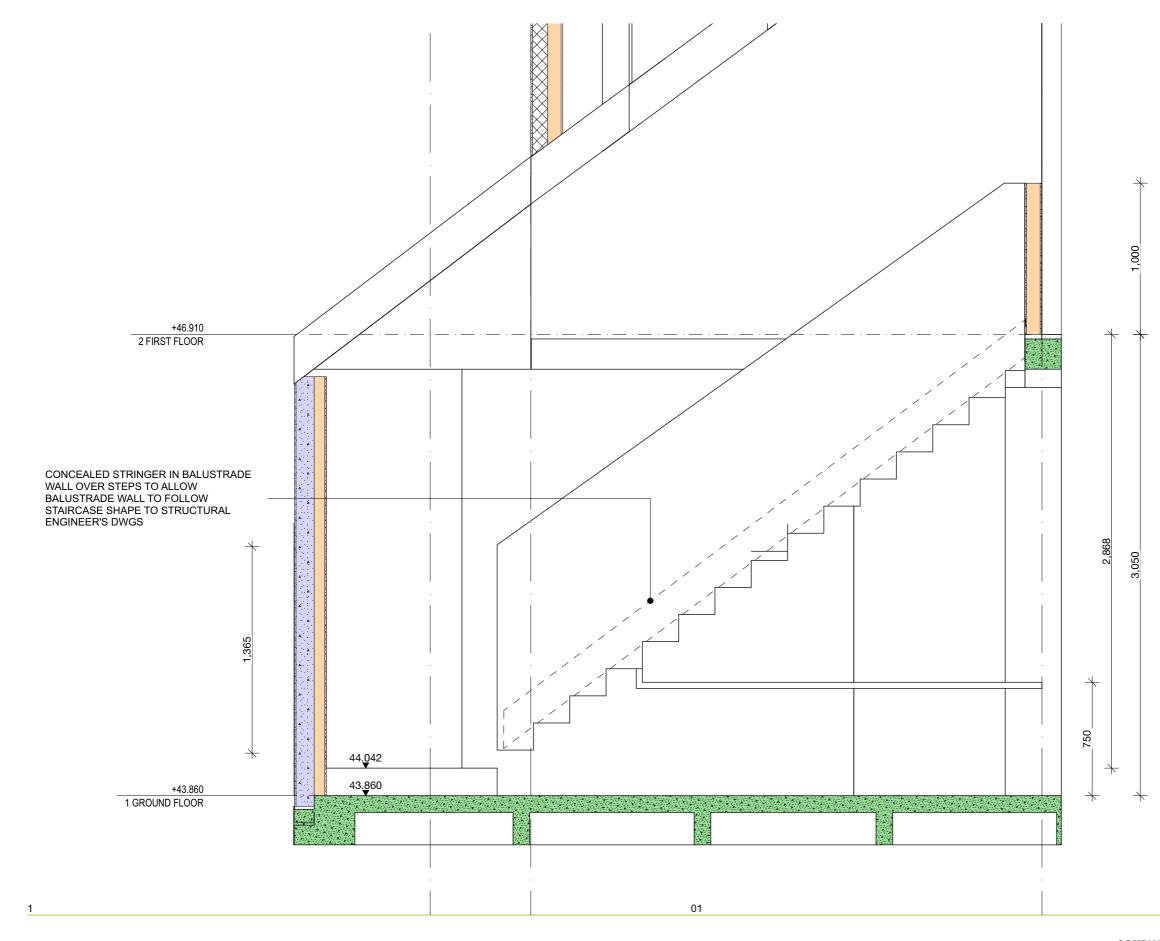
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465 Beauchamp St Maroubra NSW 2035 DRAWING: STAIR





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465 Beauchamp St Maroubra NSW 2035 DRAWING: STAIR

