Governors Bay Jetty Project: Issued For Tender Status:

26 July 2021 Date:

Drawing List

Sheet No.	Title	Revision
01	Site Plan Existing and Proposed	D
02	Pile Setout Plan	D
03	Landward End Plan	D
04	Middle & Seaward End Plan	D
05	Long Section	D
06	Ramp Cross Sections	D
07	Bent B01 to B03 Cross Sections & Plan Details	D
08	Bent B04 Cross Section & Plan Details	D
09	Bent B05 Cross Section & Plan Details	D
10	Bent B06 Cross Section & Plan Details	D
11	Bent B07 Cross Section & Plan Details	D
12	Bent B08, B7.5, B8.5, B27.5 & B28.5 Cross Sections & Plan Details	D
13	Bent B09, B10 to B26 & B30 to B52 Cross Sections & Plan Details	D
14	Bent B27, B28 & B29 Cross Sections & Plan Details	D
15	Bent B53, B54 & B55 Cross Sections & Plan Details	D
16	Typical Pile and Bracing Connection Details	D
17	Typical Handrail and Pontoon Connection Details	D
18	Typical Ladder, Decking, Abutment and Details	D

Masonry Nail in Flush in Concrete RL 3.203

Site Benchark

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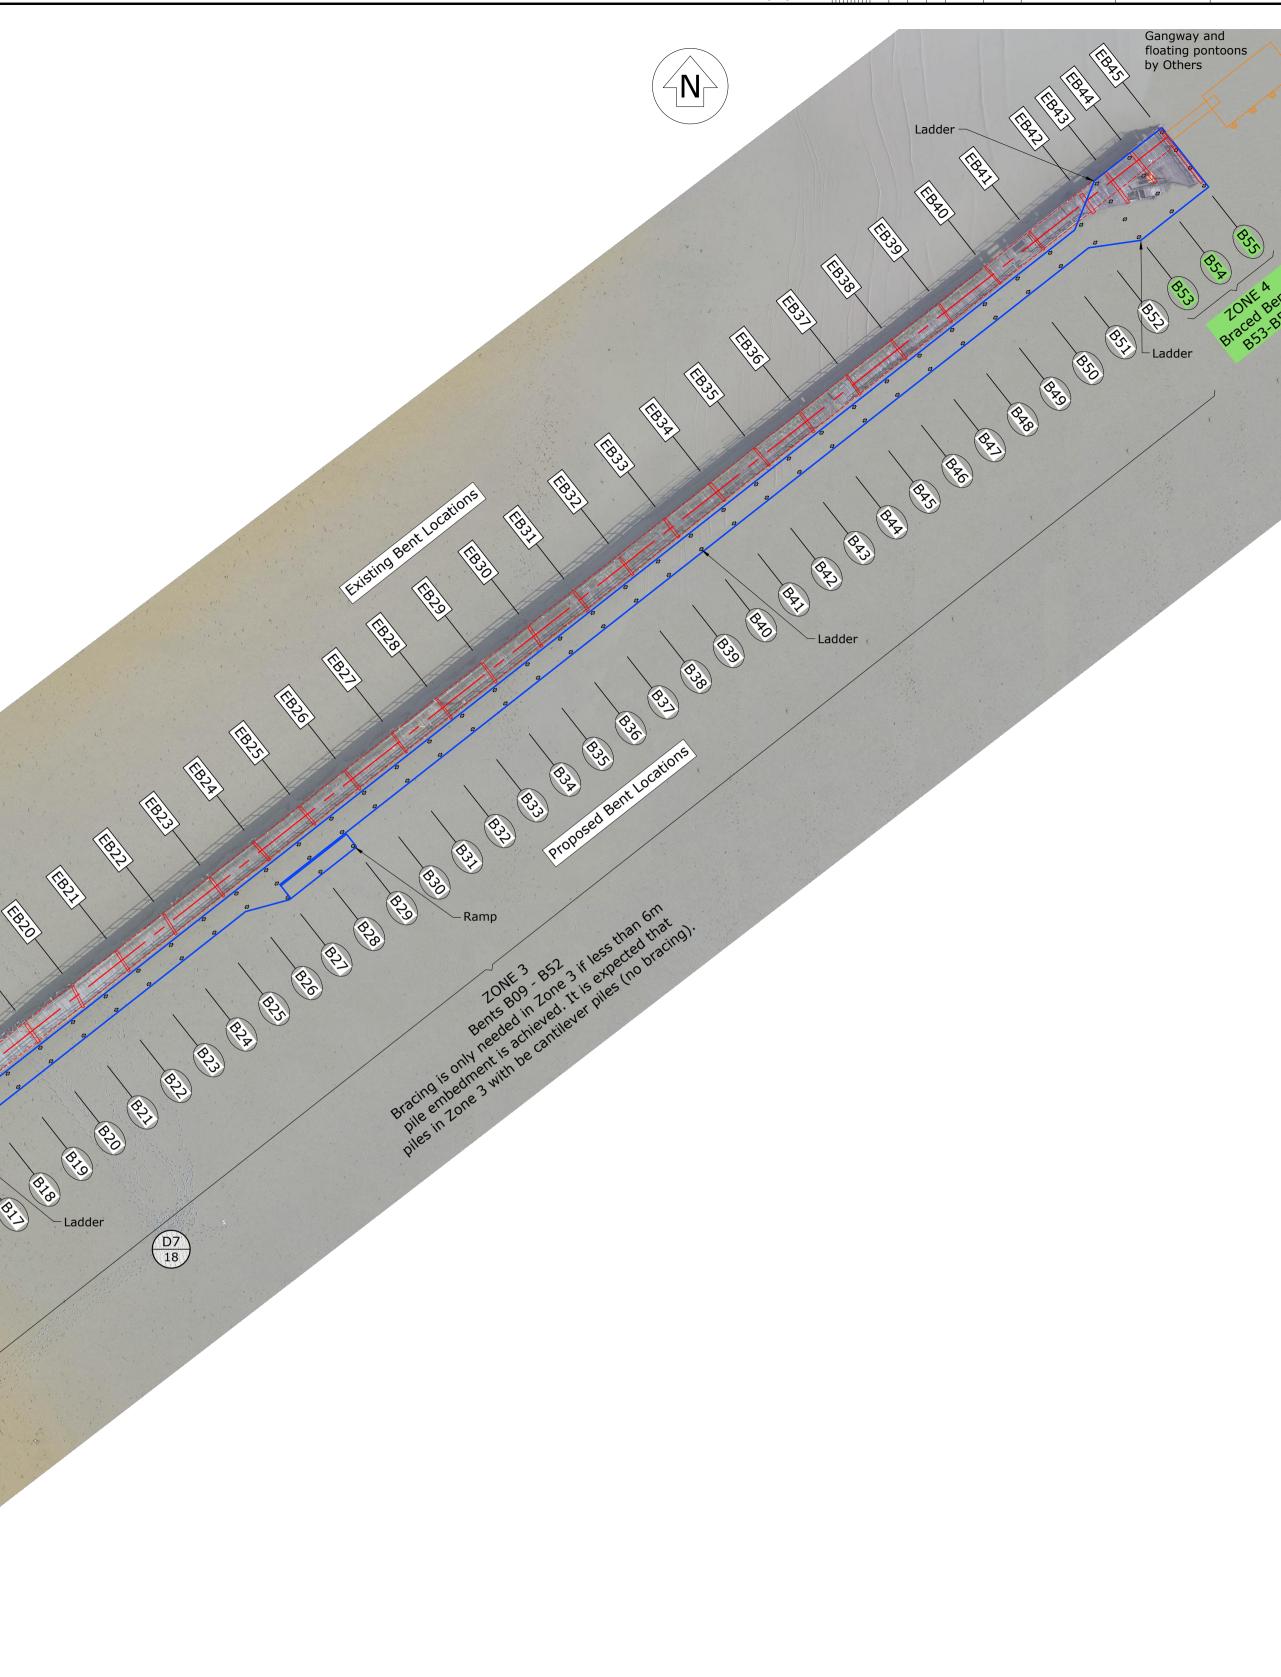
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Rev.	Description	Drawn	Date	Surveyed:	Survey Date:		Name
А	Draft for comment	BJS	31.01.2020	Coord Customer		Designed	T. Arn
В	For Building Consent	VM	20.04.2020	Coord System: NZGD2000		Drawn	B. Ste
С	For ESP Internal Review	BJS	03.06.2021	Mt Pleasant 2000	Drg. Chk	T. Arn	
D	For Tender	BJS	26.07.2021	Calibration:		Proj. Mgr	N. Ha
				Origin of Levels: AF0Q SS Pin, Capped	Datum:	Design Rev -	/iew
				Main Road R.L. 55.085 (LINZ Dec 2013)		Approved	

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Site Plan Scale 1:500

e	Date	Client	Project Title	
mstrong	21.11.2019		Governors Bay Jetty	
ewart	09.12.2019			
mstrong	30.01.2020	GOVERNORS BAY JETTY	Drawing Title	
arwood	31.01.2020	RESTORATION TRUST	Site Plan	
	Date		Existing and Proposed	
	-			
	Date		Scales 1:500 [A1] 1:1000 [A3]	

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Notes:

General:

- All work shall comply with the New Zealand Building Code.
 The Contractor shall check all dimensions onsite prior to commencing work. - The project drawings shall be read in conjunction with the specification. Any discrepancies shall be referred to the Engineer for review and approval prior to
- proceeding. - On completion of the work, the contractor shall provide PS3 Construction Producer
- Statements for the construction work. The form of the PS3 shall be as per the Christchurch City Council Standard form B-085.

Workmanship:

- Timber construction shall be undertaken in accordance with best trade practice, and this shall be deemed to include those methods, practises and processes contained in current syllabuses for New Zealand Trade Certificates in carpentry, joinery and New Zealand Timber Industry Federation Timber Design Guide. Reference should also be made to the appropriate New Zealand Standards.

- All steelwork, fabrication, welding and erection shall comply with NZS3404:1997 & NZS5131. Where conflicts exist, the stricter requirements shall apply.

Timber Grades:

- Decking, balustrade framing (posts, rails and toe kicks): Eucalyptus Globoidea Heart Wood.
- No sapwood or corewood. Corewood includes the pith plus surrounding wood with a density less than 80% that of the density of mature trees.
- Visual graded in accordance with AS2082:2007 to achieve:
- -- Balustrade Framing & Decking Structural Grade 3 - Minimum characteristic properties:
- -- Bending strength fb = 48MPa
- -- Modulus of elasticity E = 13.6GPa
- Minimum natural durability class 2 to AS5604, equivalent to hazard class H3.2 to DZ3602.

Stringer Beams, Pile Capping Beams and Balustrade Under Deck Blocking:

- Mixed Australian hardwoods. - To comply with AS3818.7.
- Minimum stress grade F27 to AS1720.1
- Minimum natural durability class 1 to AS5604 or natural durability class 2 with additional CCA treatment to hazard class H5.
- Ramp timber including stringers, associated capping beams and deck planks located below high tide mark:
- Mixed Australian hardwoods. - To comply with AS3818.7.
- Minimum stress grade F27 to AS1720.1

- Minimum natural durability class 1 & marine borer durability class 1 to AS5604 or, natural durability class 2 with additional CCA treatment to hazard class H6.

300 SED piles:

- Mixed Australian hardwoods. - To comply with AS3818.3.
- Minimum stress grade F22.

- Minimum durability class 2 to AS5604 with additional CCA treatment to hazard class H6. Bracing:

- NZ Radiata Pine round timber TTT UniLog .
- Minimum outer zone density of 450kg/m3.
- CCA treatment to hazard class H6.

Timber Fixings:

- All steel fixings for timber shall be from grade 316 stainless steel with 2B finish or

- better. - Decking screws to be 14 gauge x 100 long, Type 17 bugle head from grade 316
- stainless steel.
- Balustrade rail bolts & associated washers & nuts may be hot dip galvanised. - Unless noted otherwise, every bolt/threaded rod shall be fitted into prebored holes of a diameter approximately 10% greater than the bolt diameter and be provided with grade
- 316 stainless steel washers under both heads and nuts as follows:

-- M24: 26mm diameter hole with 75x75x6mm square washers -- M20: 22mm diameter hole with 60x60x5mm square washers

- -- M16: 18mm diameter hole with 60x60x5mm square washers
- -- M12: 14mm diameter hole with 50x50x3mm square washers
- -- M10: 12mm diameter hole with 40x40x3mm square washers

- All coach screws shall be fitted into prebored holes of a diameter equivalent to the bolt shank diameter. - Washers shall be sufficiently recessed into all timber faces to full face contact with the

- timber member. - Threaded ends to extend 10-15mm past nut and be burred off to prevent malicious
- removal. - All holes for bolts/threaded rods shall be packed with grease prior to fitting washers and
- nuts - To accommodate shrinkage of jetty members the contractor shall allow to check and
- tighten all associated nuts after 11 months following the construction of the jetty before burring threads.
- Bolt hole locations and timber edge distance dimensions as detailed shall have a tolerance of +/-5mm.

Moisture Content

Moisture content of decking at the time of installation shall be less than 20% to minimise cupping.

Post Treatment of Cut Timber

- Treat the following timber features with a preservative such as 2 coats of Metalex Timber Preservative (or similar approved) in accordance with NZS 3640. - Cut ends, notches, recesses and drilled holes to timber framing located below R.L. =
- 2.9m. - Cut ends, notches and recesses to timber stringers and associated balustrade blocking.

Timber Distortions


- Timber beams shall be placed with natural camber up.
- The Contractor shall allow to correct horizontal bowing of Eucalyptus Globoidea stringer beams by placing them such that adjacent beams have opposing bows and installing midspan blocking. Refer typical detail on drawing Sheet 18.

Tenderers to ignore these comments. EG not used for stringers. Comments to be corrected in later revision of drawings.





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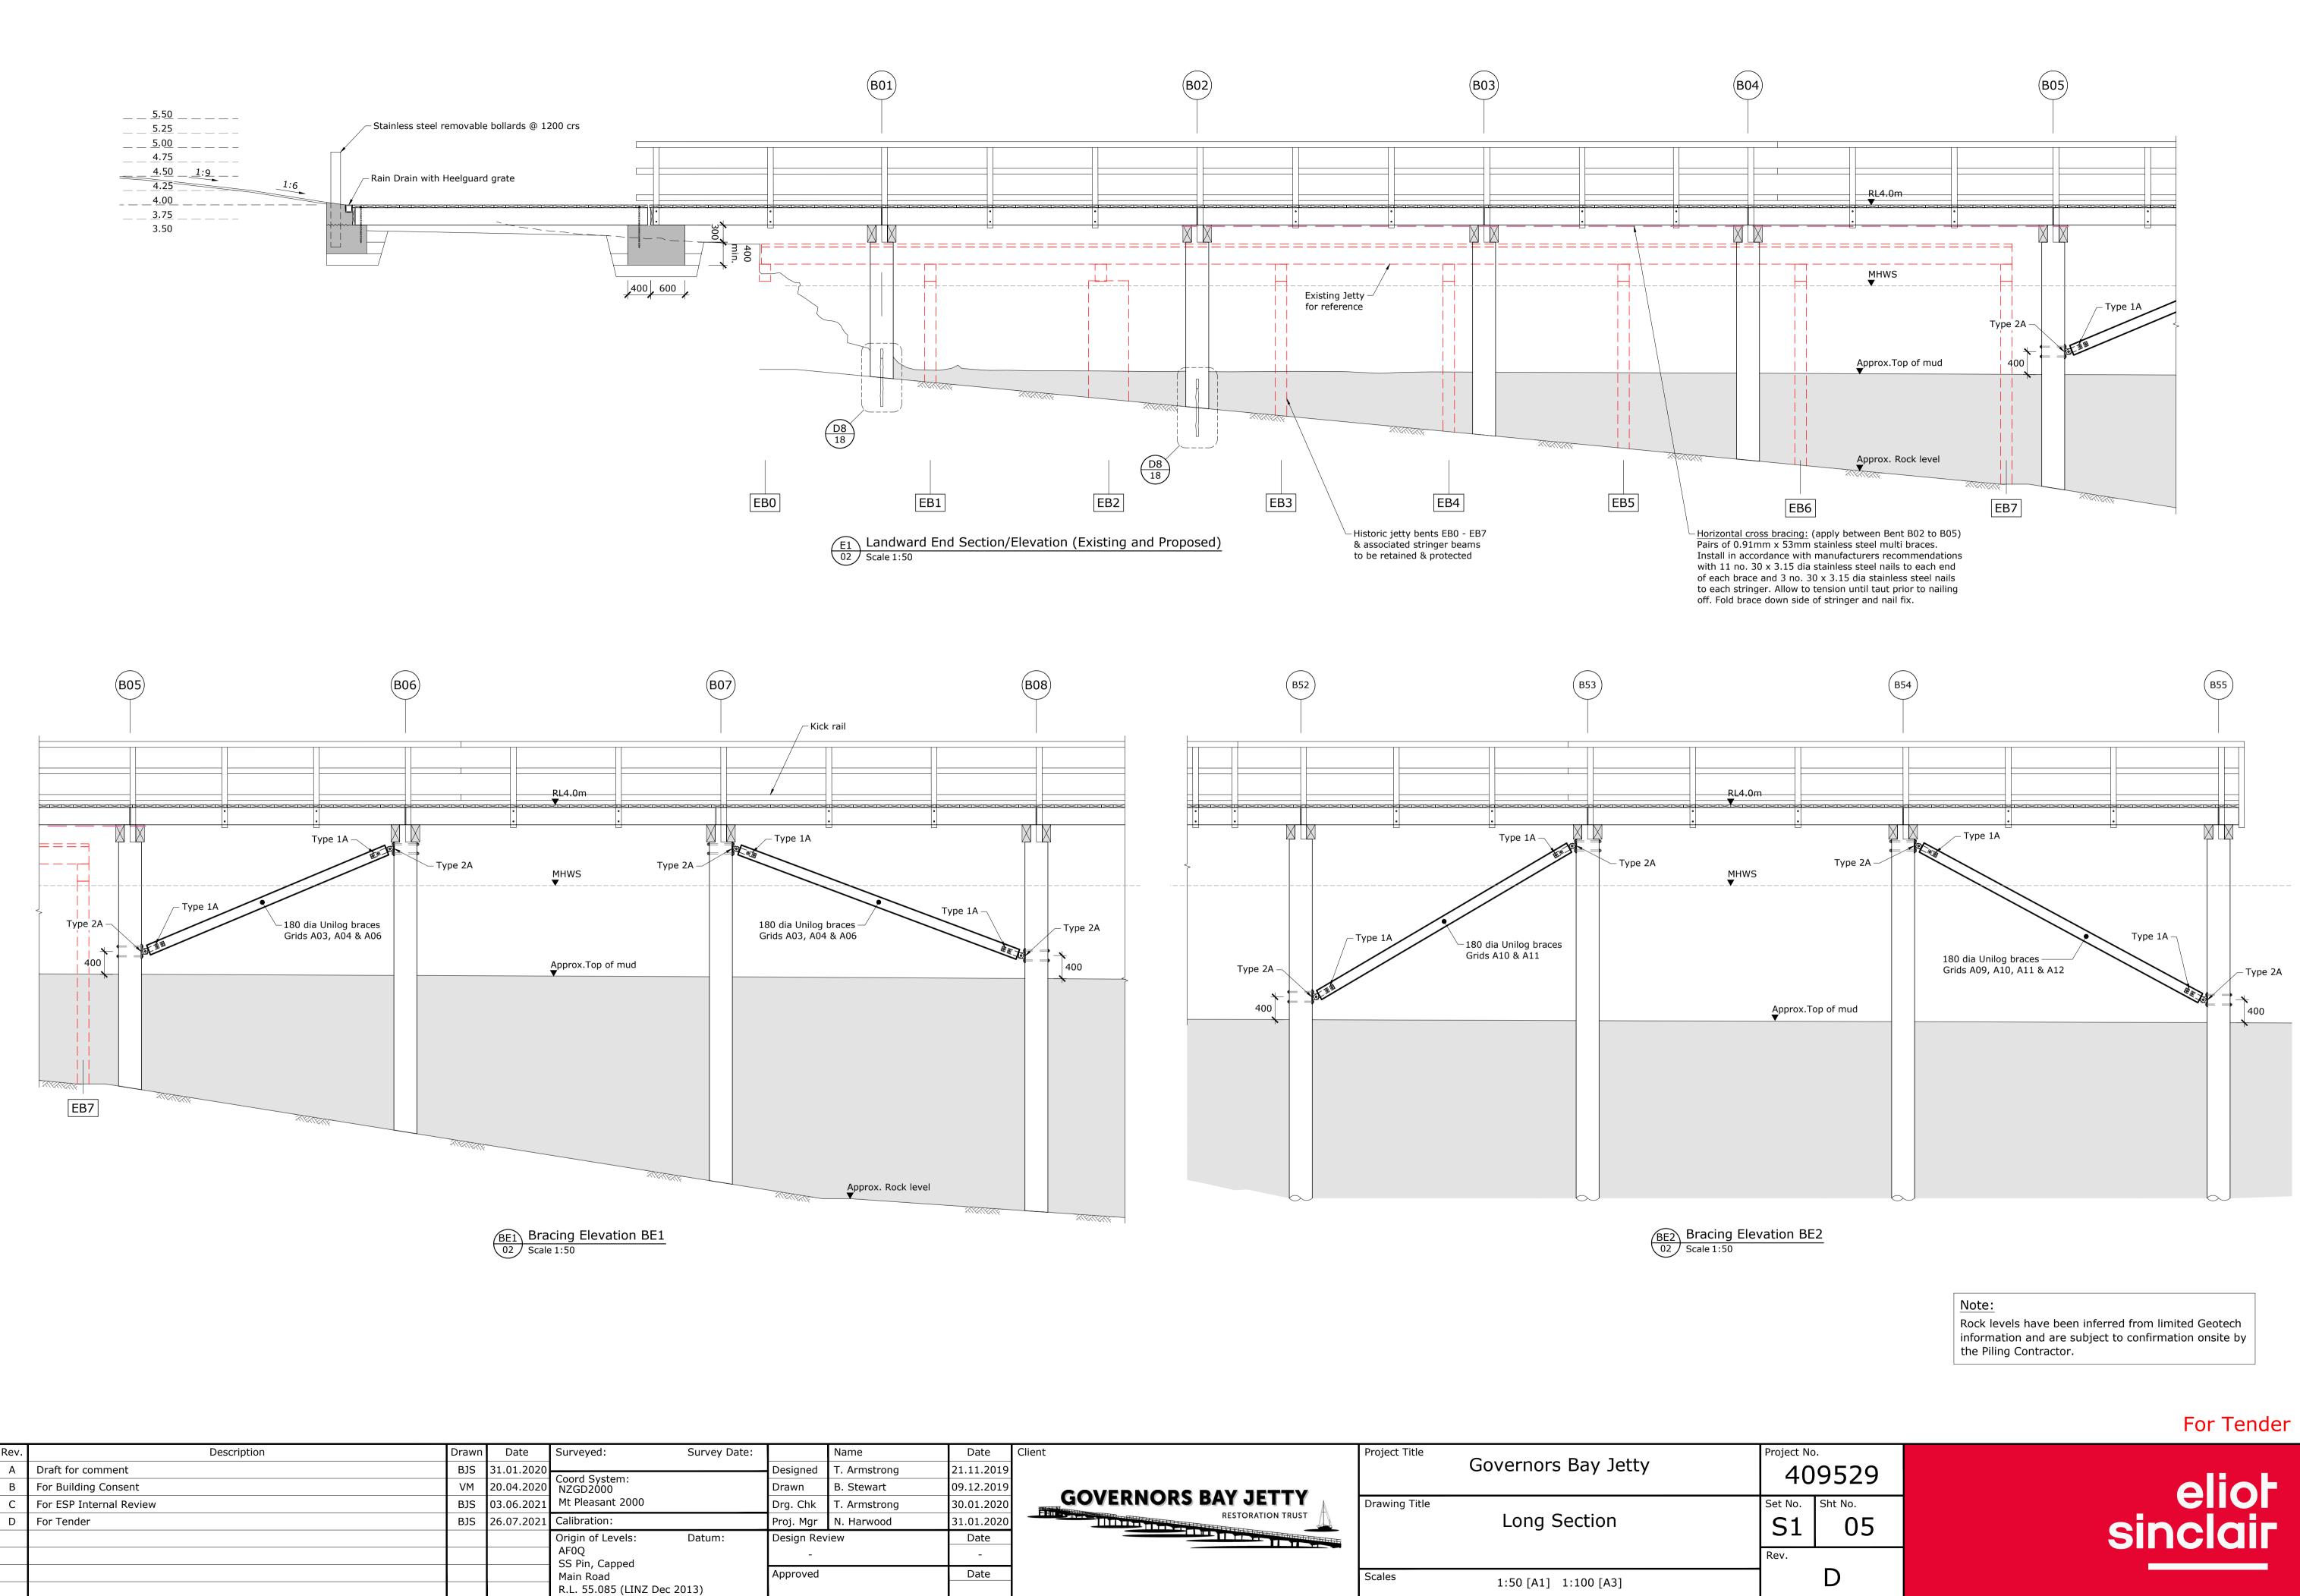


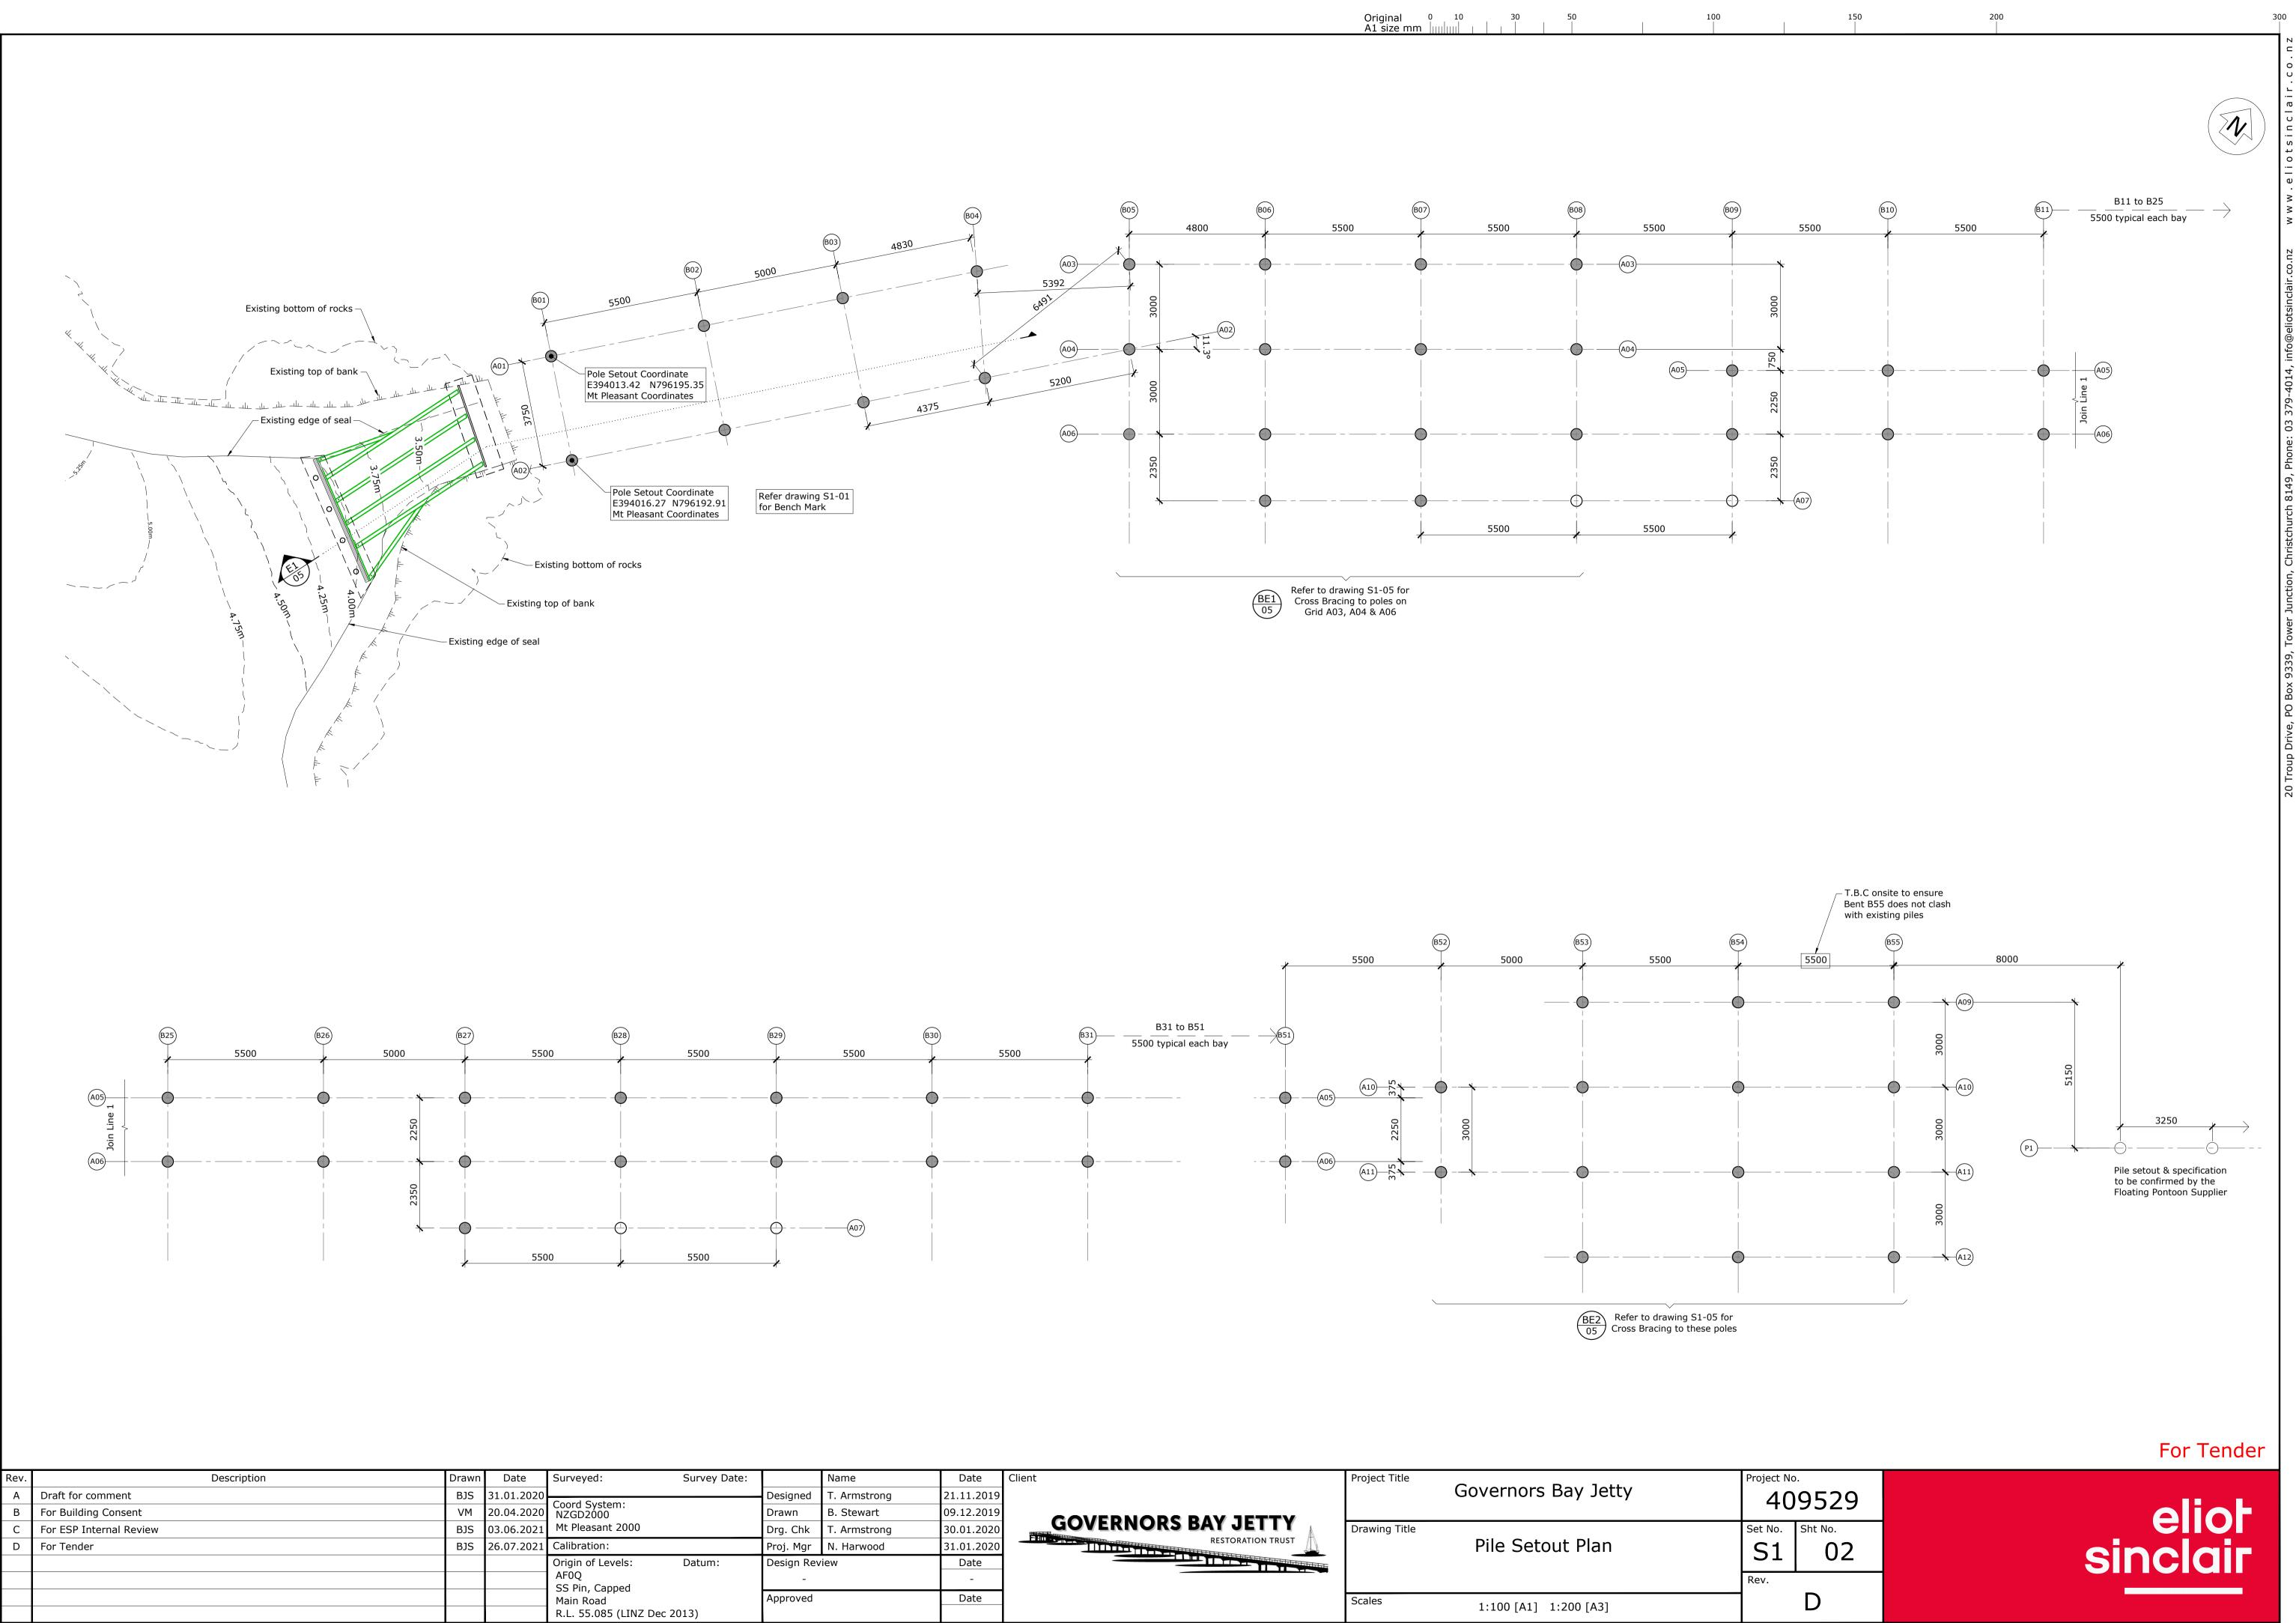

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mstrong	21.11.2019			Governors Bay Jetty	
ewart	09.12.2019	COVERNORS RAV JETTY			
mstrong	30.01.2020	GOVERNORS BAY JETTY	Drawing Title		
arwood	31.01.2020	RESTORATION TRUST		Pile Setout Plan	
	Date				
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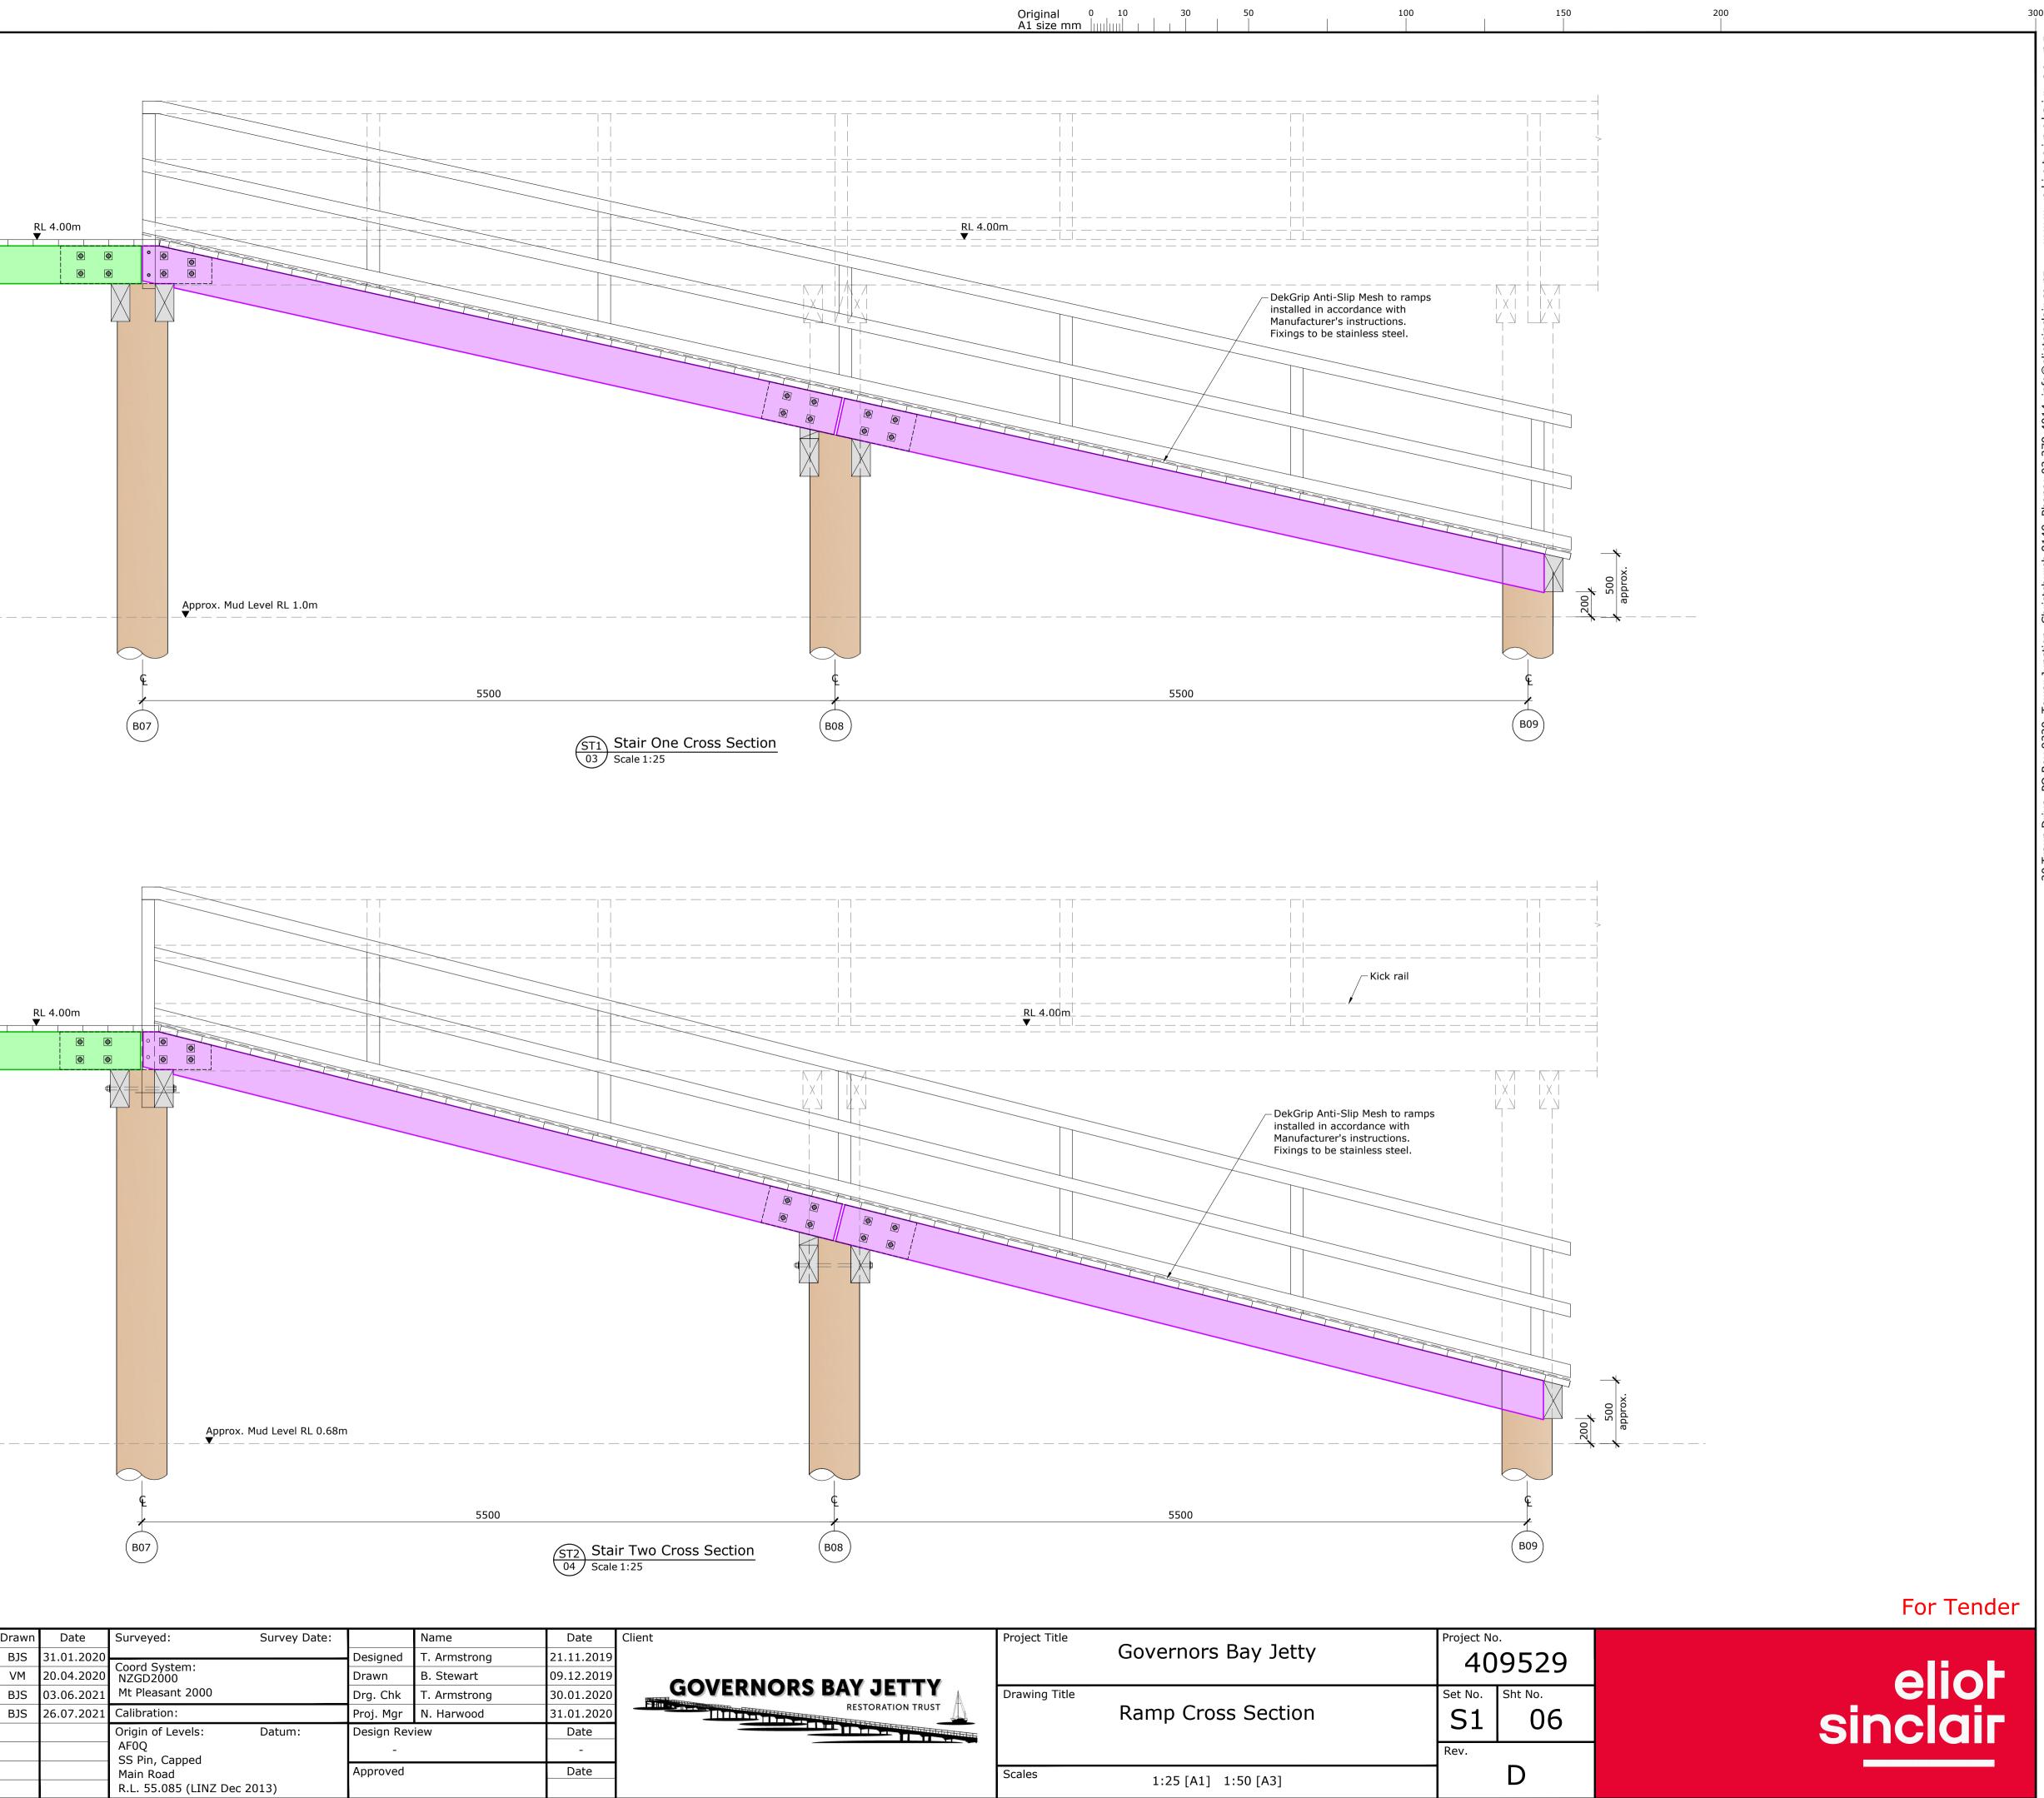





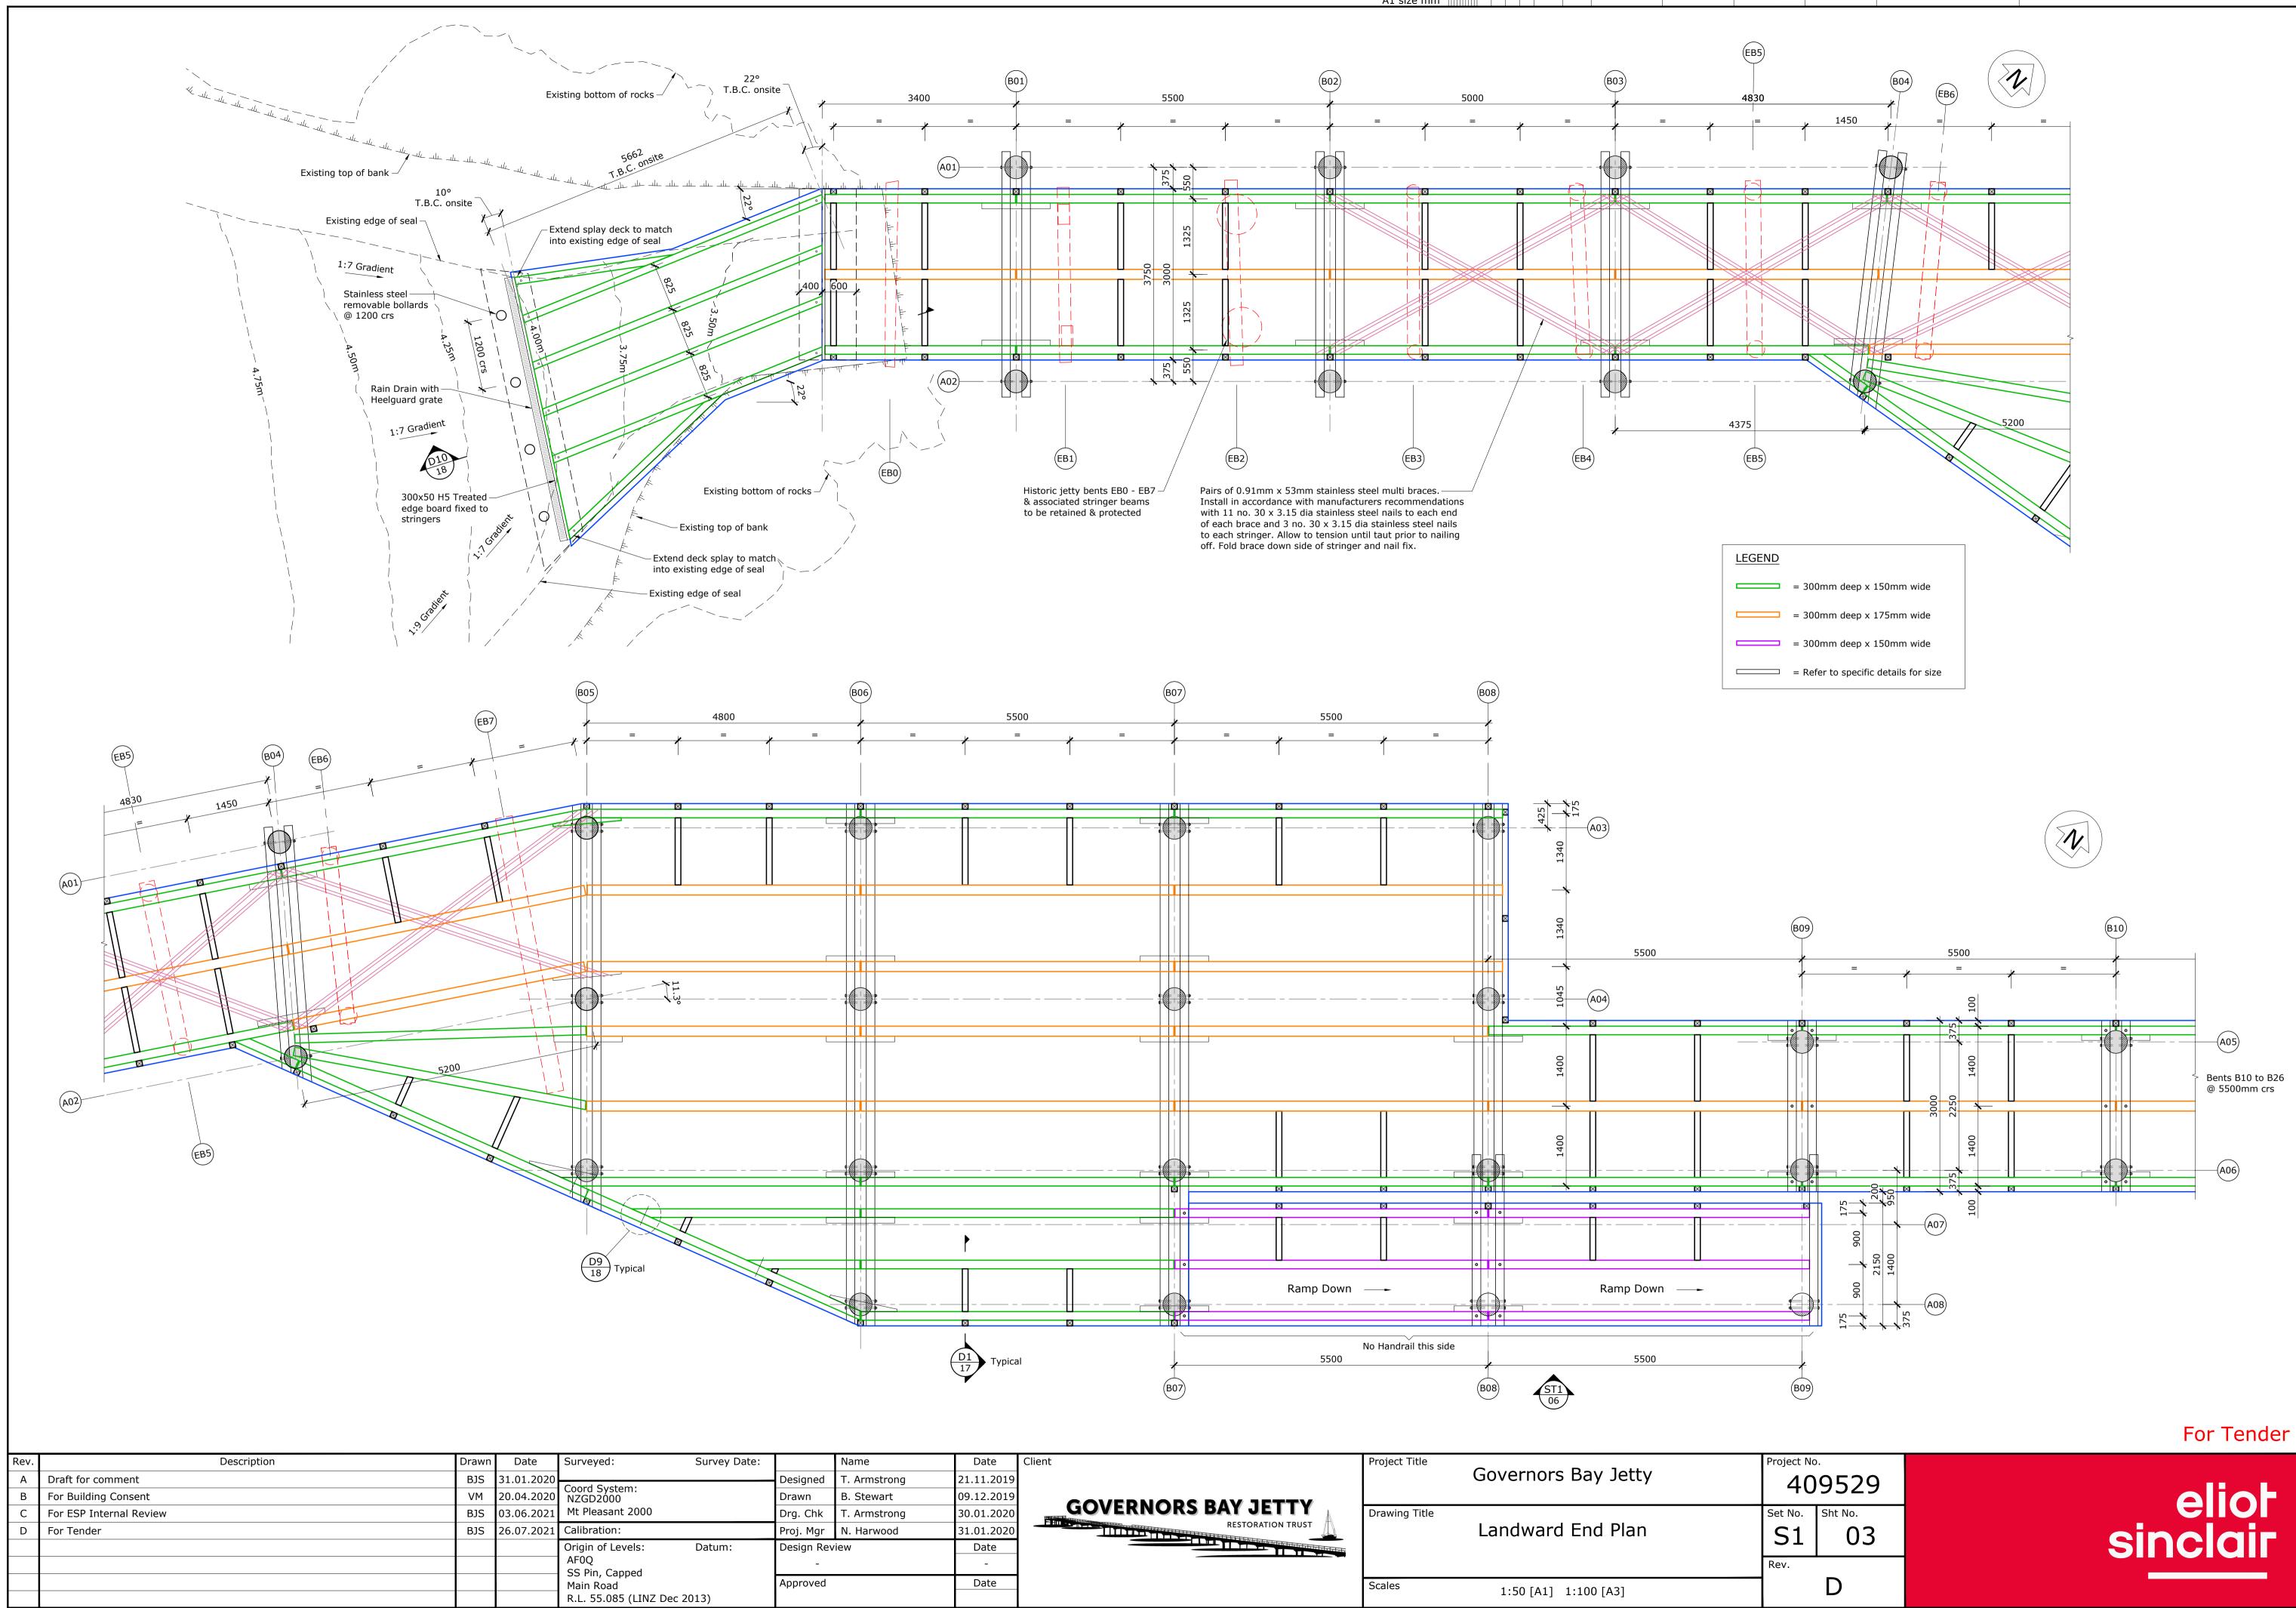

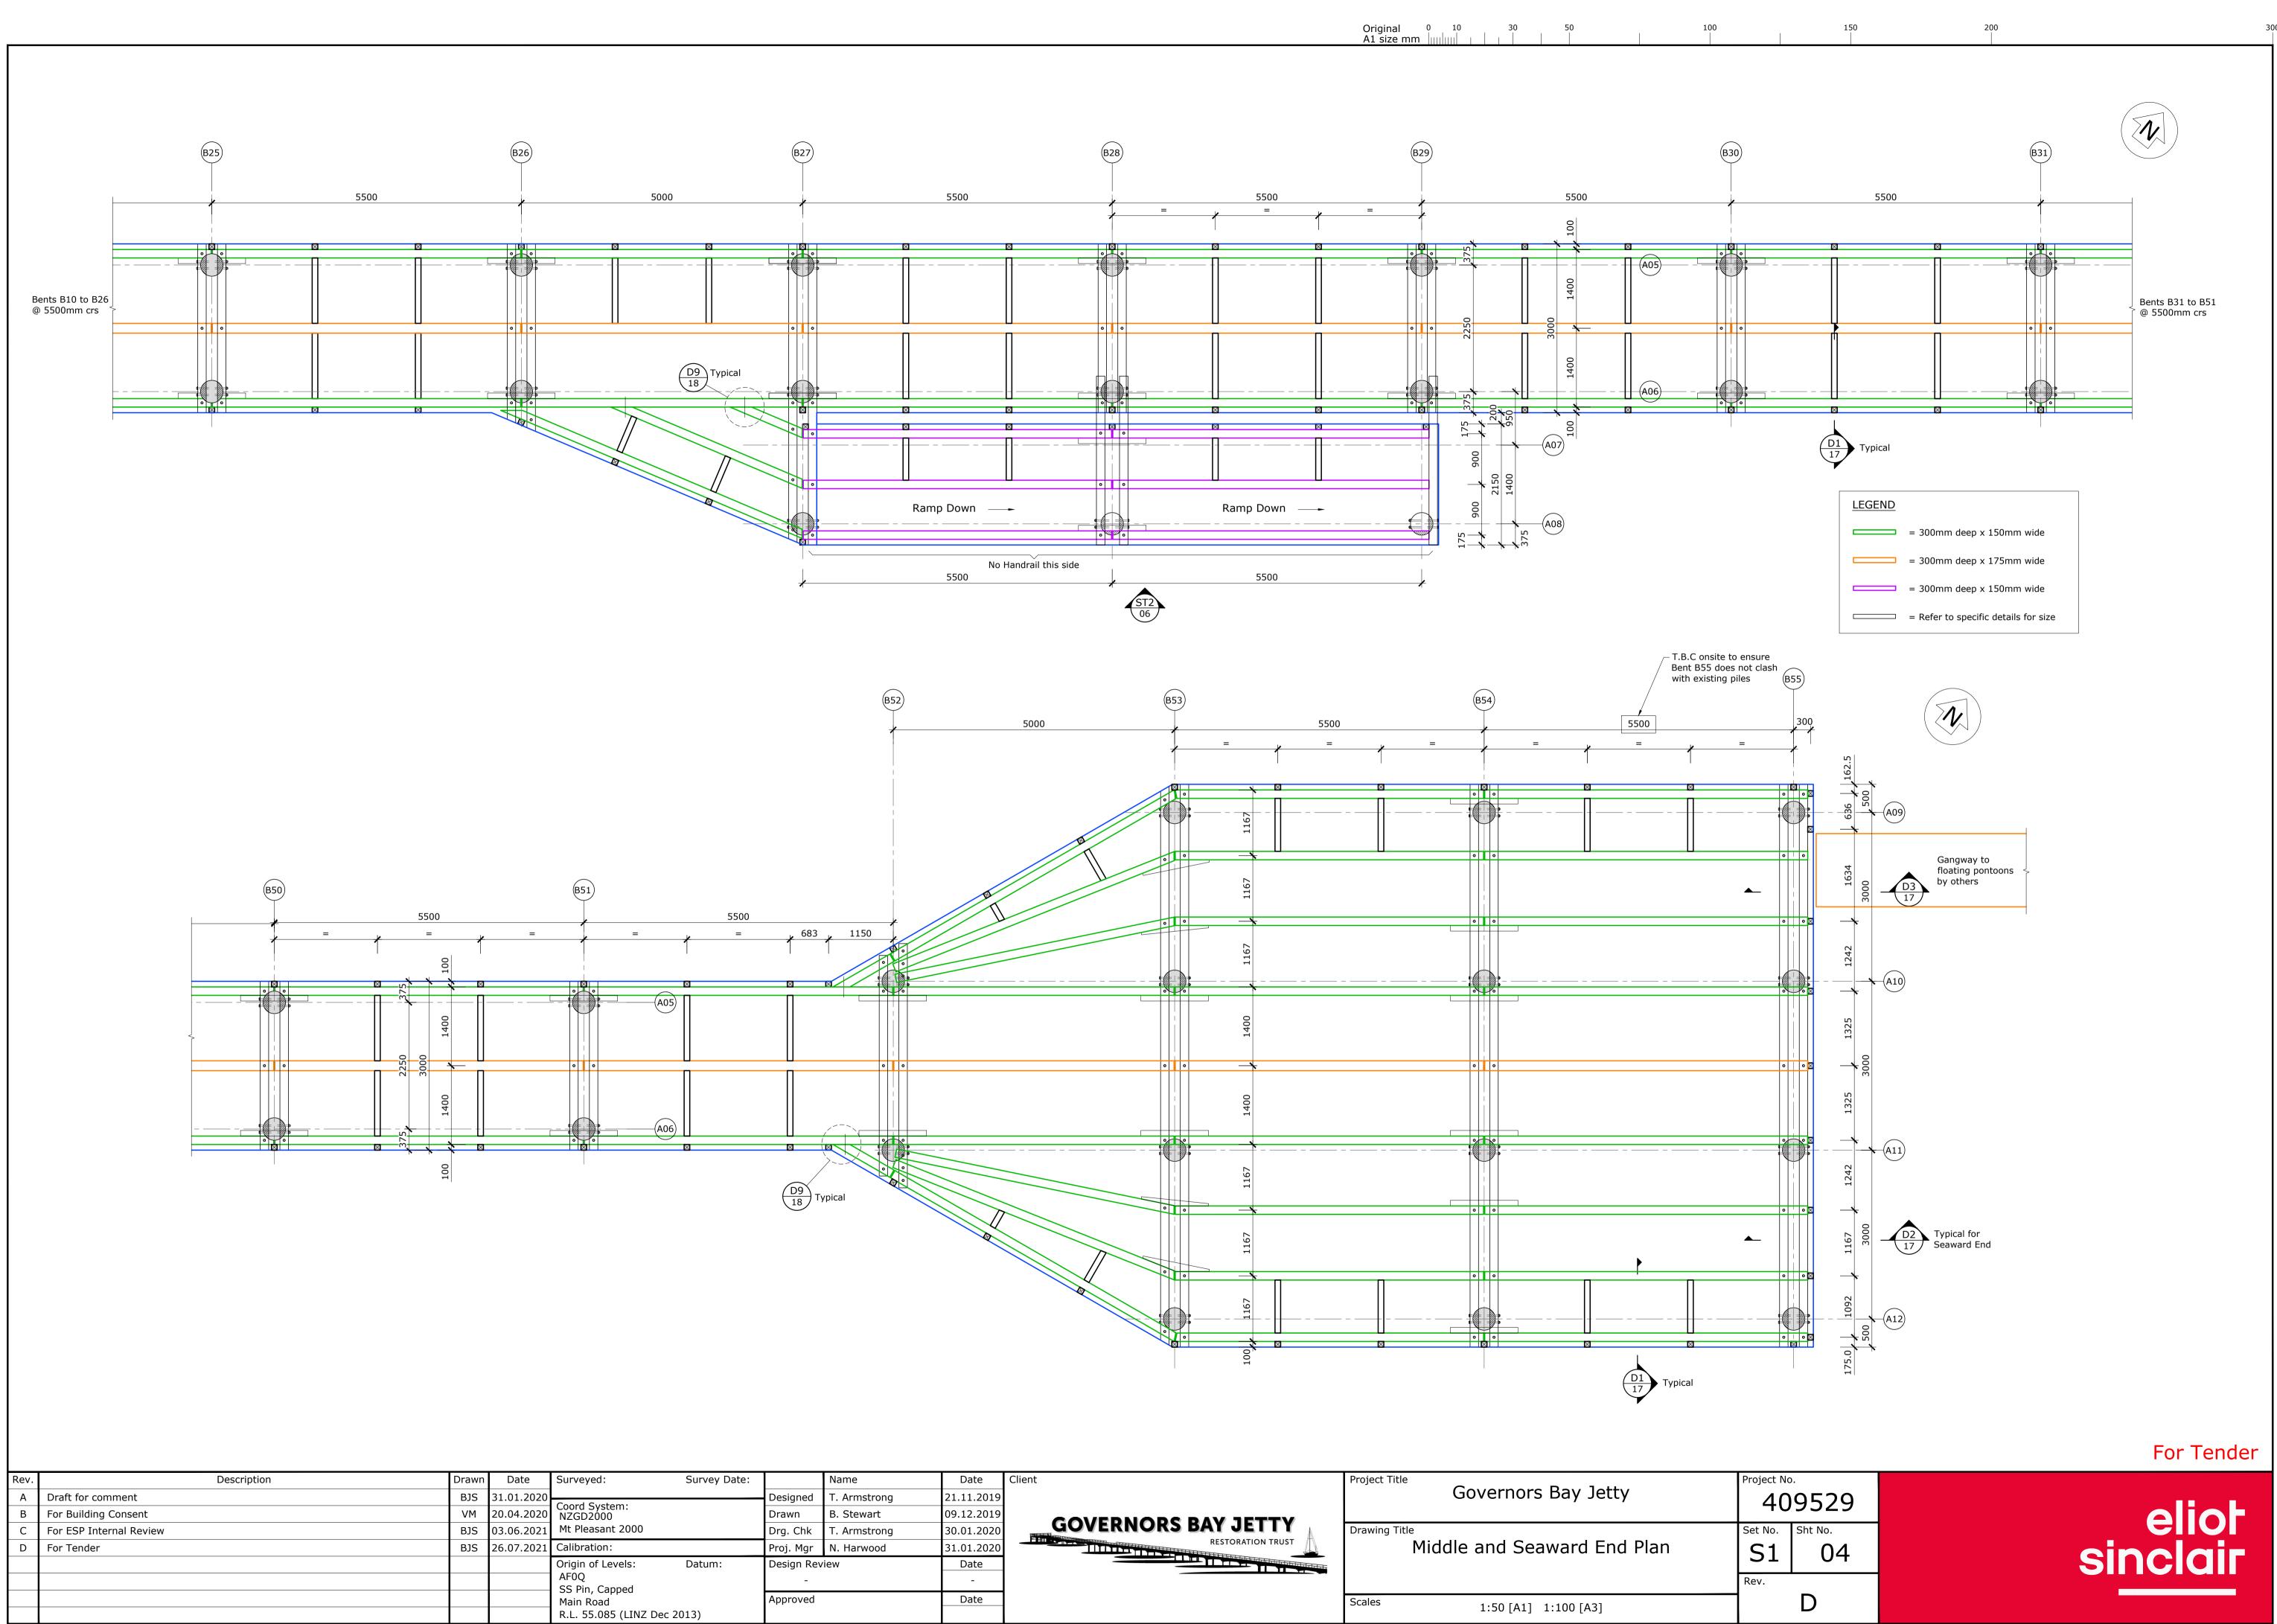
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nstrong	30.01.2020	GOVERNORS BAY JETTY	Drawing Title	S
rwood	31.01.2020	RESTORATION TRUST	Long Section	
	Date			
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	Date		Scales 1:50 [A1] 1:100 [A3]	
			1.50 [A1] 1.100 [A5]	





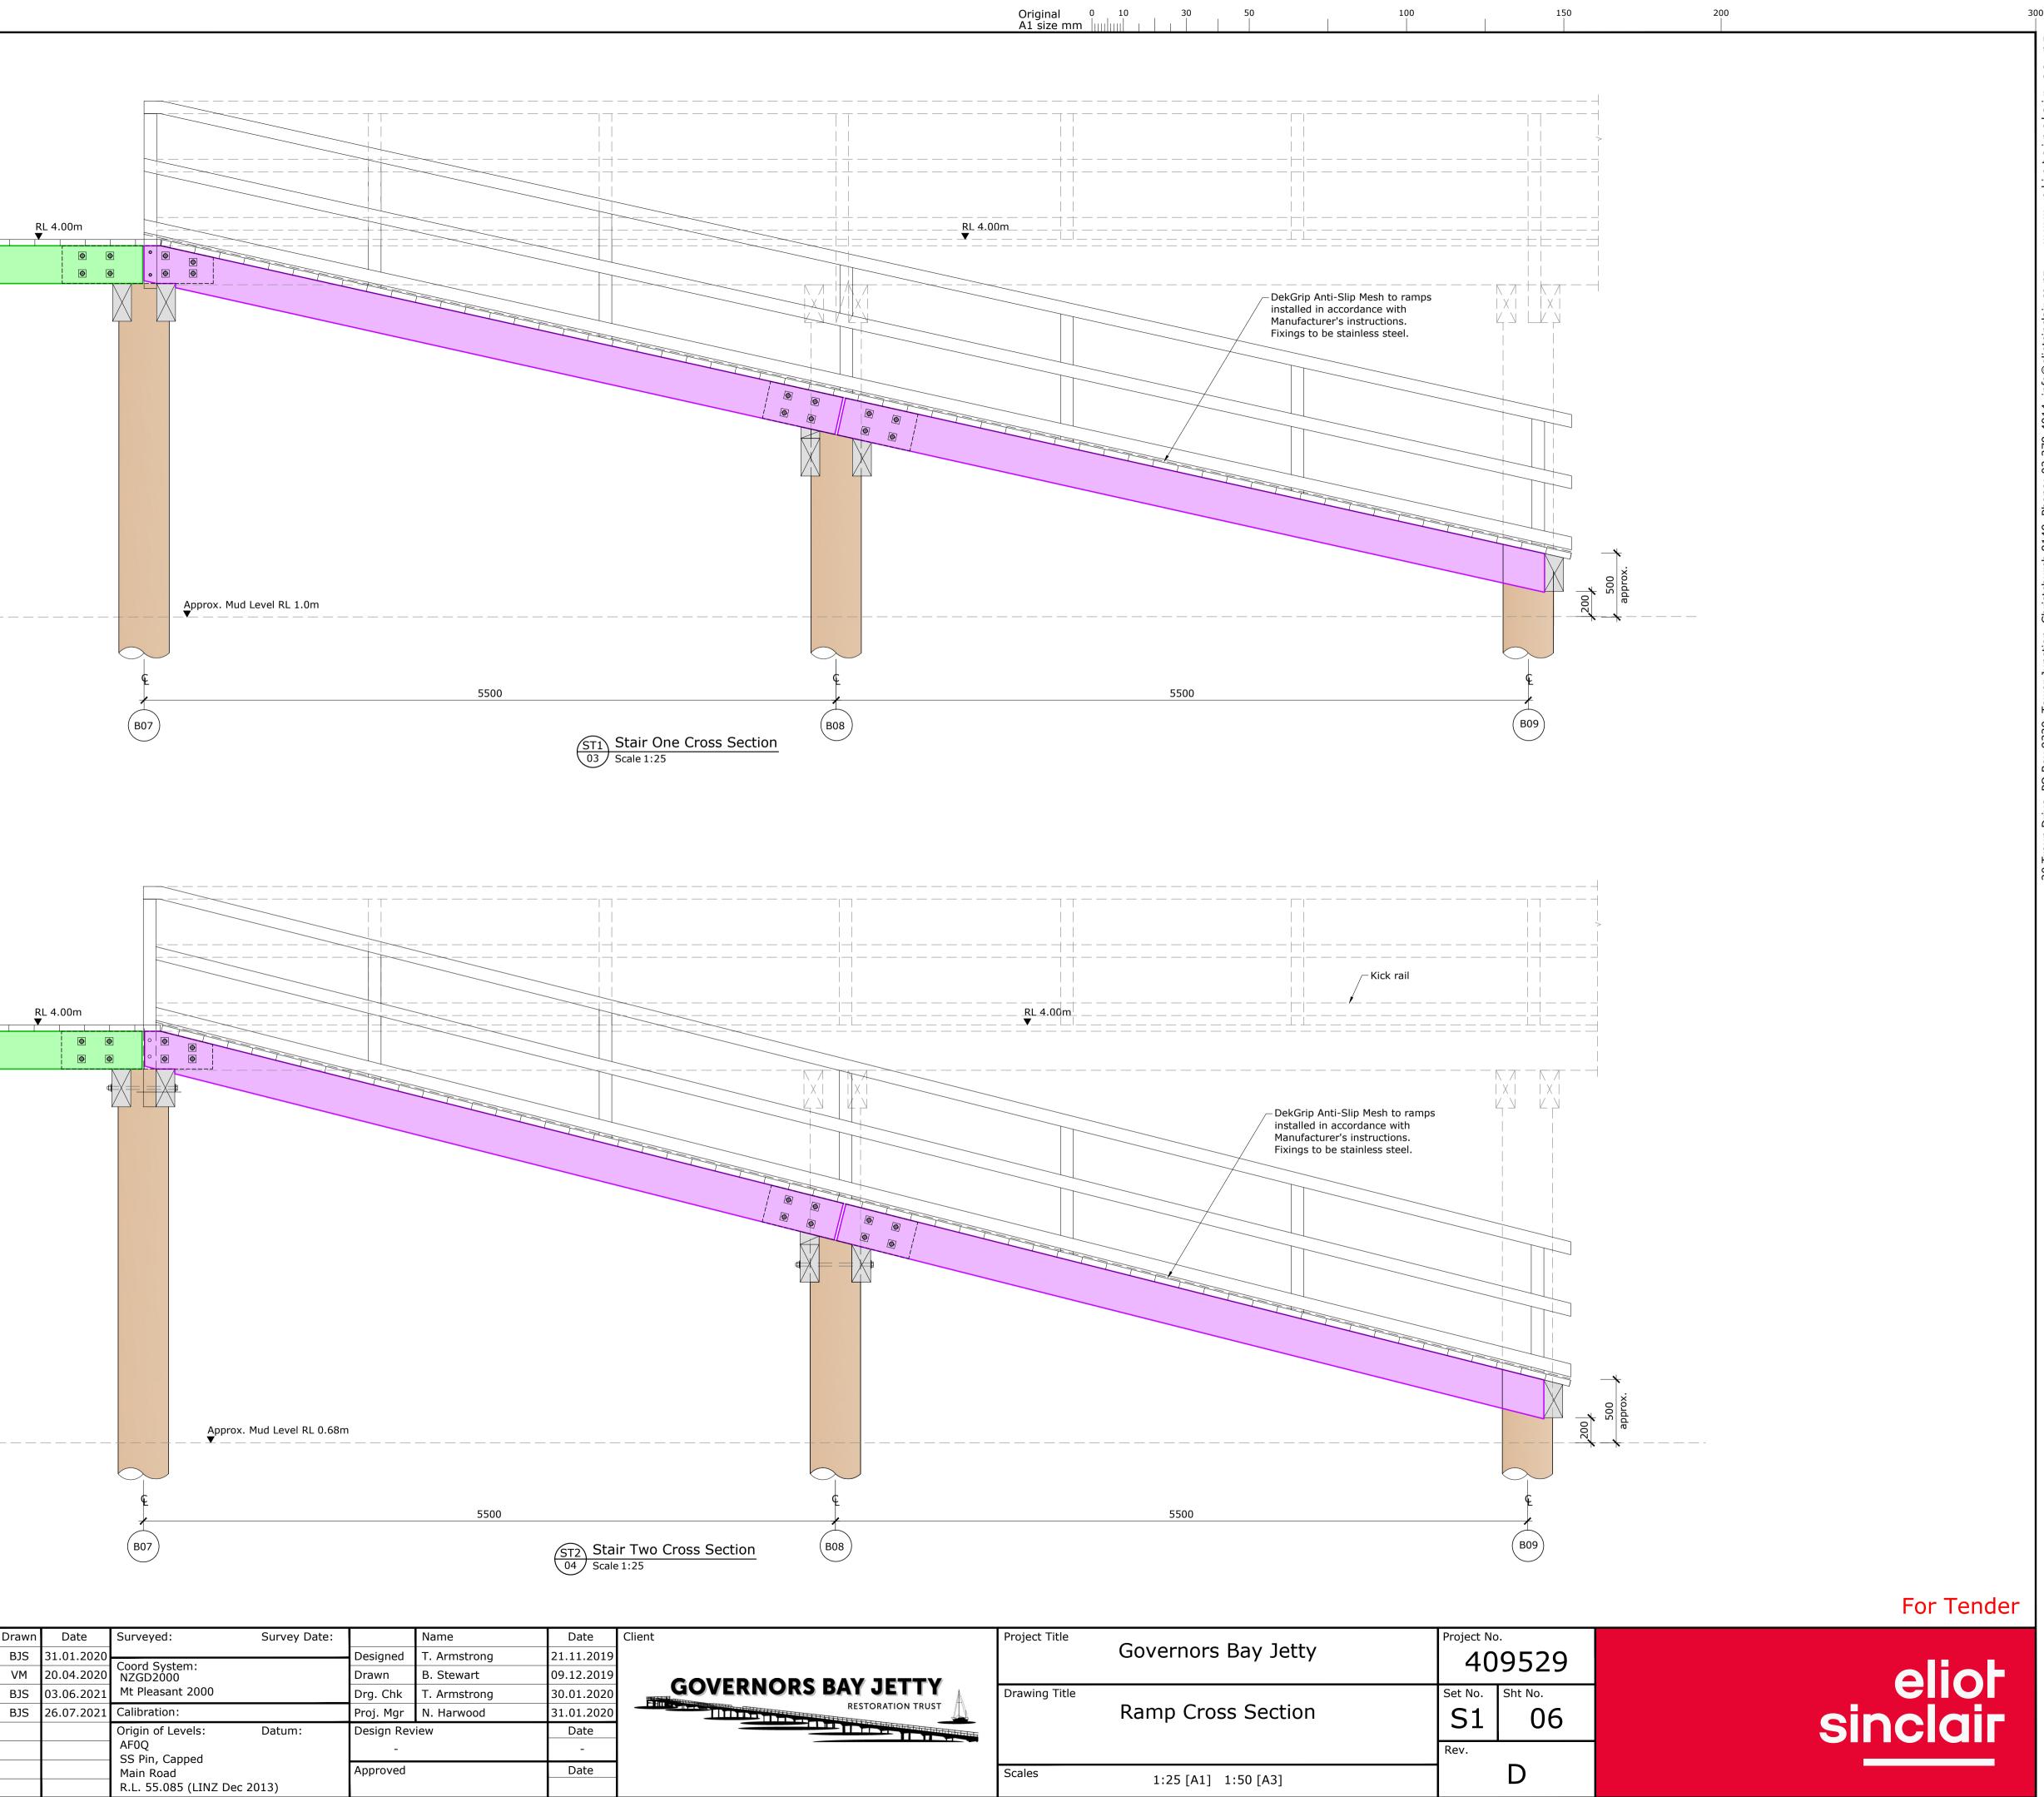

Rev.	Description	Drawn	Date	Surveyed:	Survey Date:		Name
А	Draft for comment	BJS	31.01.2020			Designed	T. Arm
В	For Building Consent	VM	20.04.2020	Coord System: NZGD2000		Drawn	B. Stev
С	For ESP Internal Review	BJS	03.06.2021	Mt Pleasant 2000	Drg. Chk	T. Arm	
D	For Tender	BJS	26.07.2021	Calibration:		Proj. Mgr	N. Har
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					c 2013)	Approved	

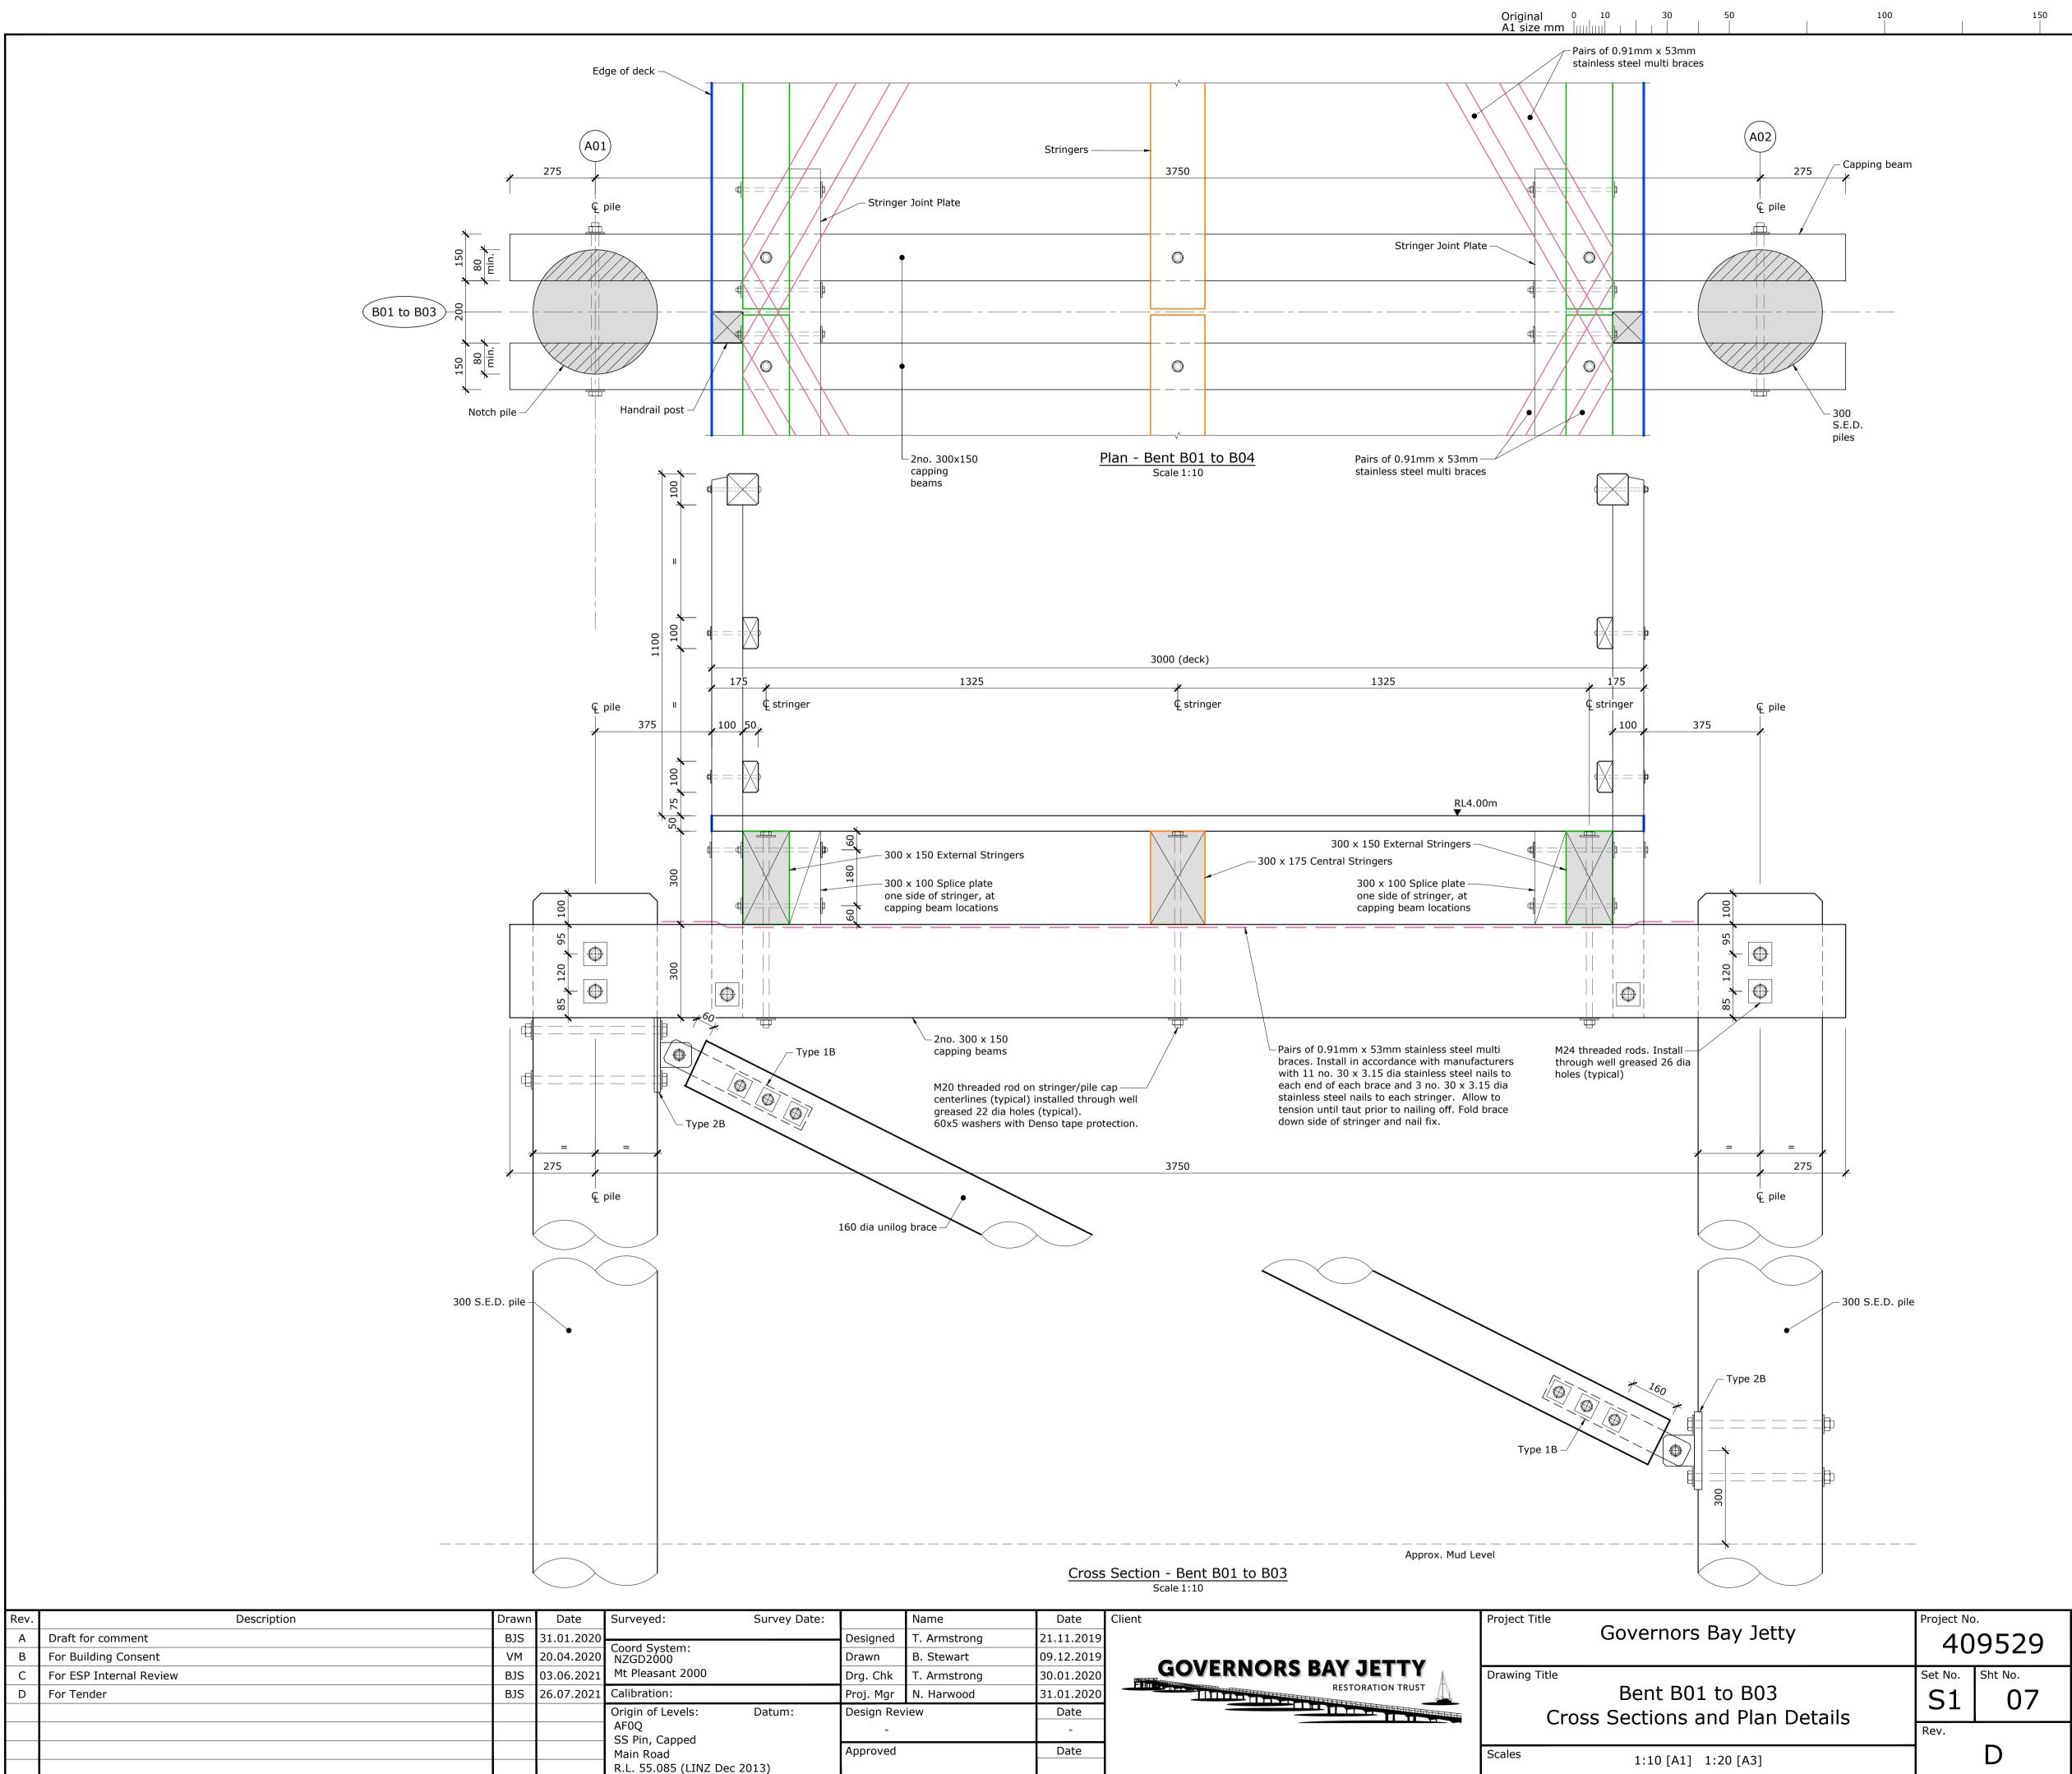


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For Tender

Reference Drawings: Refer to drawings S1-01 & S1-03 for Bent Locations.
 Refer to drawings S1-16 to S1-18 for Typical Construction Details.



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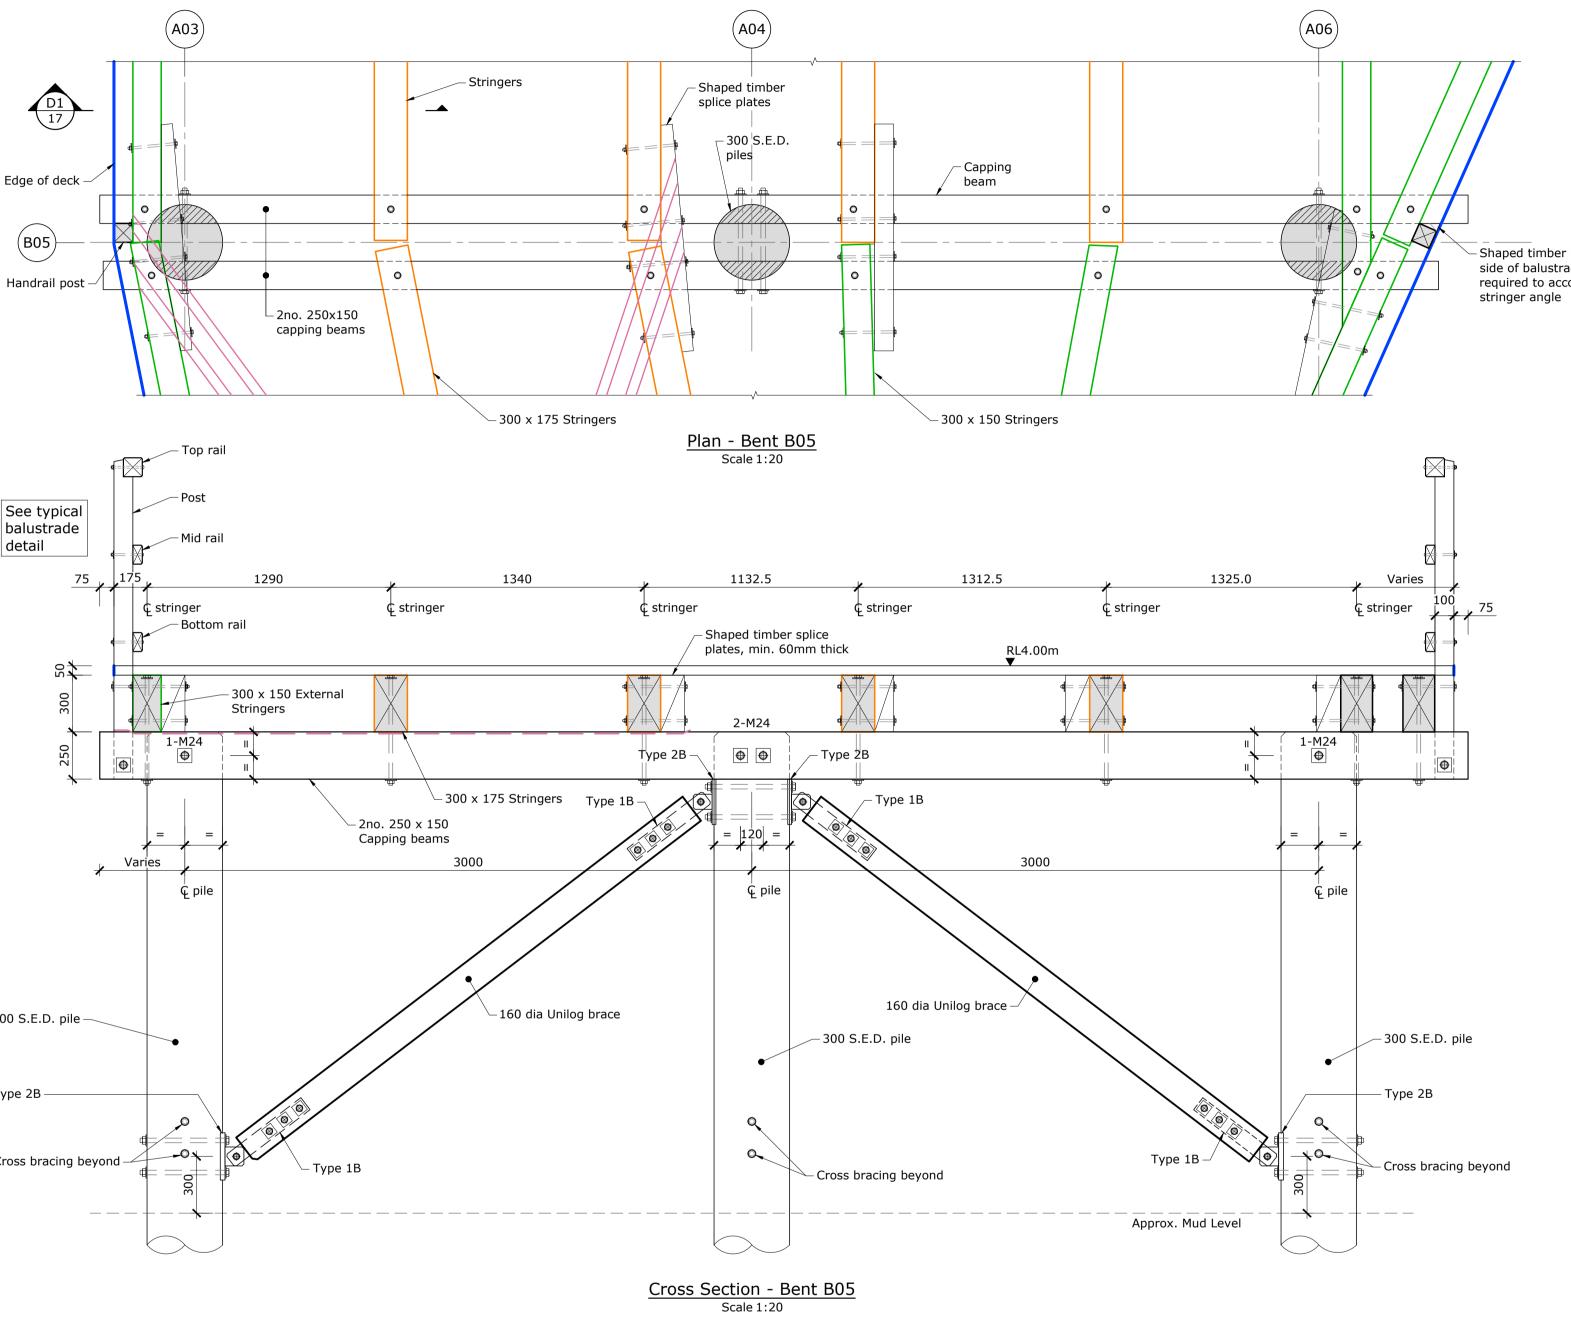


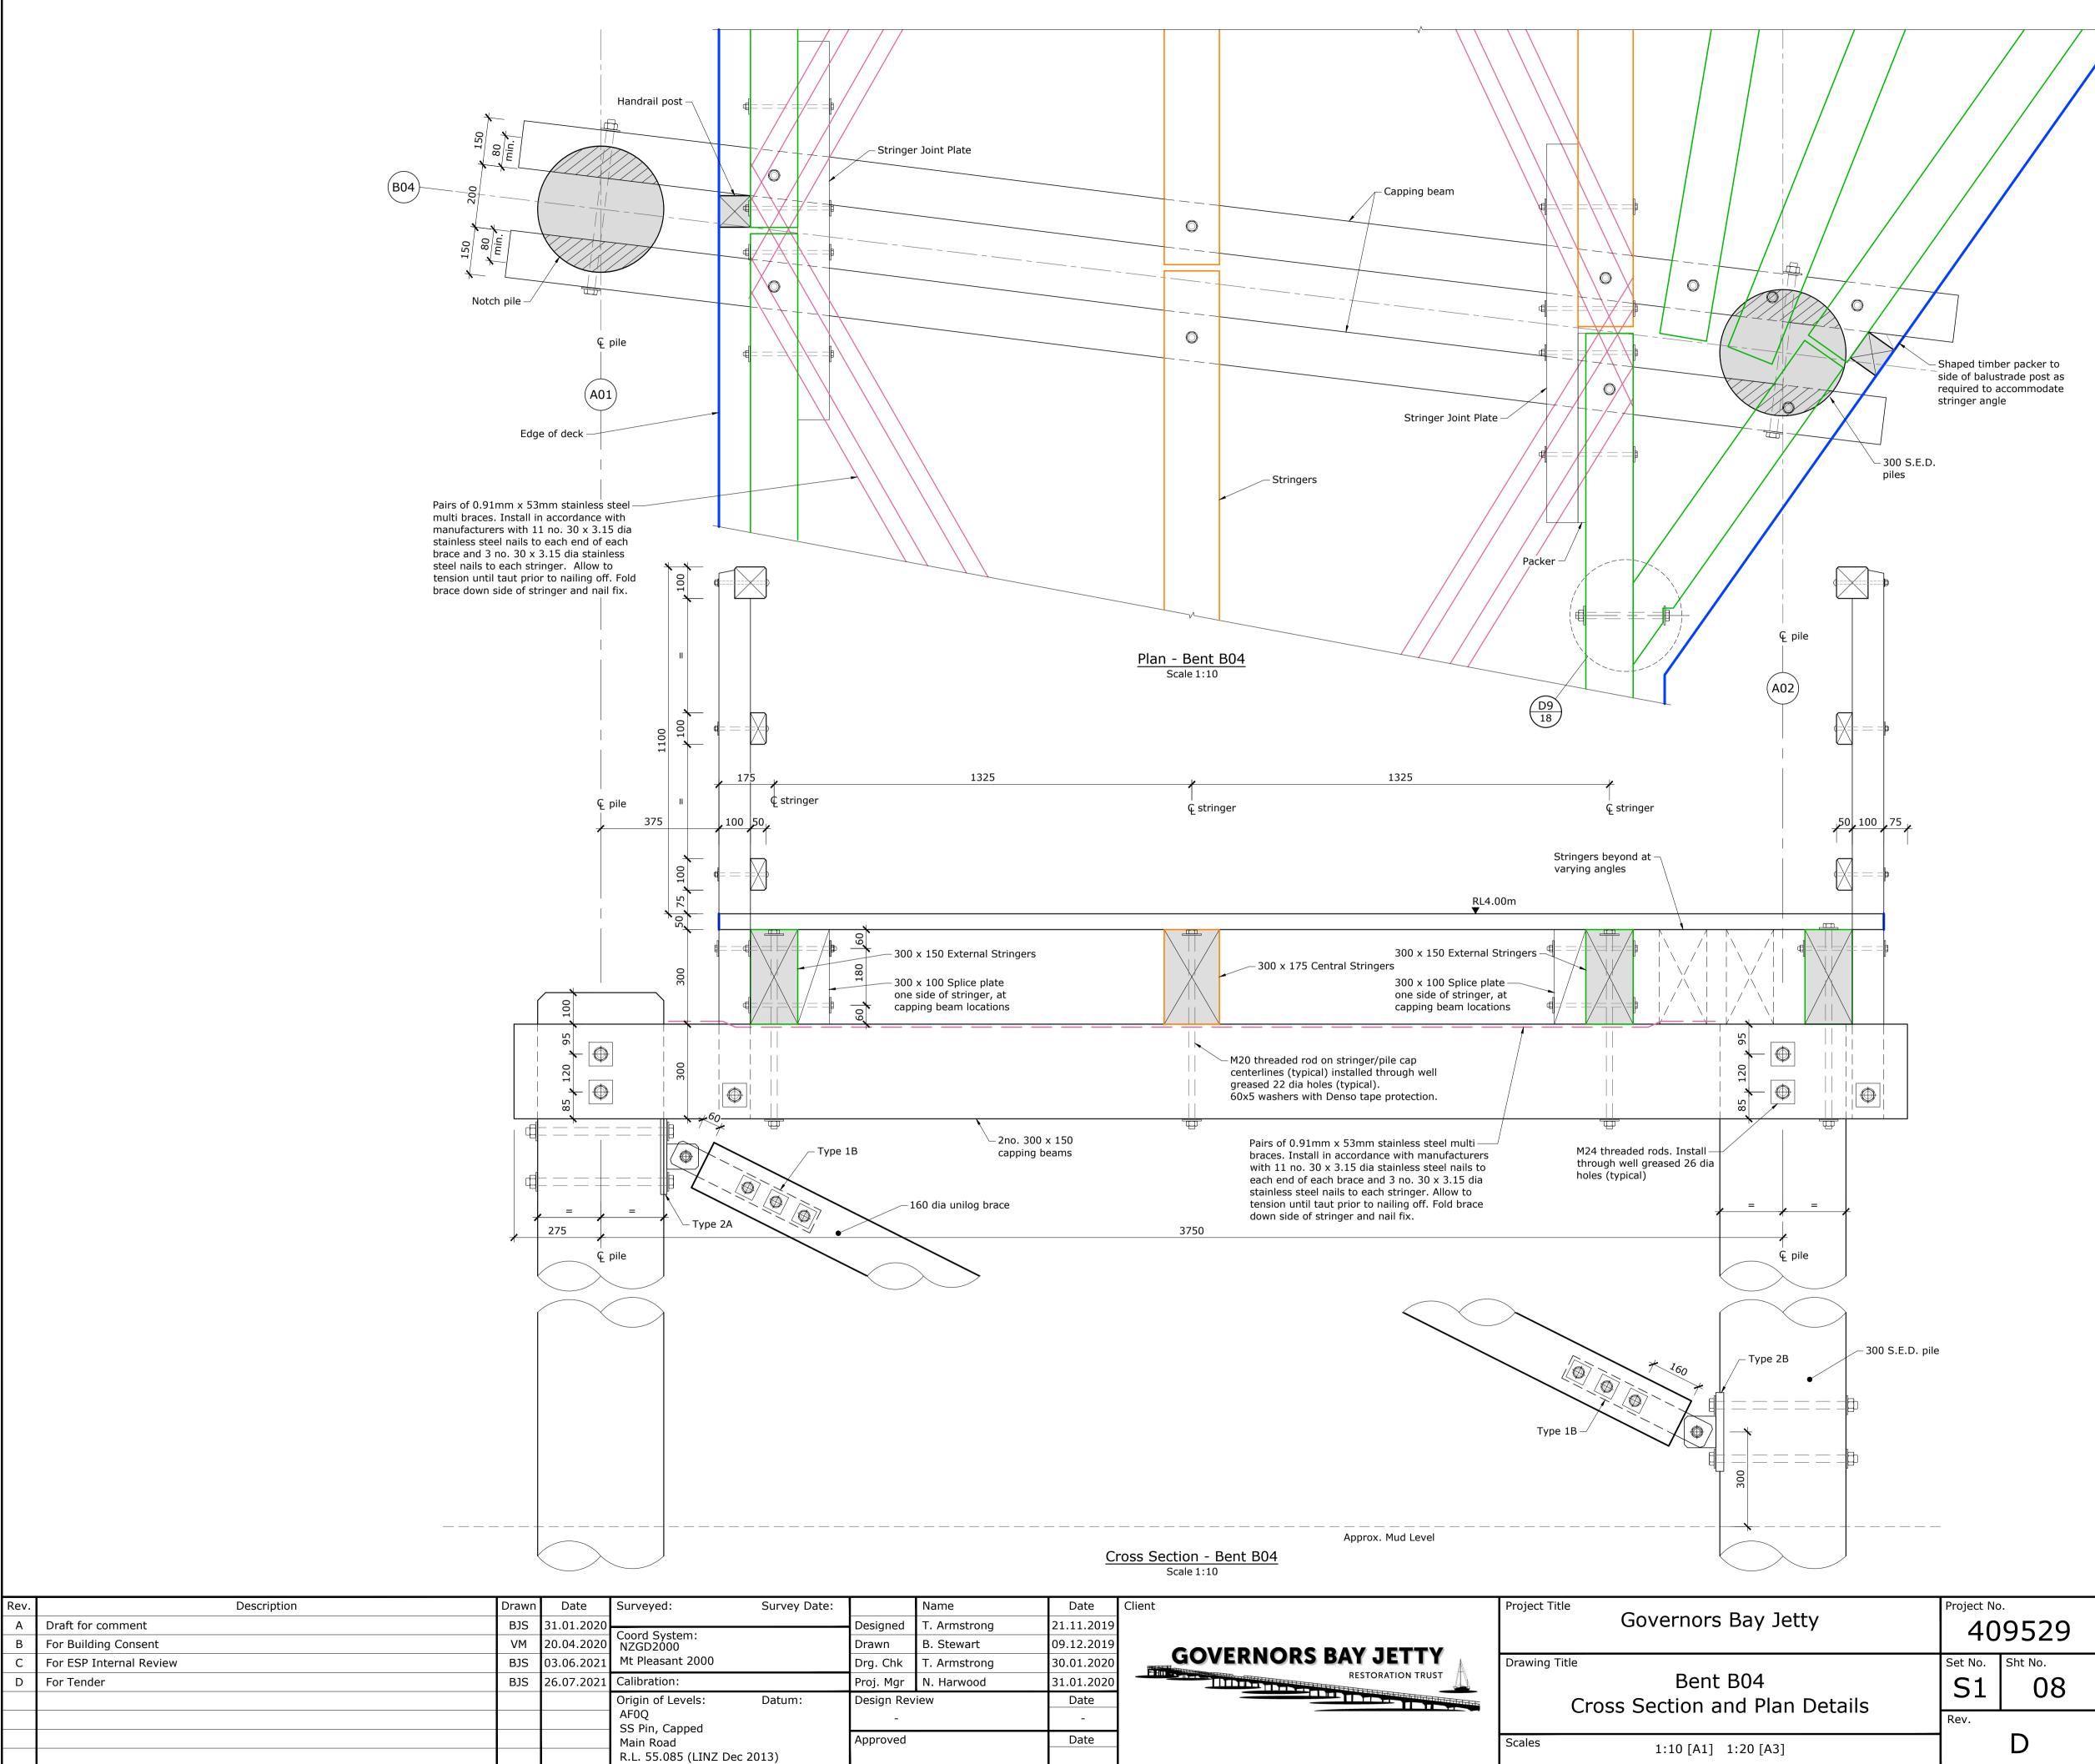
Refer to drawings S1-01 & S1-03 for Bent Locations.
 Refer to drawings S1-16 to S1-18 for Typical Construction Details.

For Tender


Reference Drawings:

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Rev.	Description	Drawn	Date	Surveyed:	Survey Date:		Name
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С	For ESP Internal Review	BJS	03.06.202	Mt Pleasant 2000	Drg. Chk	T. Arm	
D	For Tender	BJS	26.07.202	1 Calibration:	Calibration:		
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				Main Road R.L. 55.085 (LINZ Dec	c 2013)	Approved	

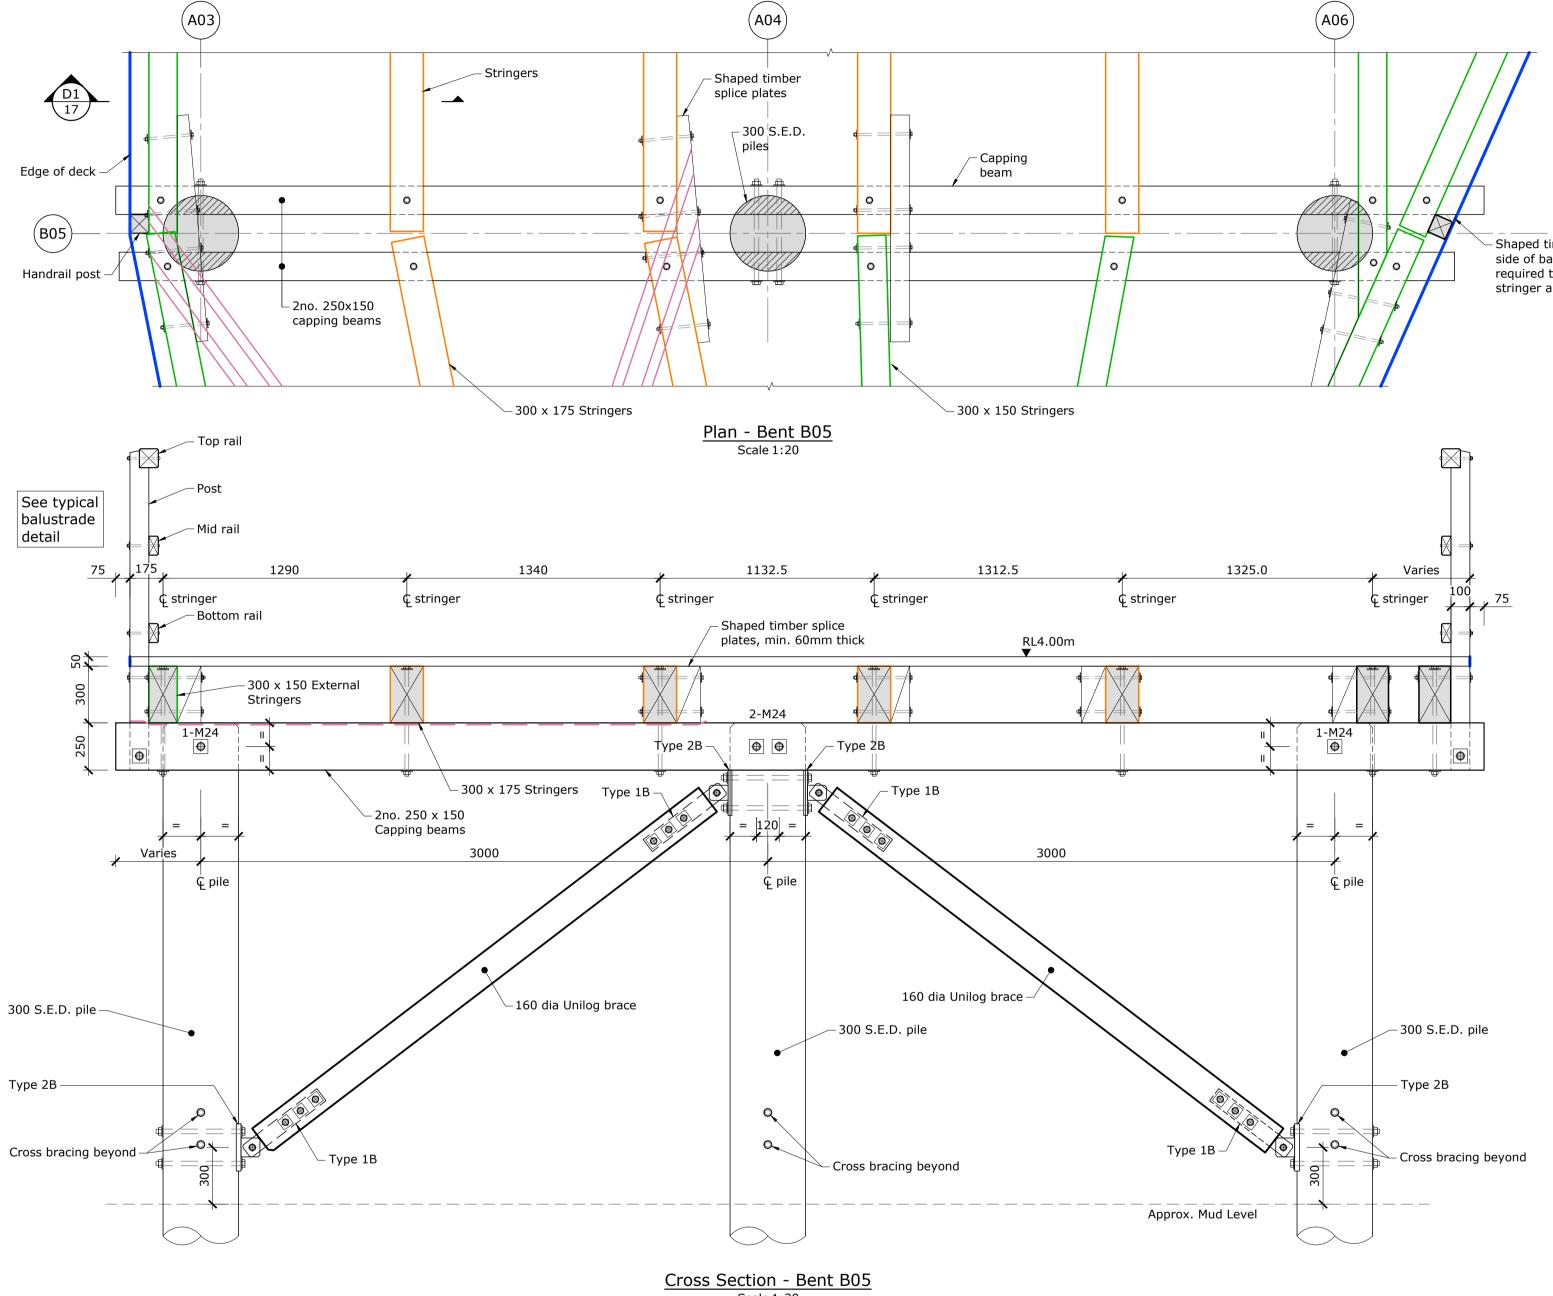


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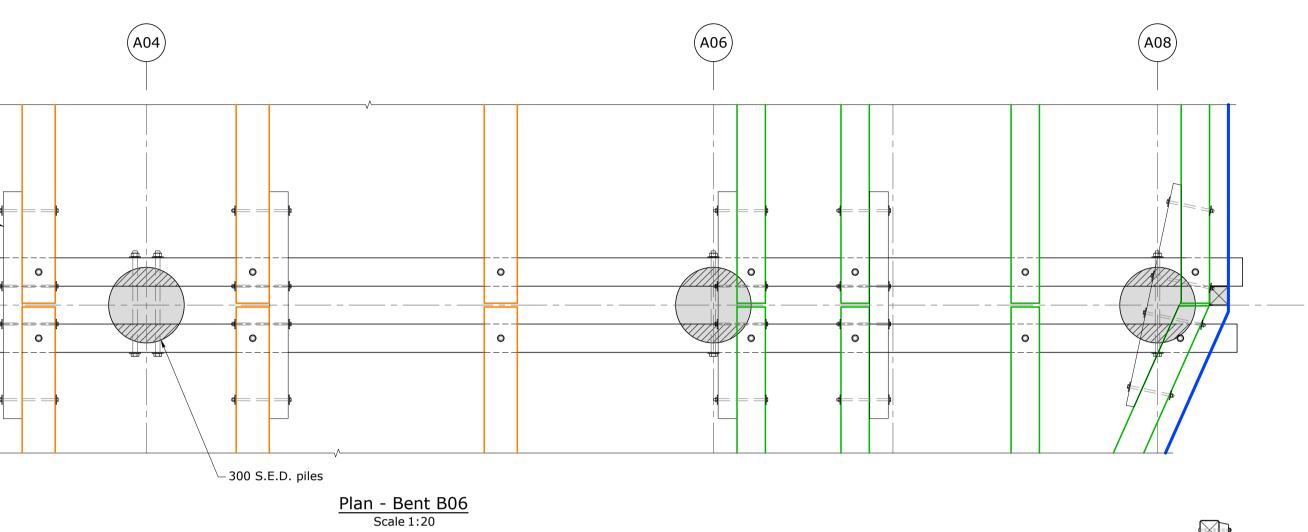
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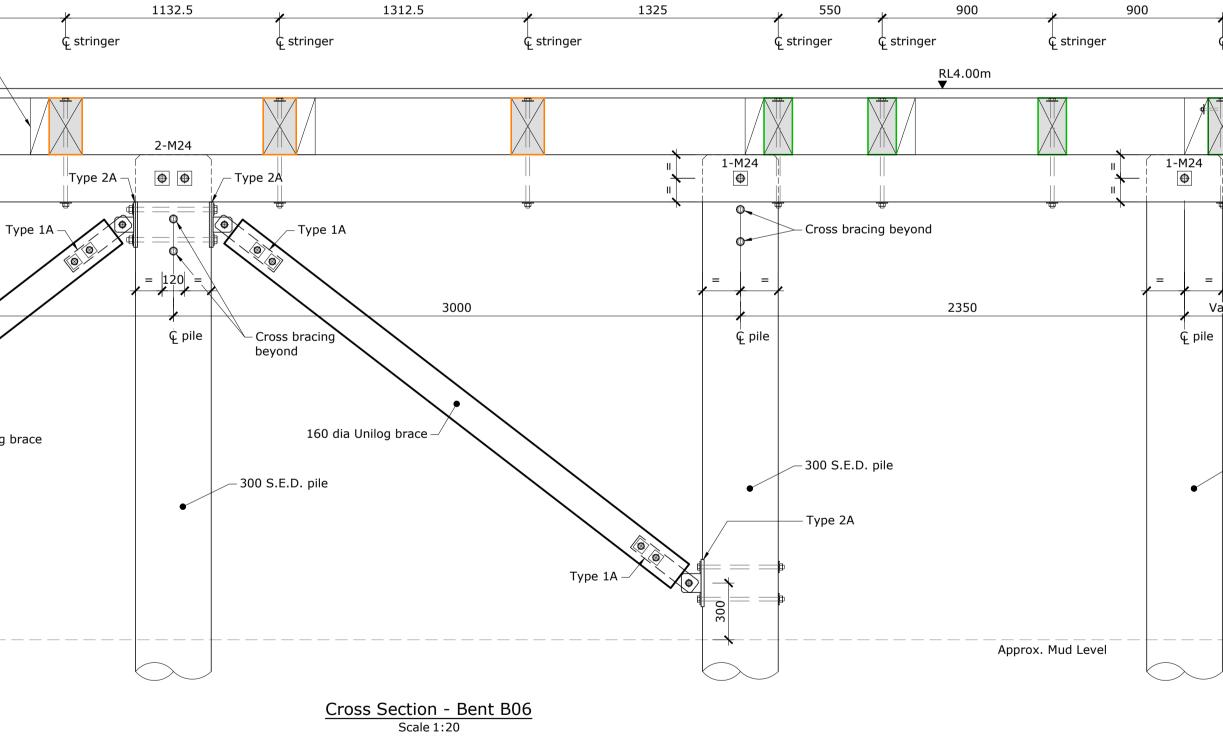
Reference Drawings: Refer to drawings S1-01 & S1-03 for Bent Locations.
 Refer to drawings S1-16 to S1-18 for Typical Construction Details.

 Shaped timber packer to side of balustrade post as required to accommodate 150

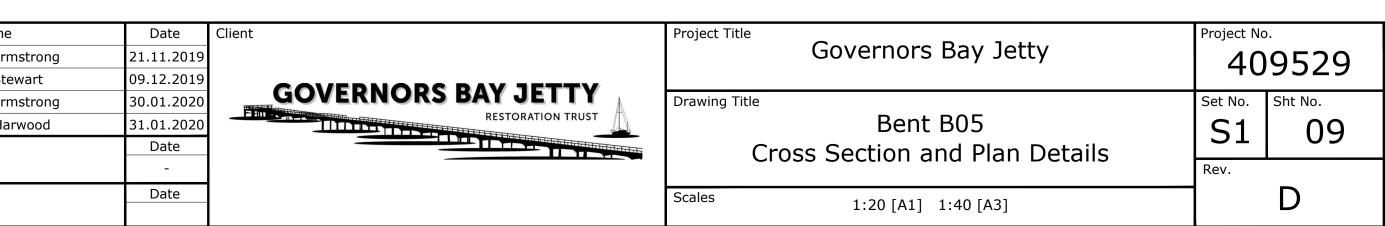

Rev.	Description	Drawn	Date	Surveyed:	Survey Date:		Name
А	Draft for comment	BJS	31.01.2020	Canad Cristians		Designed	T. Arm
В	For Building Consent	VM	20.04.2020	Coord System: NZGD2000		Drawn	B. Ste
С	For ESP Internal Review BJS 03.06.2021 Mt Pleasant 2000				Drg. Chk	T. Arm	
D	For Tender	BJS	26.07.2021	Calibration:		Proj. Mgr	N. Har
				Origin of Levels: AF0Q SS Pin, Capped Main Road R.L. 55.085 (LINZ Dec	Datum: 2013)	Design Rev - Approved	/iew



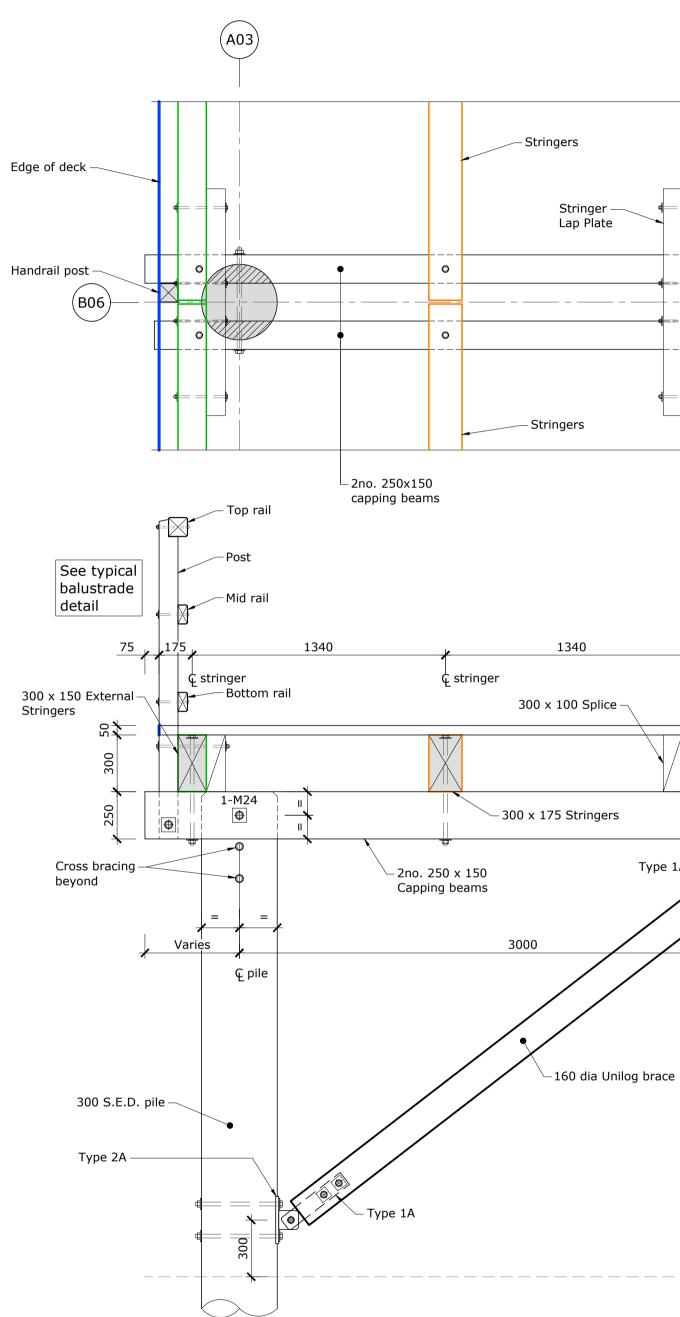

2	Date	Client	Project Title	F
mstrong	21.11.2019		Governors Bay Jetty	
ewart	09.12.2019			
mstrong	30.01.2020	GOVERNORS BAY JETTY	Drawing Title	5
irwood	31.01.2020	RESTORATION TRUST	Bent B06	
	Date		Cross Section and Plan Details	L
	-			
	Date		Scales 1:20 [A1] 1:40 [A3]	1

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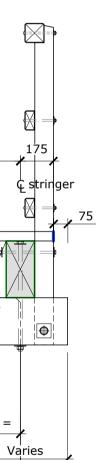





For Tender

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– 300 S.E.D. pile



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Rev.	Description	Drawn	Date	Surveyed:	Survey Date:		Name
А	Draft for comment	BJS	31.01.2020	Co and Custome		Designed	T. Arn
В	For Building Consent	VM	20.04.2020	Coord System: NZGD2000	Drawn	B. Ste	
С	For ESP Internal Review	BJS	03.06.2021	Mt Pleasant 2000	Drg. Chk	T. Arn	
D	For Tender	BJS	26.07.2021	Calibration:	Proj. Mgr	N. Ha	
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				Main Road		Approved	
				R.L. 55.085 (LINZ Dec 2	2013)		

Project Title Date Client Governors Bay Jetty rmstrong 21.11.2019 09.12.2019 Stewart GOVERNORS BAY JETTY RESTORATION TRUST Drawing Title 30.01.2020 rmstrong Bent B07 31.01.2020 larwood Date Cross Section and Plan Details Date Scales 1:20 [A1] 1:40 [A3]
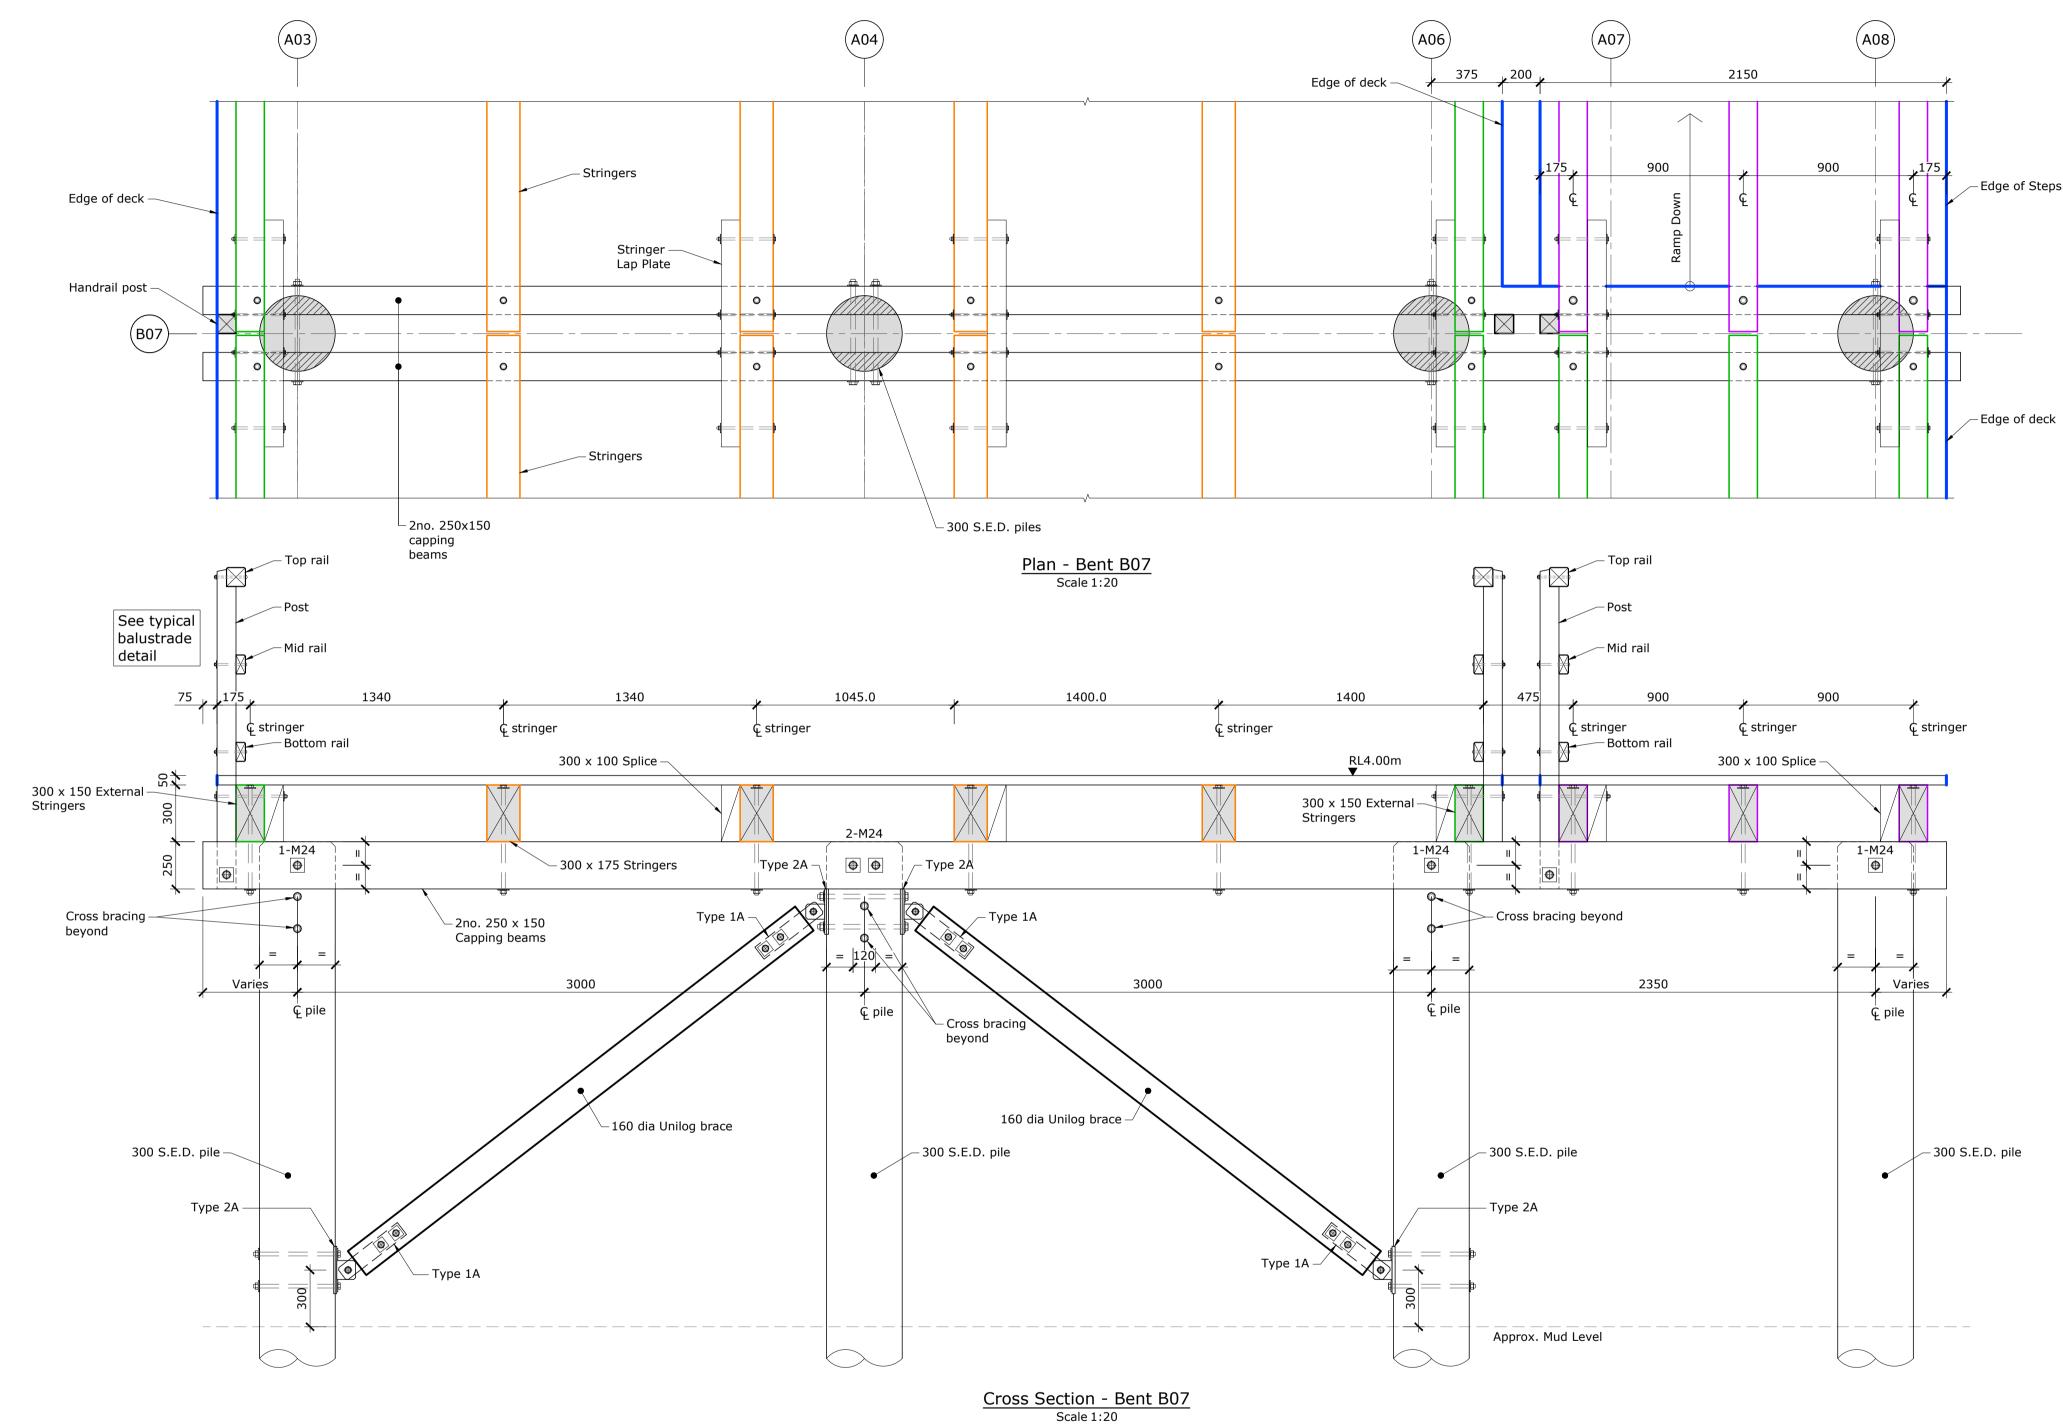
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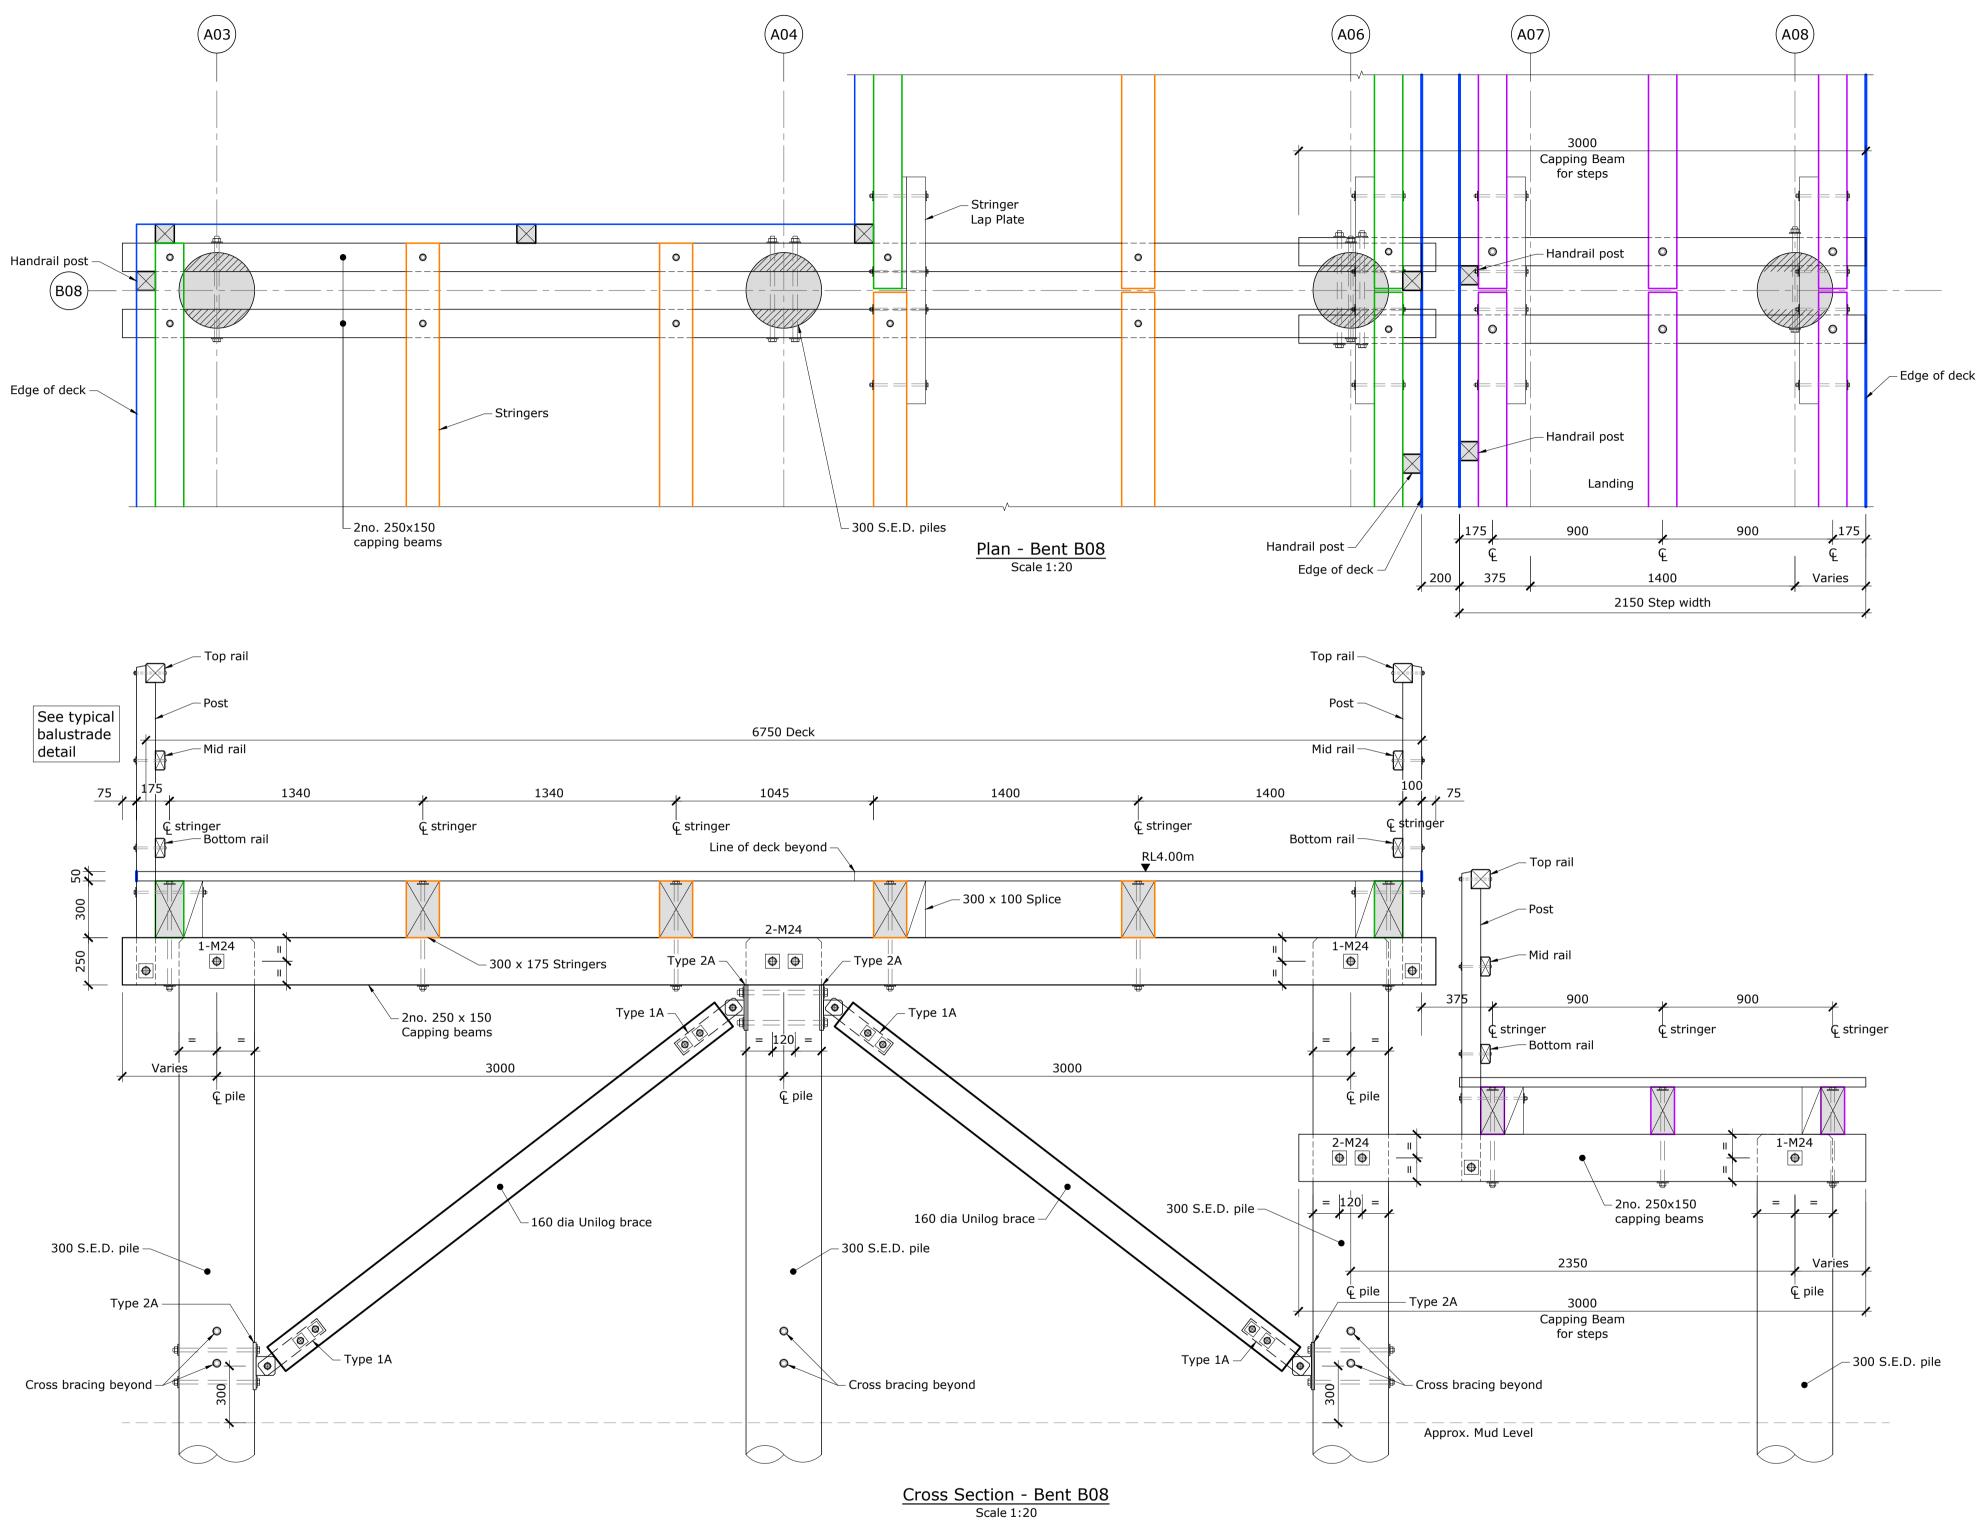



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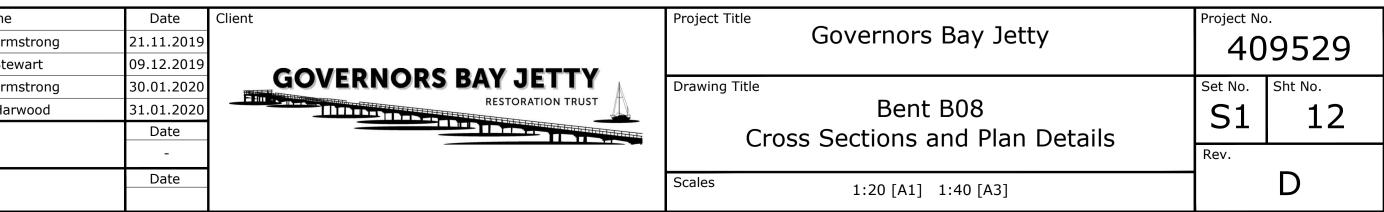
—Edge of Steps

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Rev.	Description	Drawn	Date	Surveyed: Su	irvey Date:		Name
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В	For Building Consent	VM	20.04.2020	Coord System: NZGD2000		Drawn	B. Ste
С	For ESP Internal Review	BJS	03.06.2021			Drg. Chk	T. Arm
D	For Tender	BJS	26.07.2021	Calibration:		Proj. Mgr	N. Har
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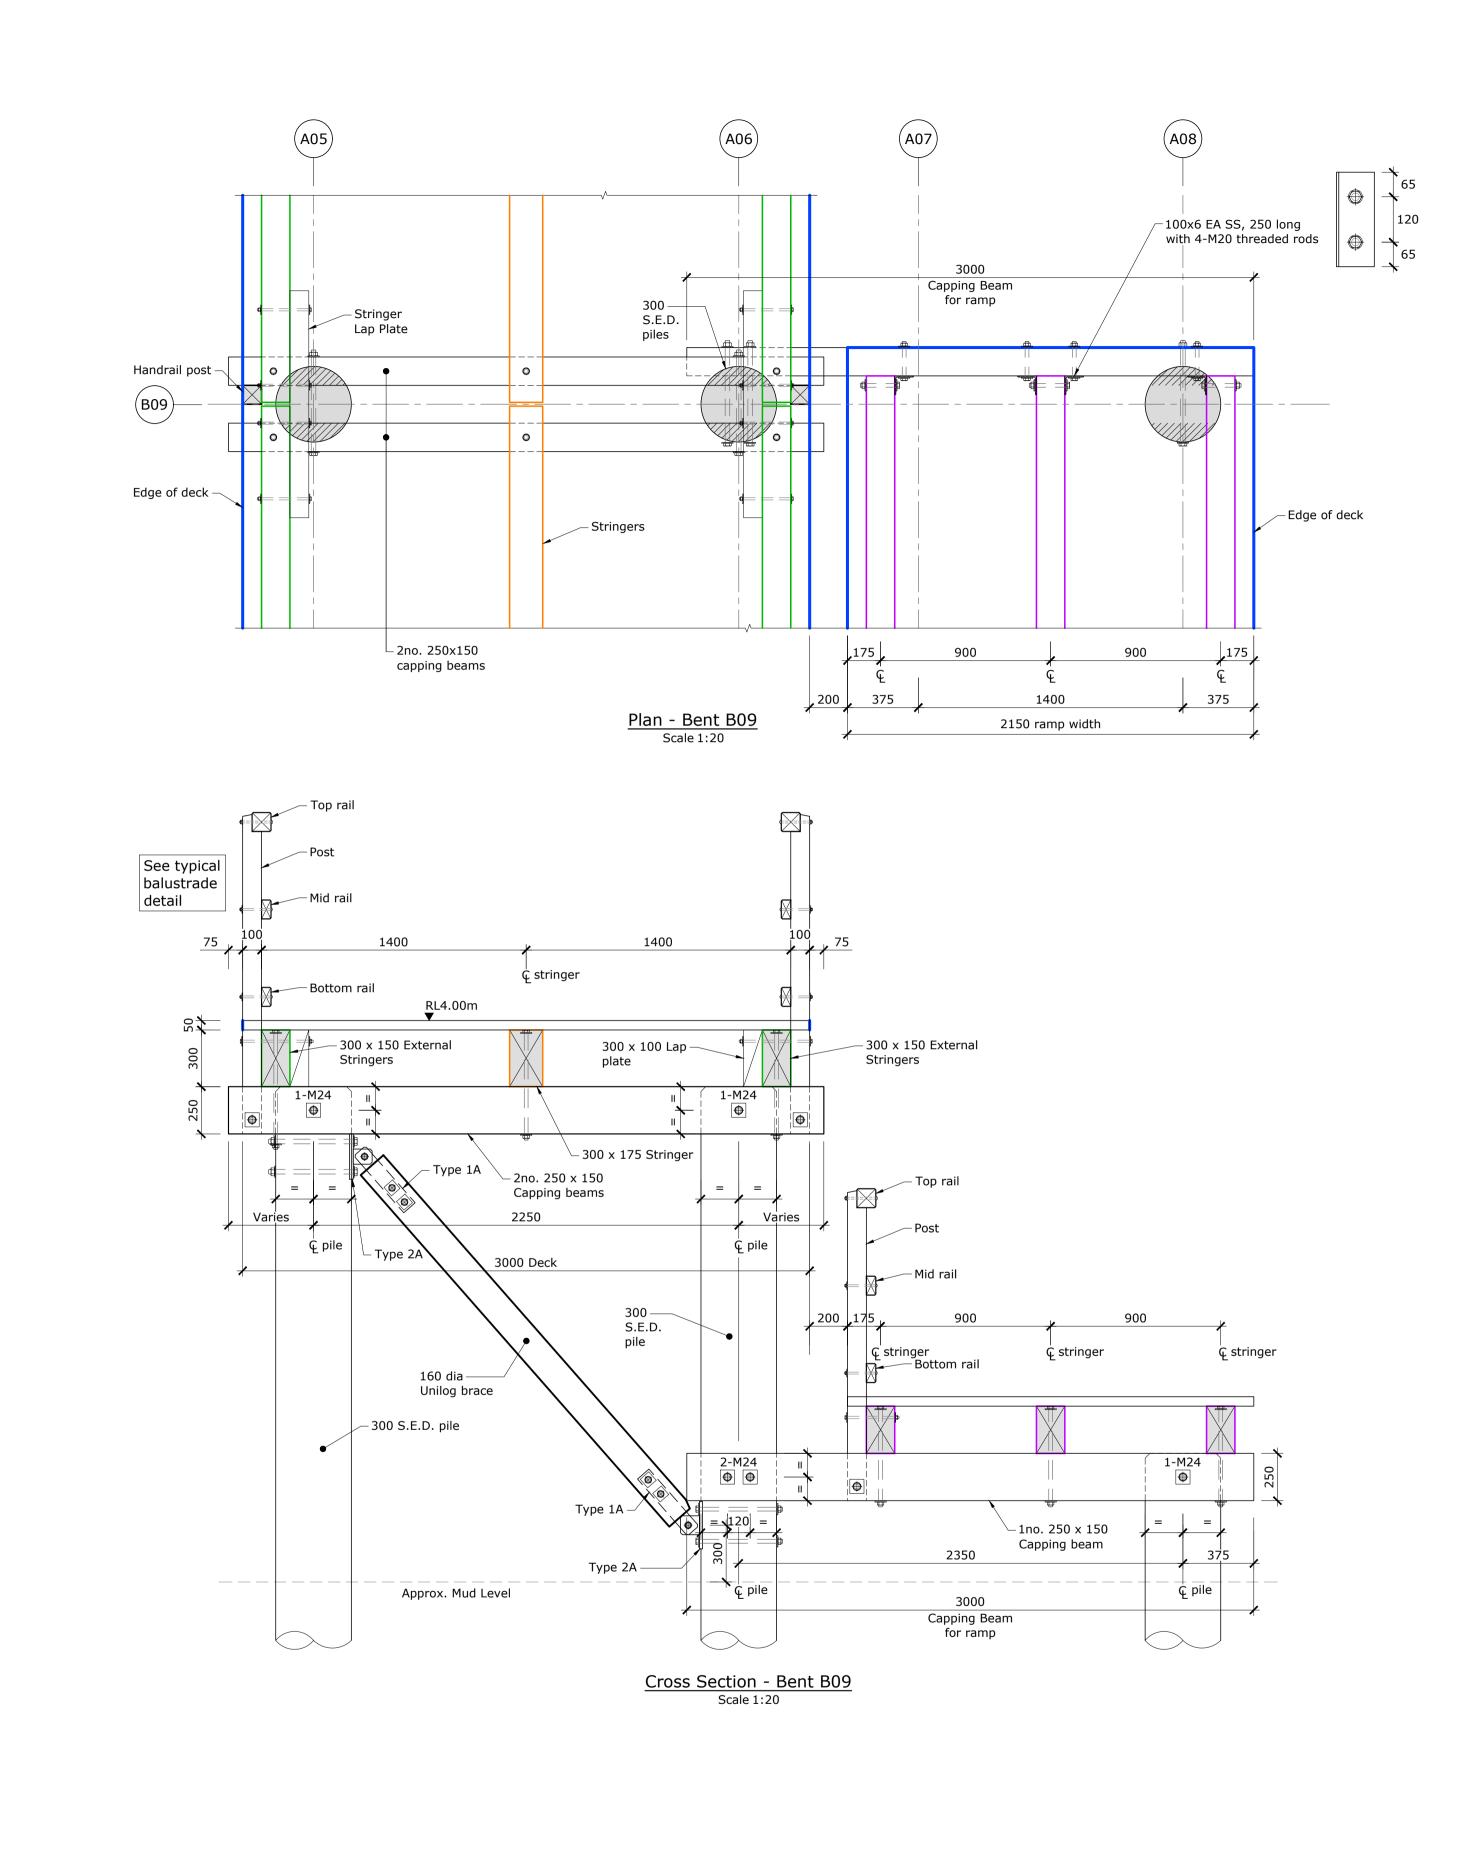


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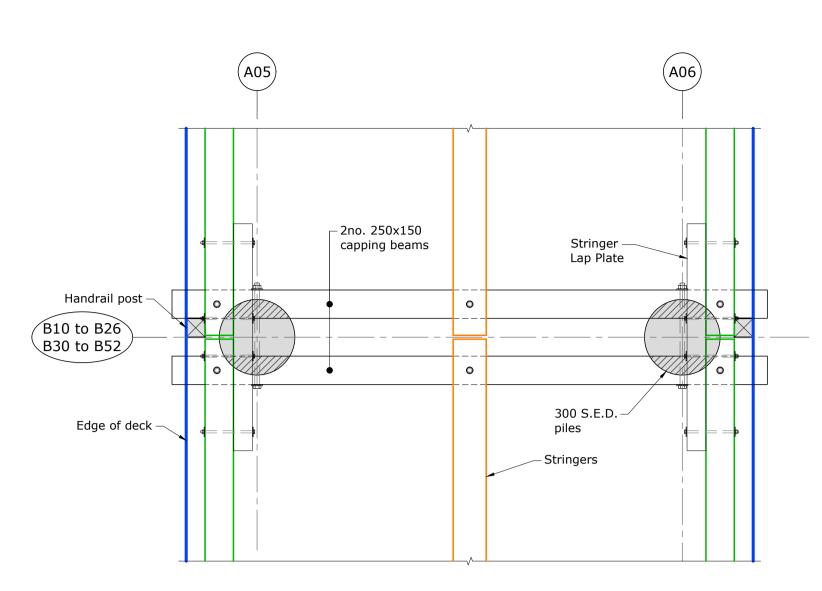


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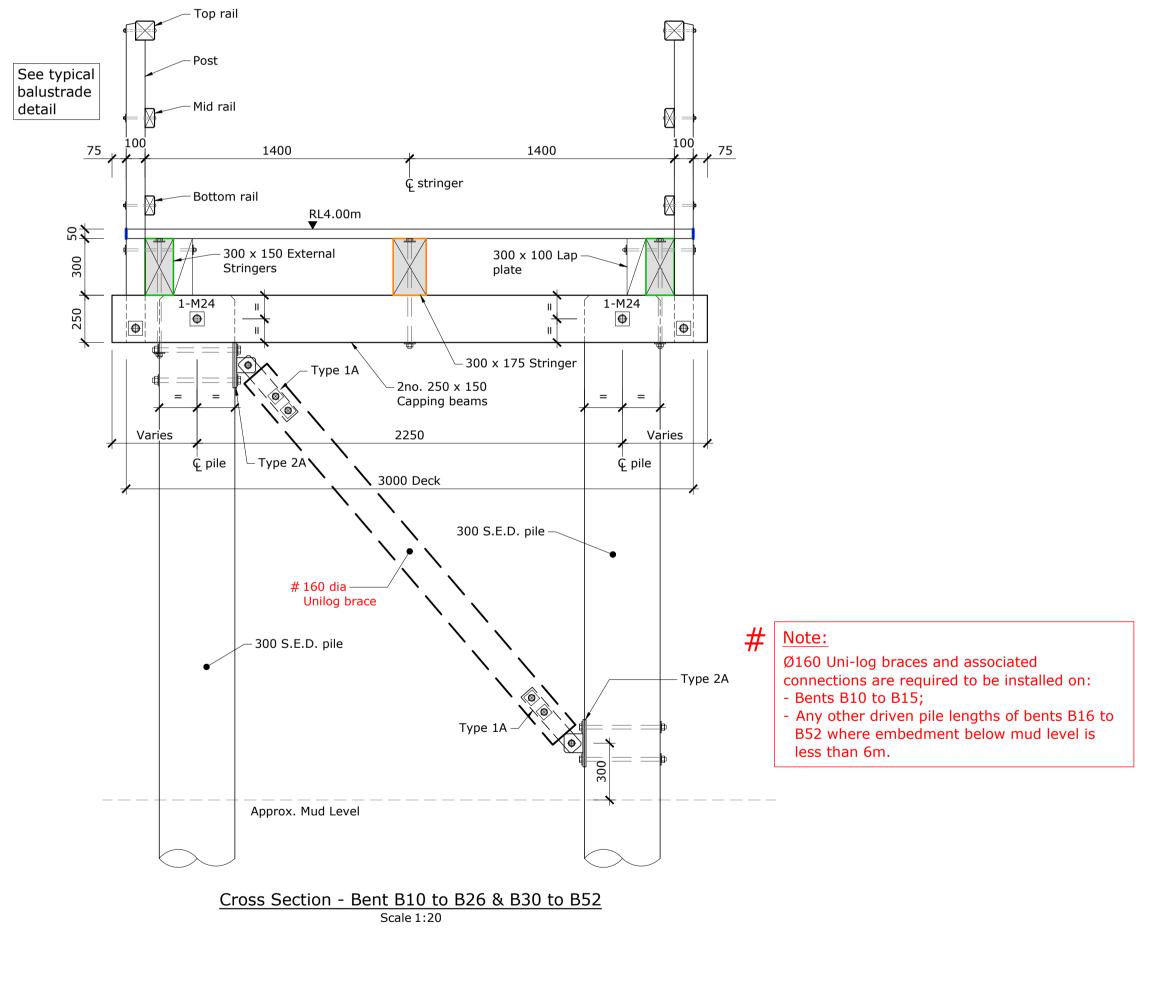
Reference Drawings: Refer to drawings S1-01 & S1-03 for Bent Locations.
 Refer to drawings S1-16 to S1-18 for Typical Construction Details.

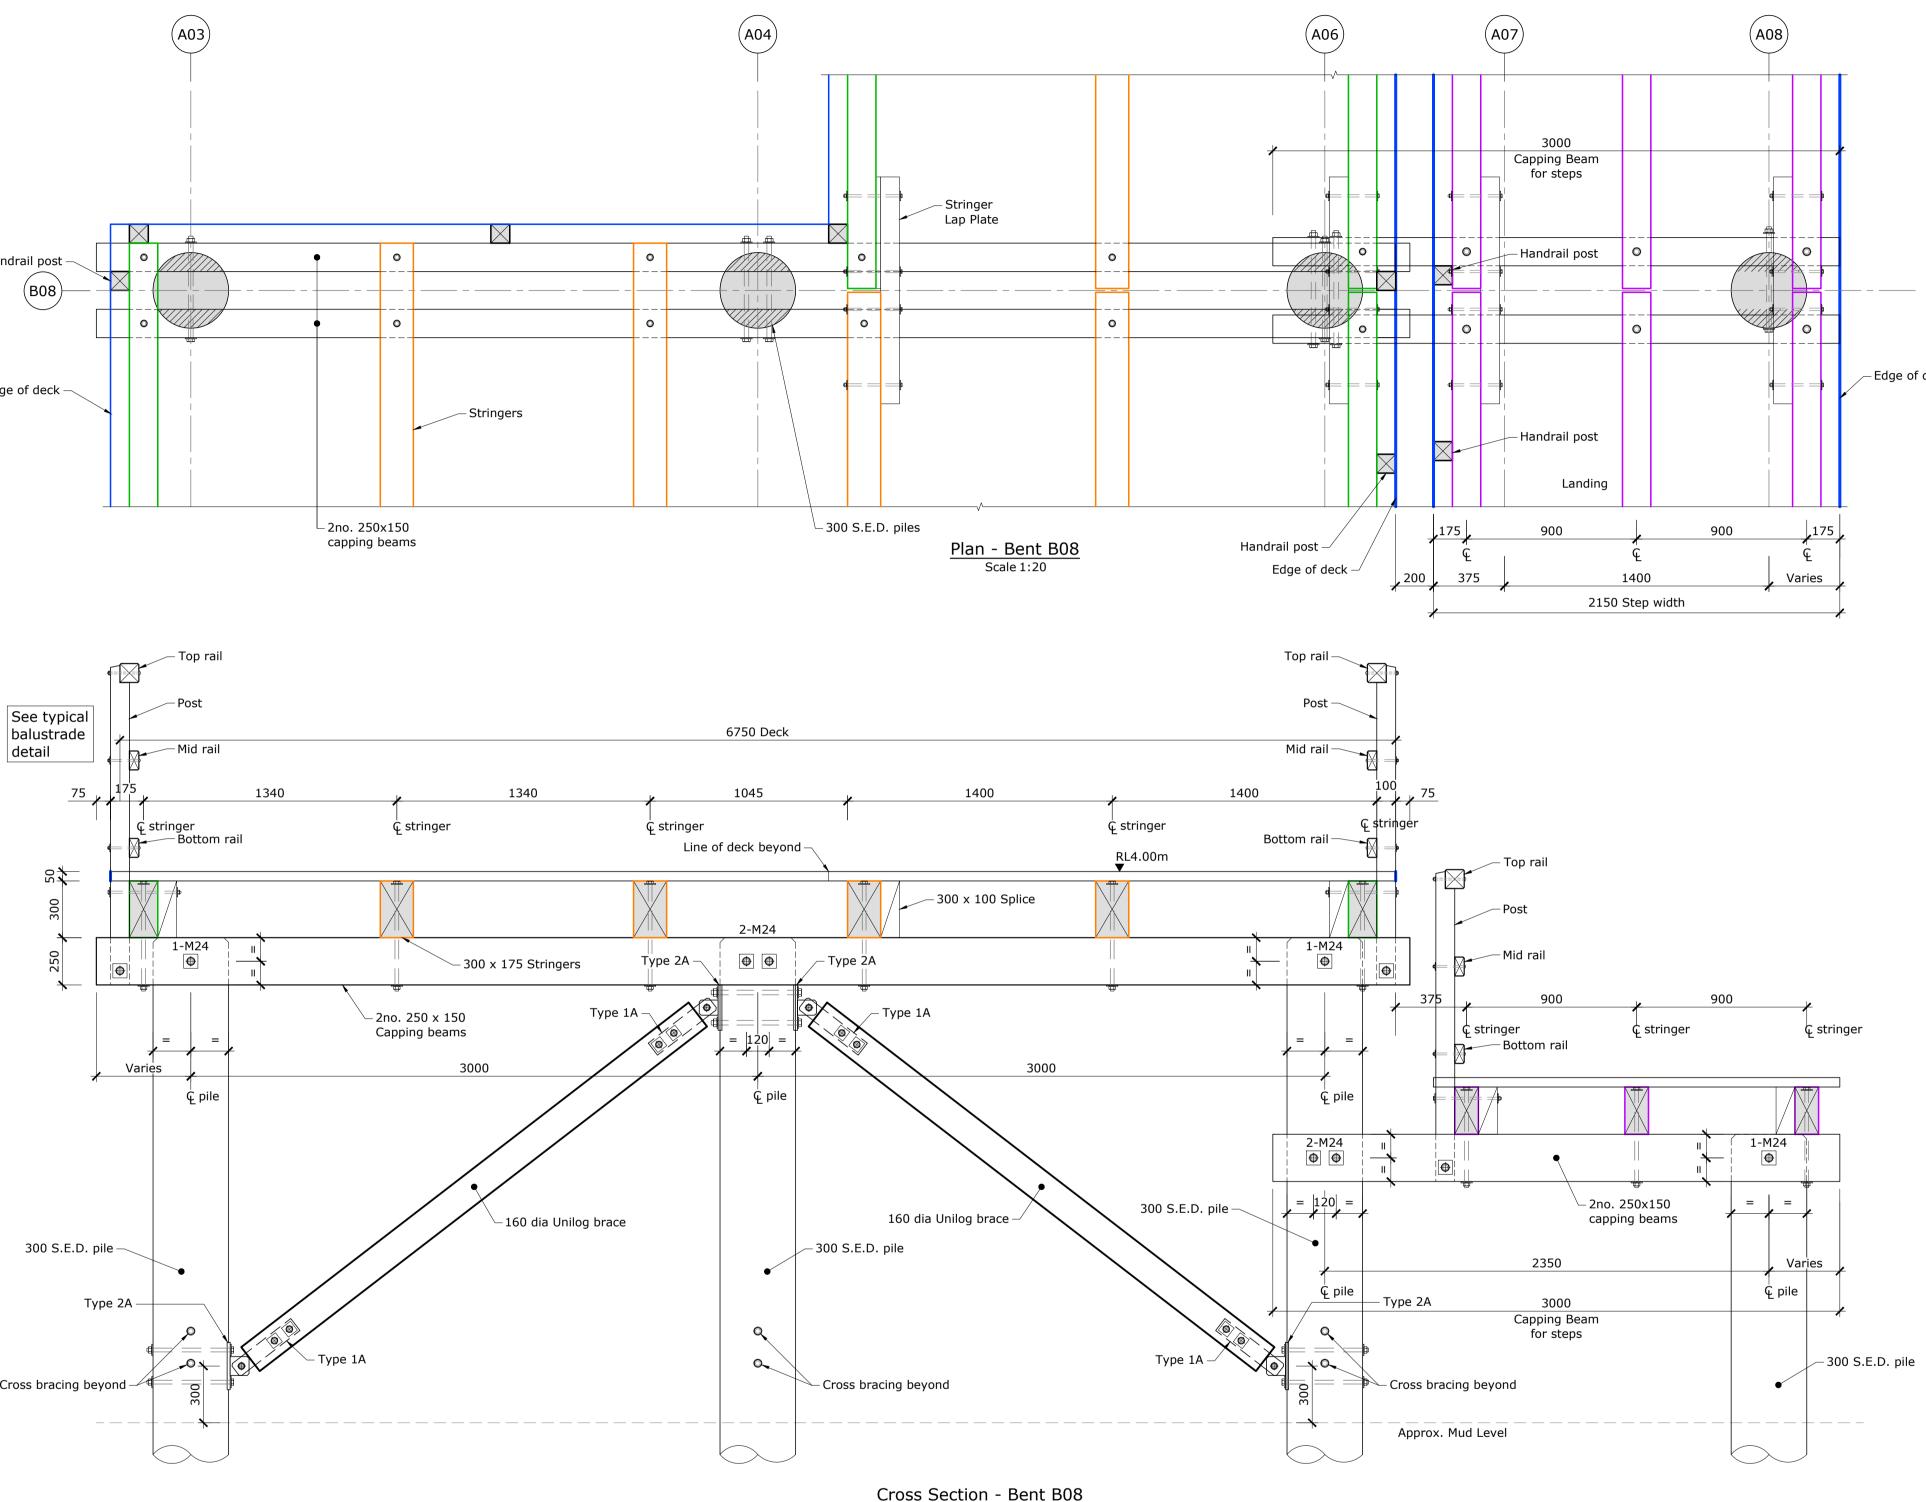

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	В	For Building Consent	VM	20.04.2020	Coord System: NZGD2000	Drawn	B. Stewart	09.12.2019					
	С	For ESP Internal Review	BJS	03.06.2021	Mt Pleasant 2000	Drg. Chk	T. Armstrong	30.01.2020	GOVERNORS BAY JETTY	Drawing Title	Set		
	D	For Tender	BJS	26.07.2021	Calibration:	Proj. Mgr	N. Harwood	31.01.2020	RESTORATION TRUST	Bent B09, B10 to B26 & B30 to B52			
					Origin of Levels: Datum:	Design Rev	esign Review		view Date			Cross Sections and Plan Details	
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					Main Road	Approved		Date	1	Scales 1.20 [A1] 1.40 [A2]	1		
					R.L. 55.085 (LINZ Dec 2013)					1:20 [A1] 1:40 [A3]			



Plan - Bent B10 to B15 Scale 1:20



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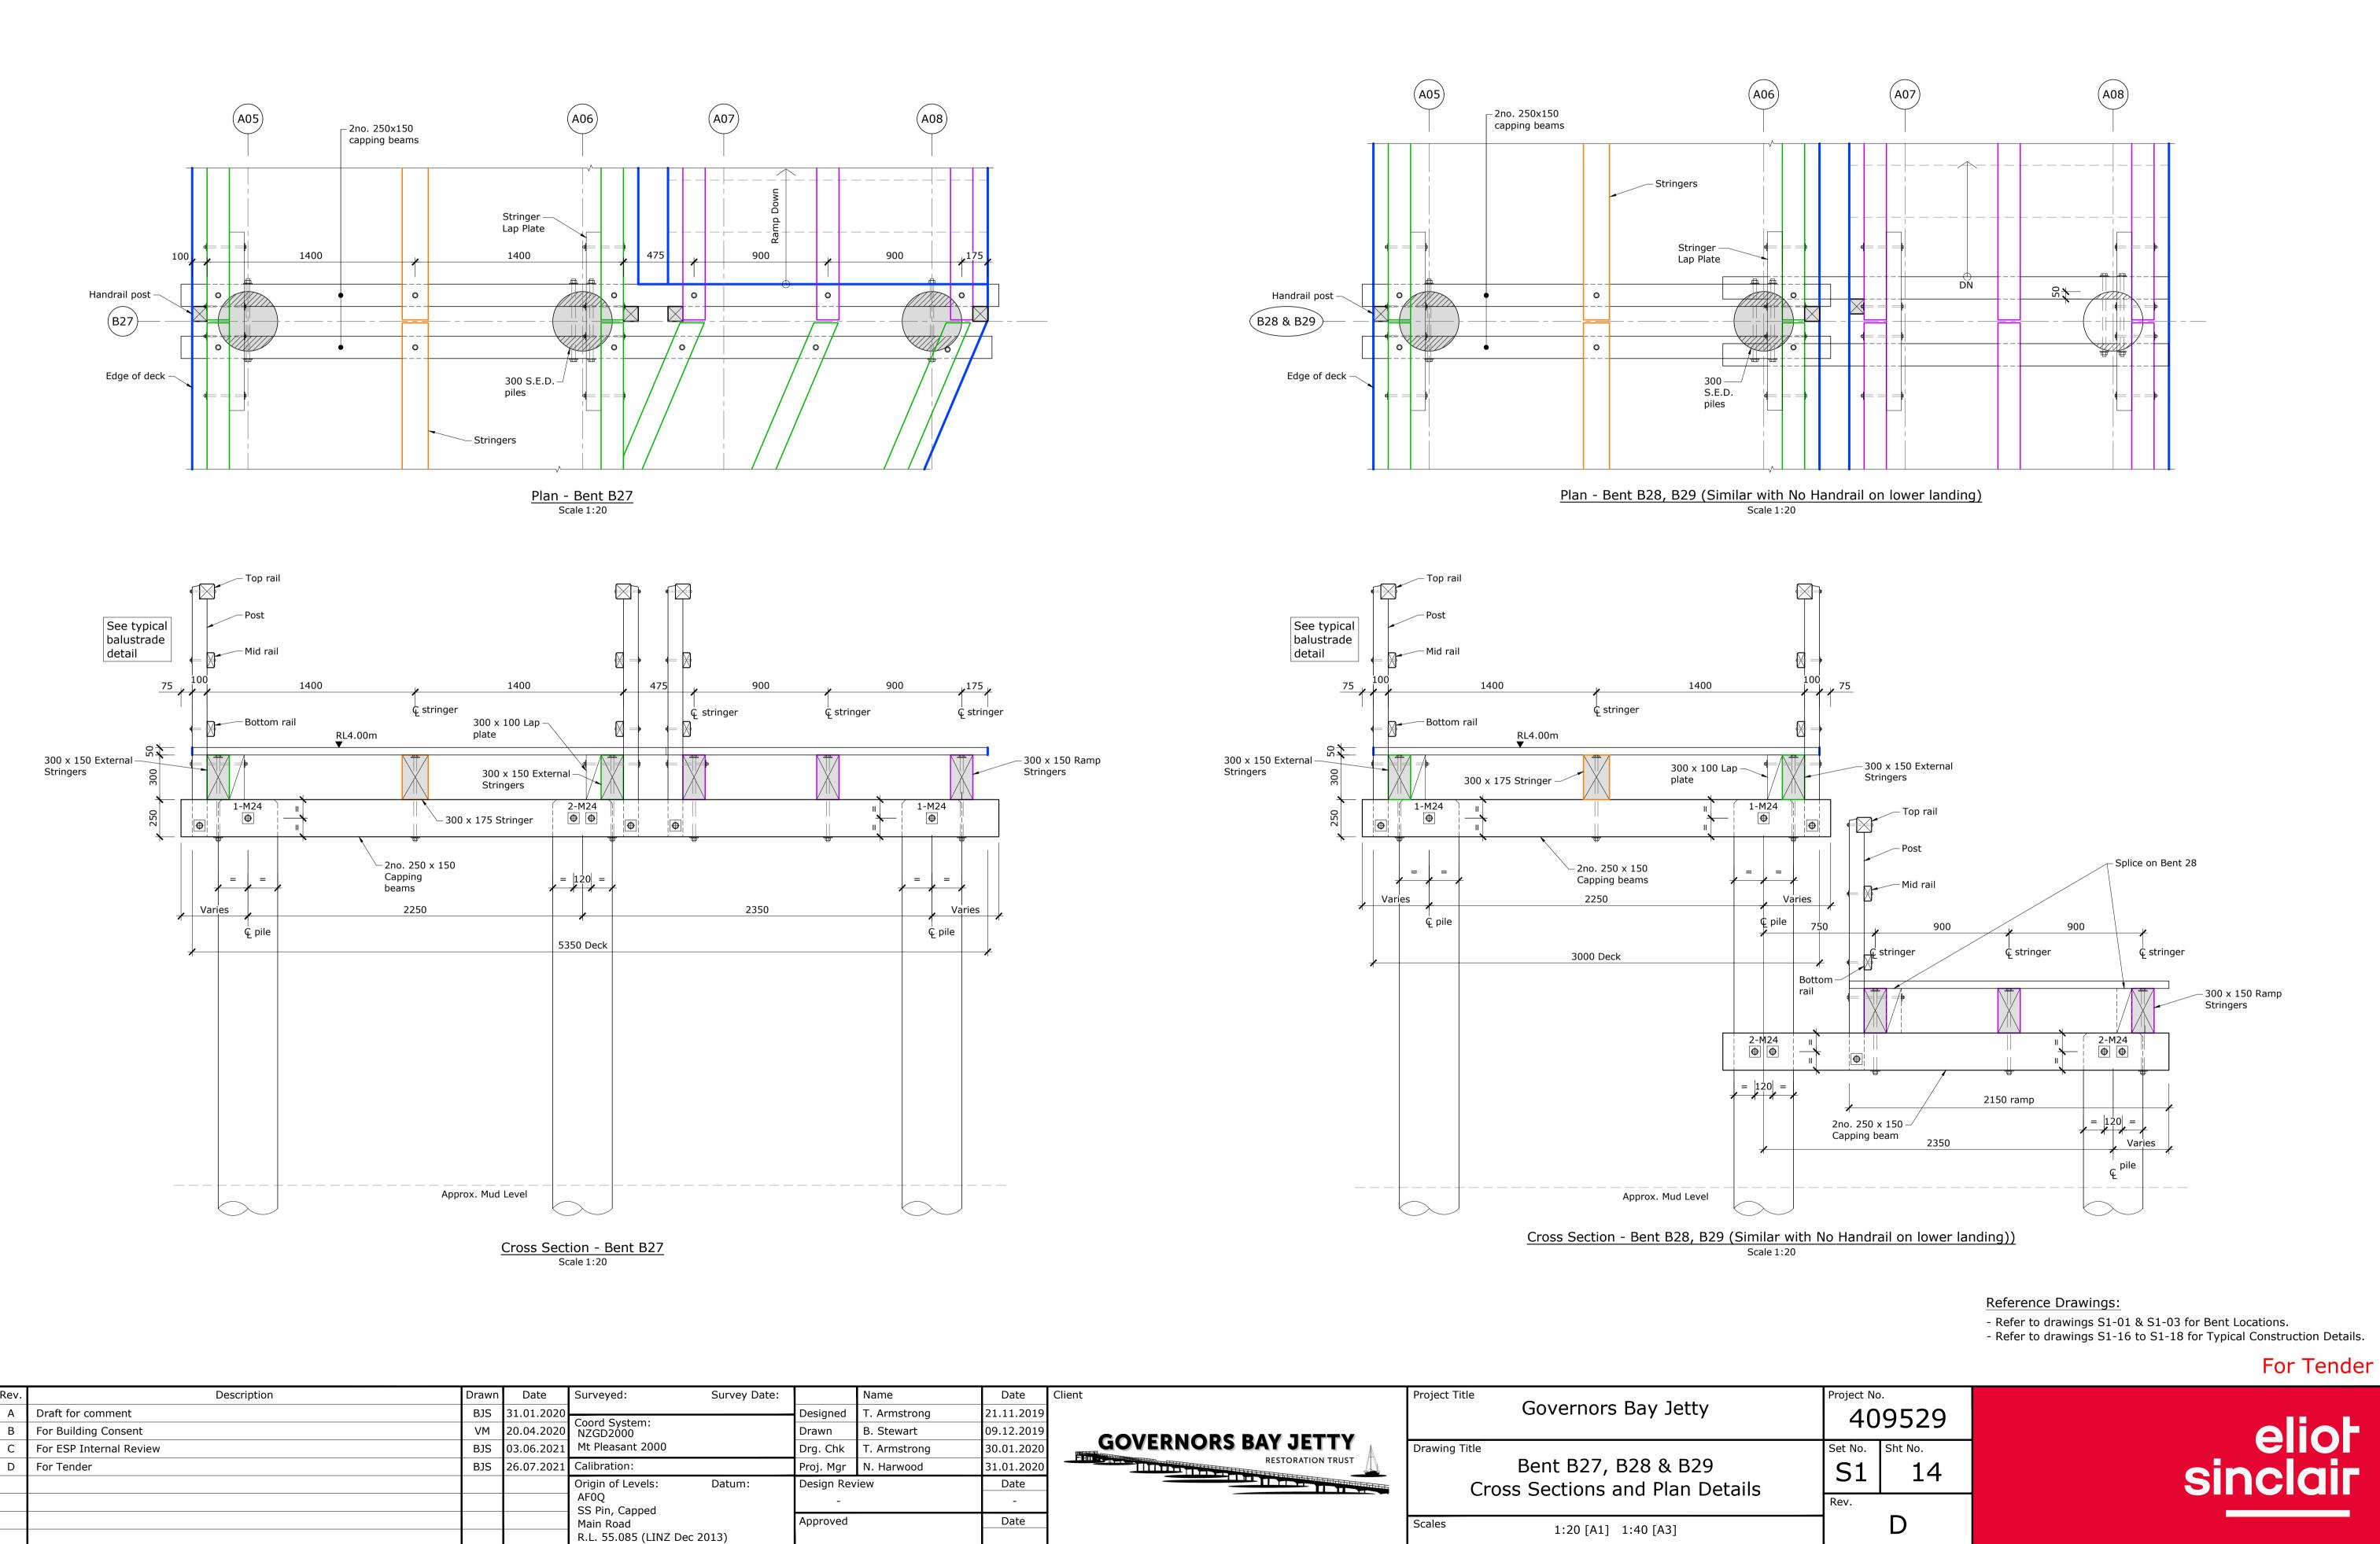



Reference Drawings: Refer to drawings S1-01 & S1-03 for Bent Locations.
 Refer to drawings S1-16 to S1-18 for Typical Construction Details.


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Project No. 409529 Set No. Sht No. **S**1 13 Rev. D





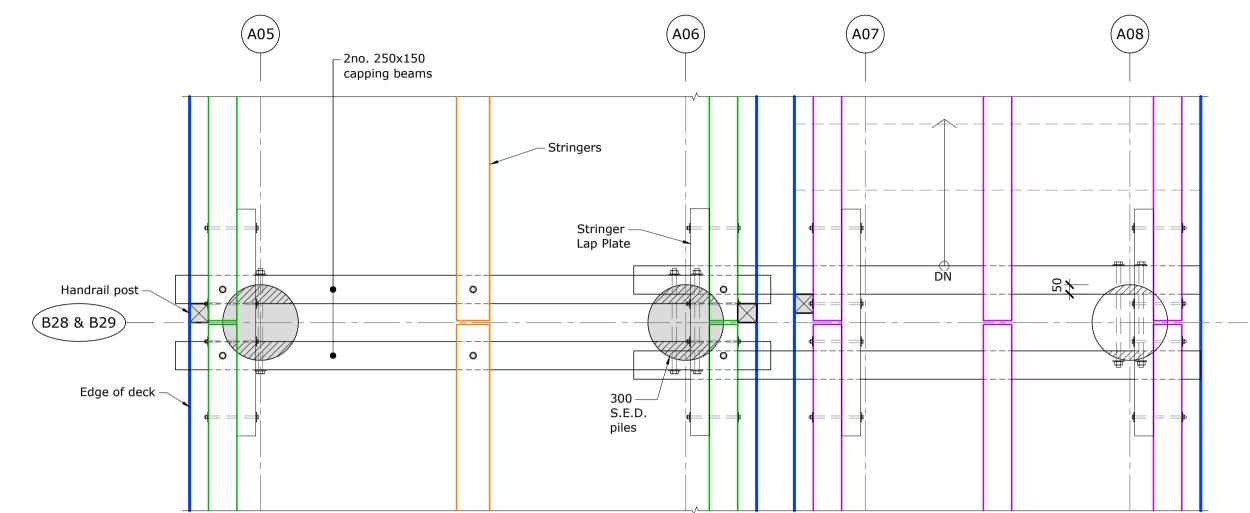


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wart	09.12.2019			
nstrong	30.01.2020	GOVERNORS BAY JETTY	Drawing Title	S
rwood	31.01.2020	RESTORATION TRUST	Bent B27, B28 & B29	
	Date		Cross Sections and Plan Details	
	-			R
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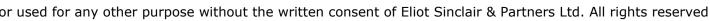


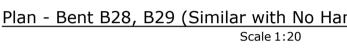



istrong	21.11.2019		Governors day Jelly	
wart	09.12.2019	COVERNORS RAV JETTV		
istrong	30.01.2020	GOVERNORS BAY JETTY	Drawing Title	S
wood	31.01.2020	RESTORATION TRUST	Bent B53, B54 & B55	
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	-			R
	Date		Scales 1:20 [A1] 1:40 [A3]	1
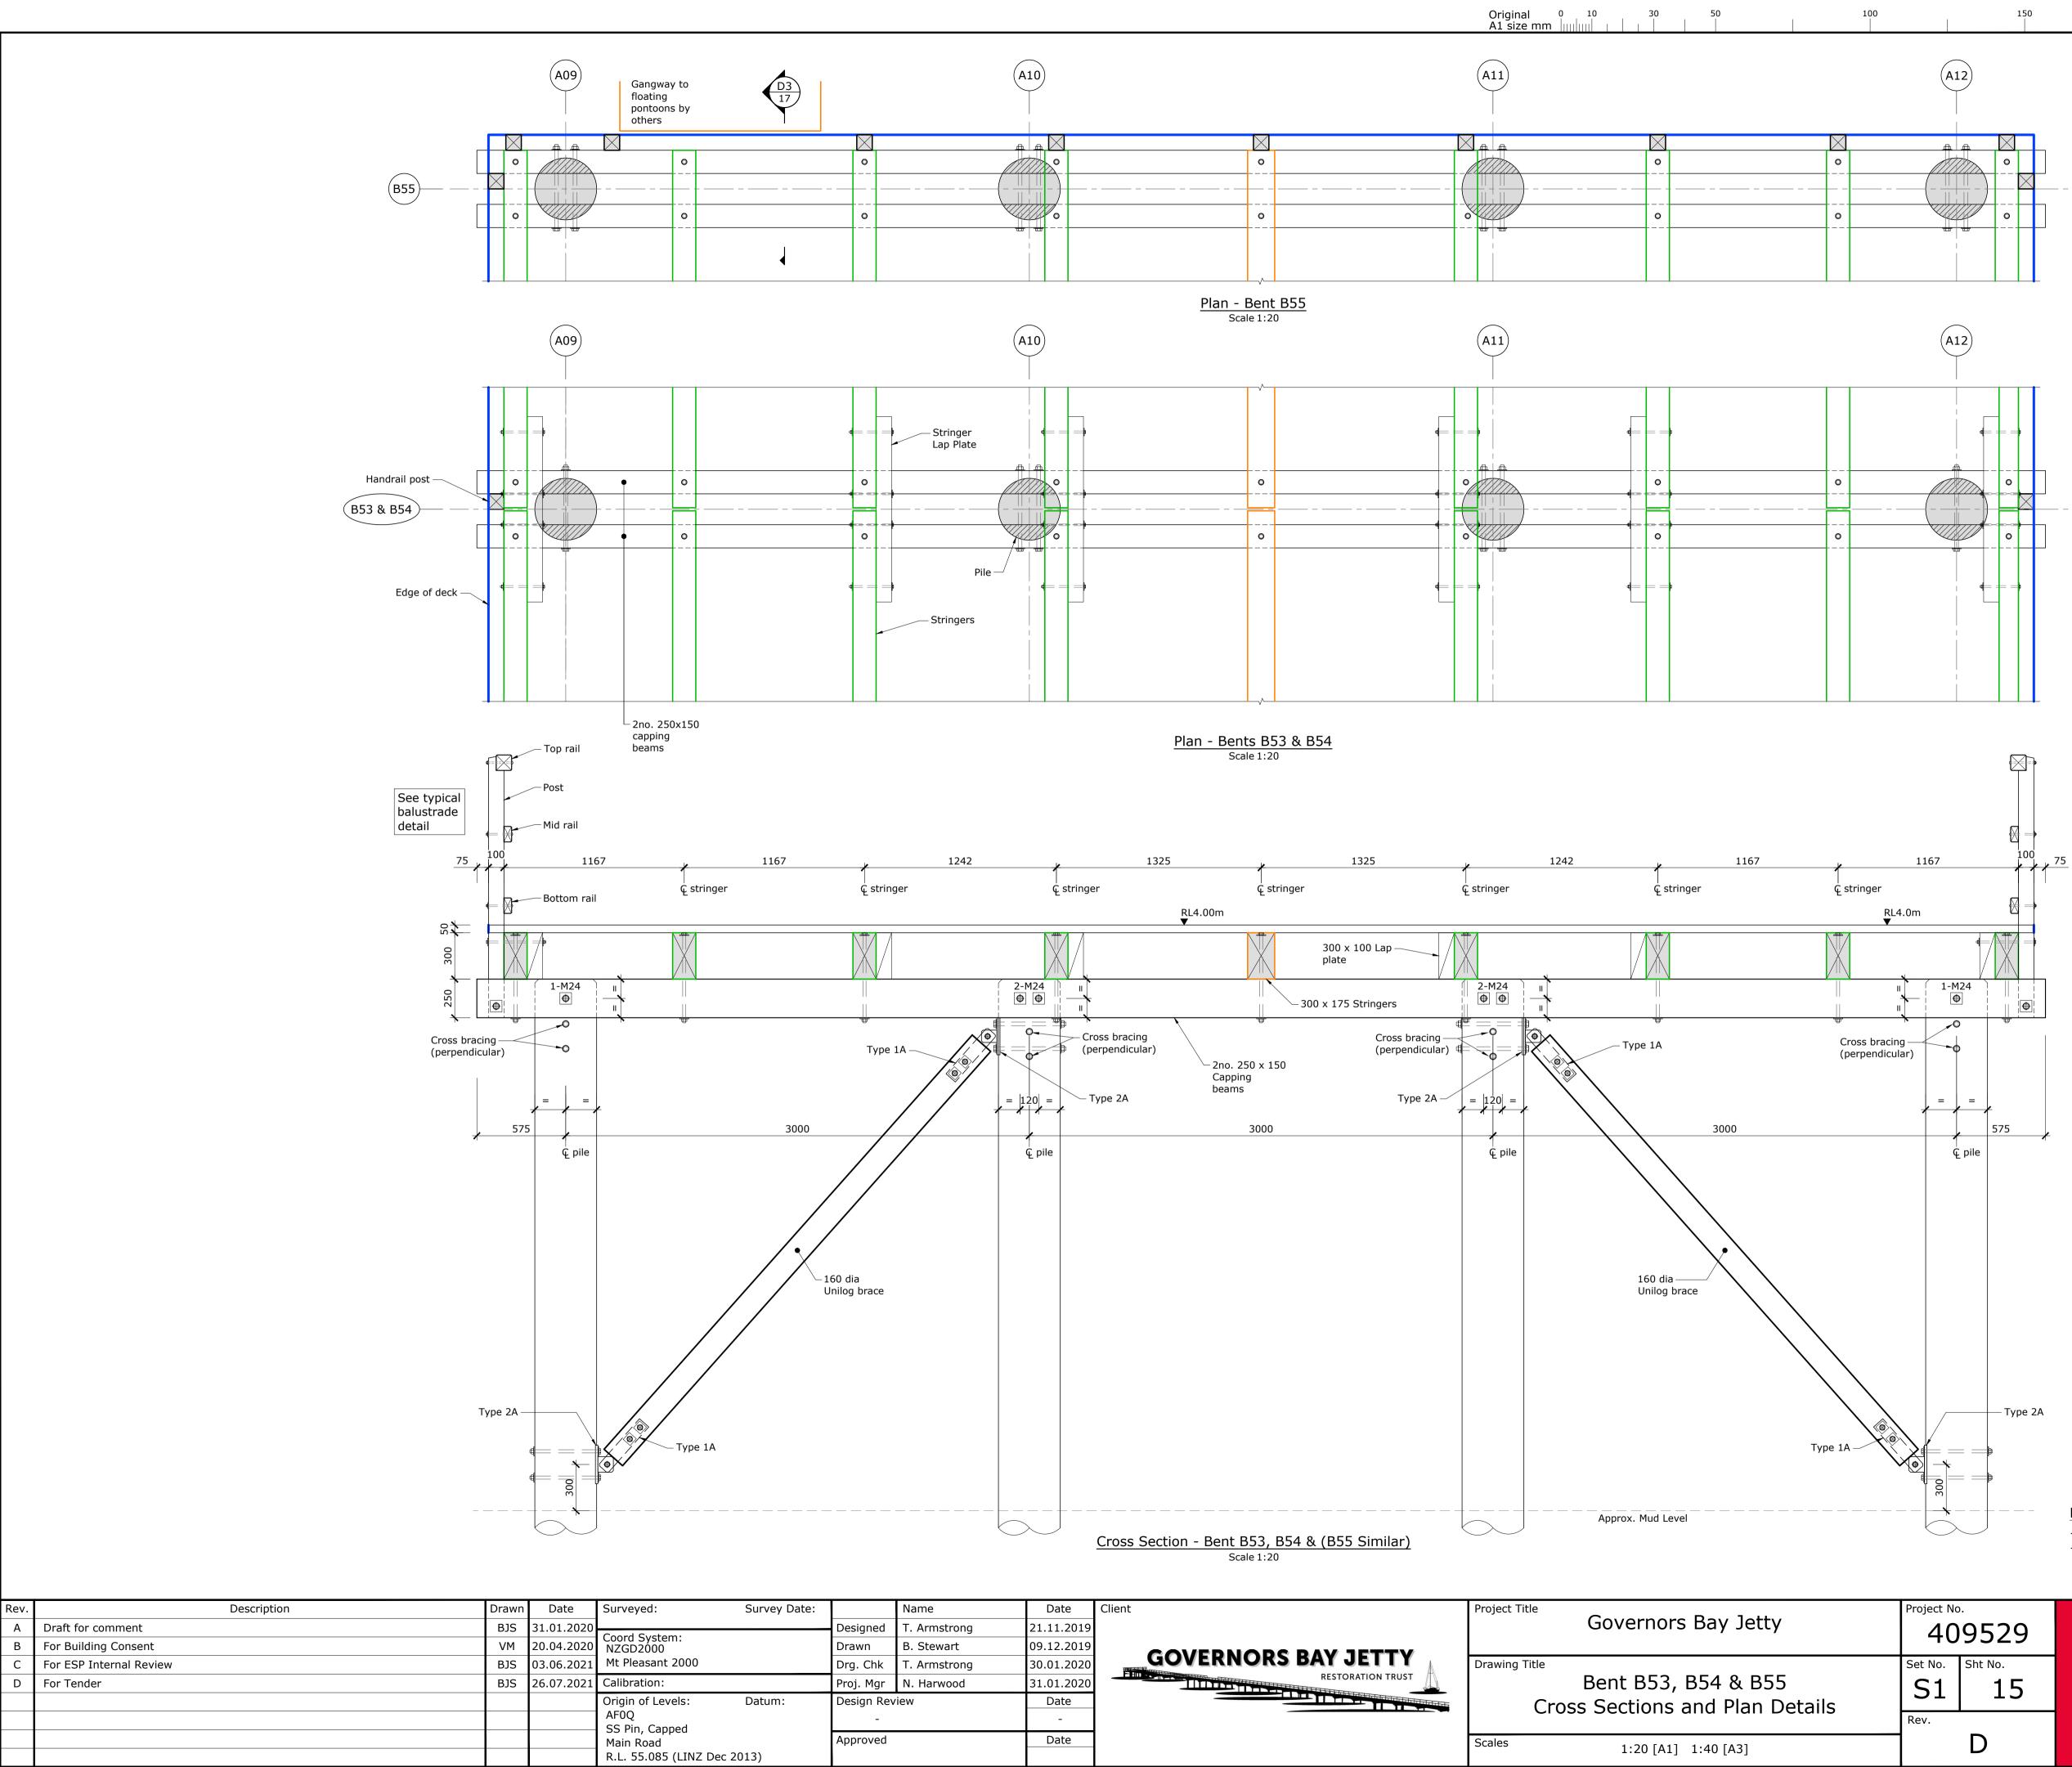
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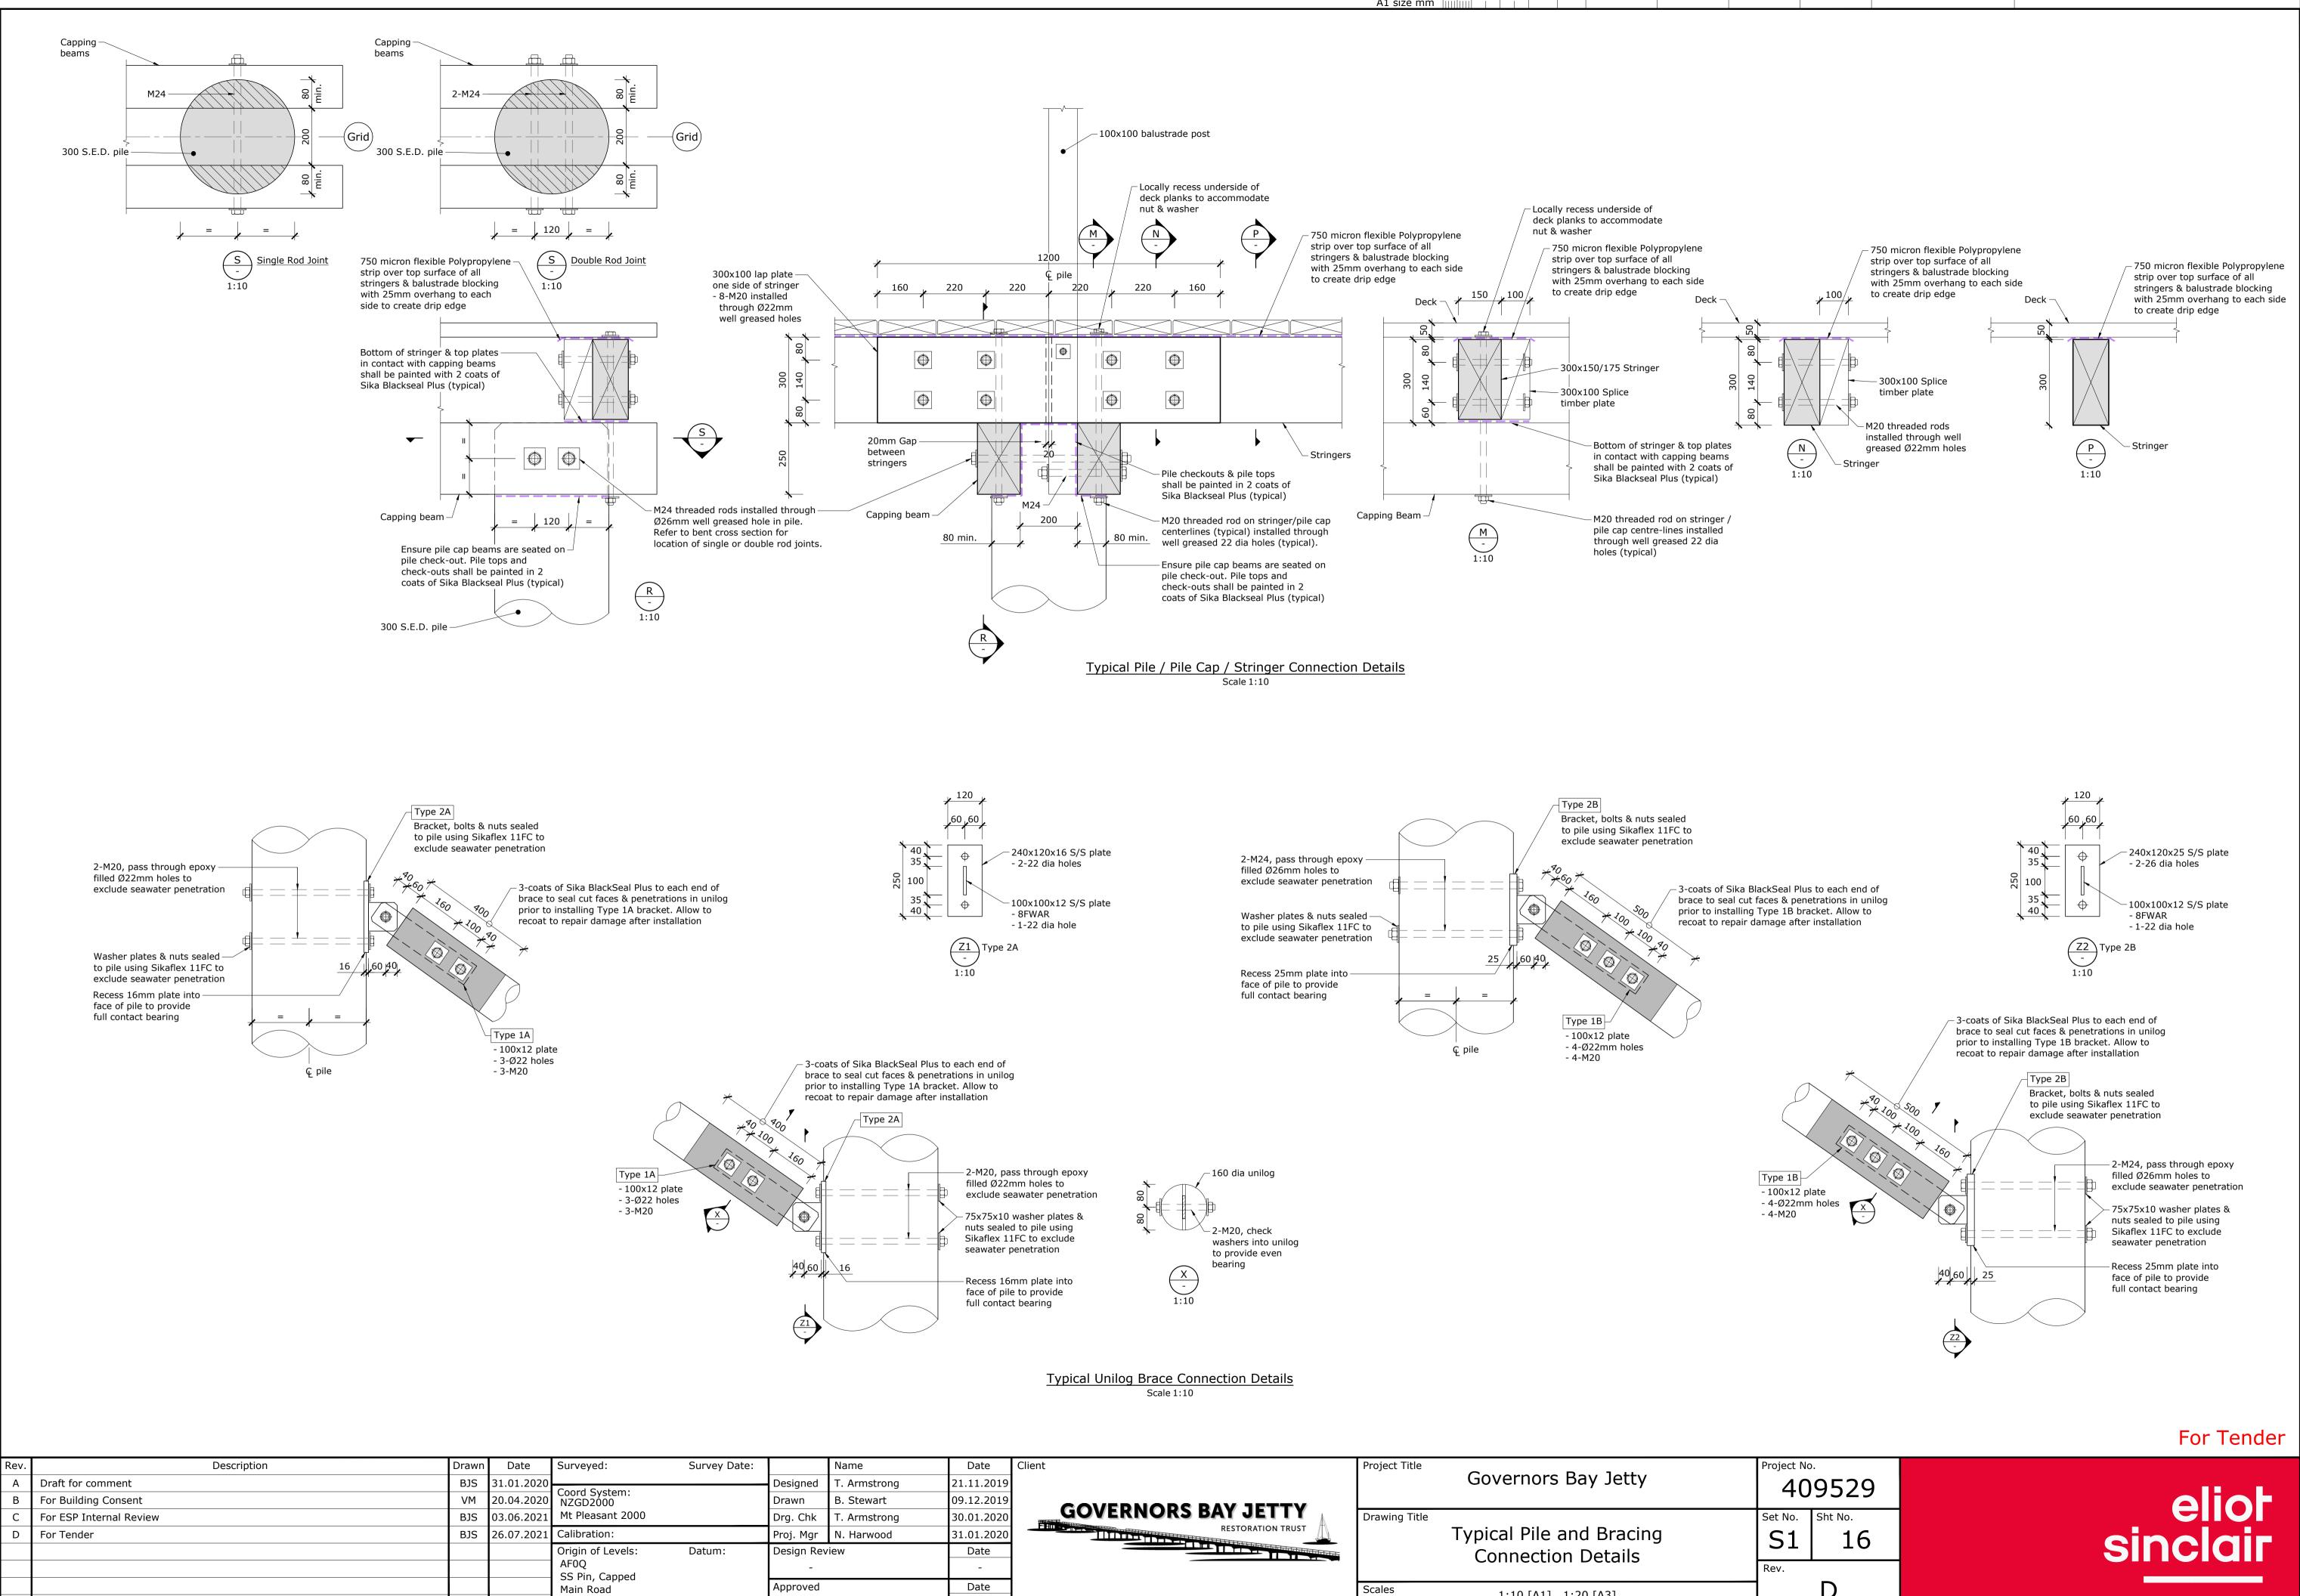


For Tender

Refer to drawings S1-01 & S1-03 for Bent Locations.
 Refer to drawings S1-16 to S1-18 for Typical Construction Details.

Reference Drawings:






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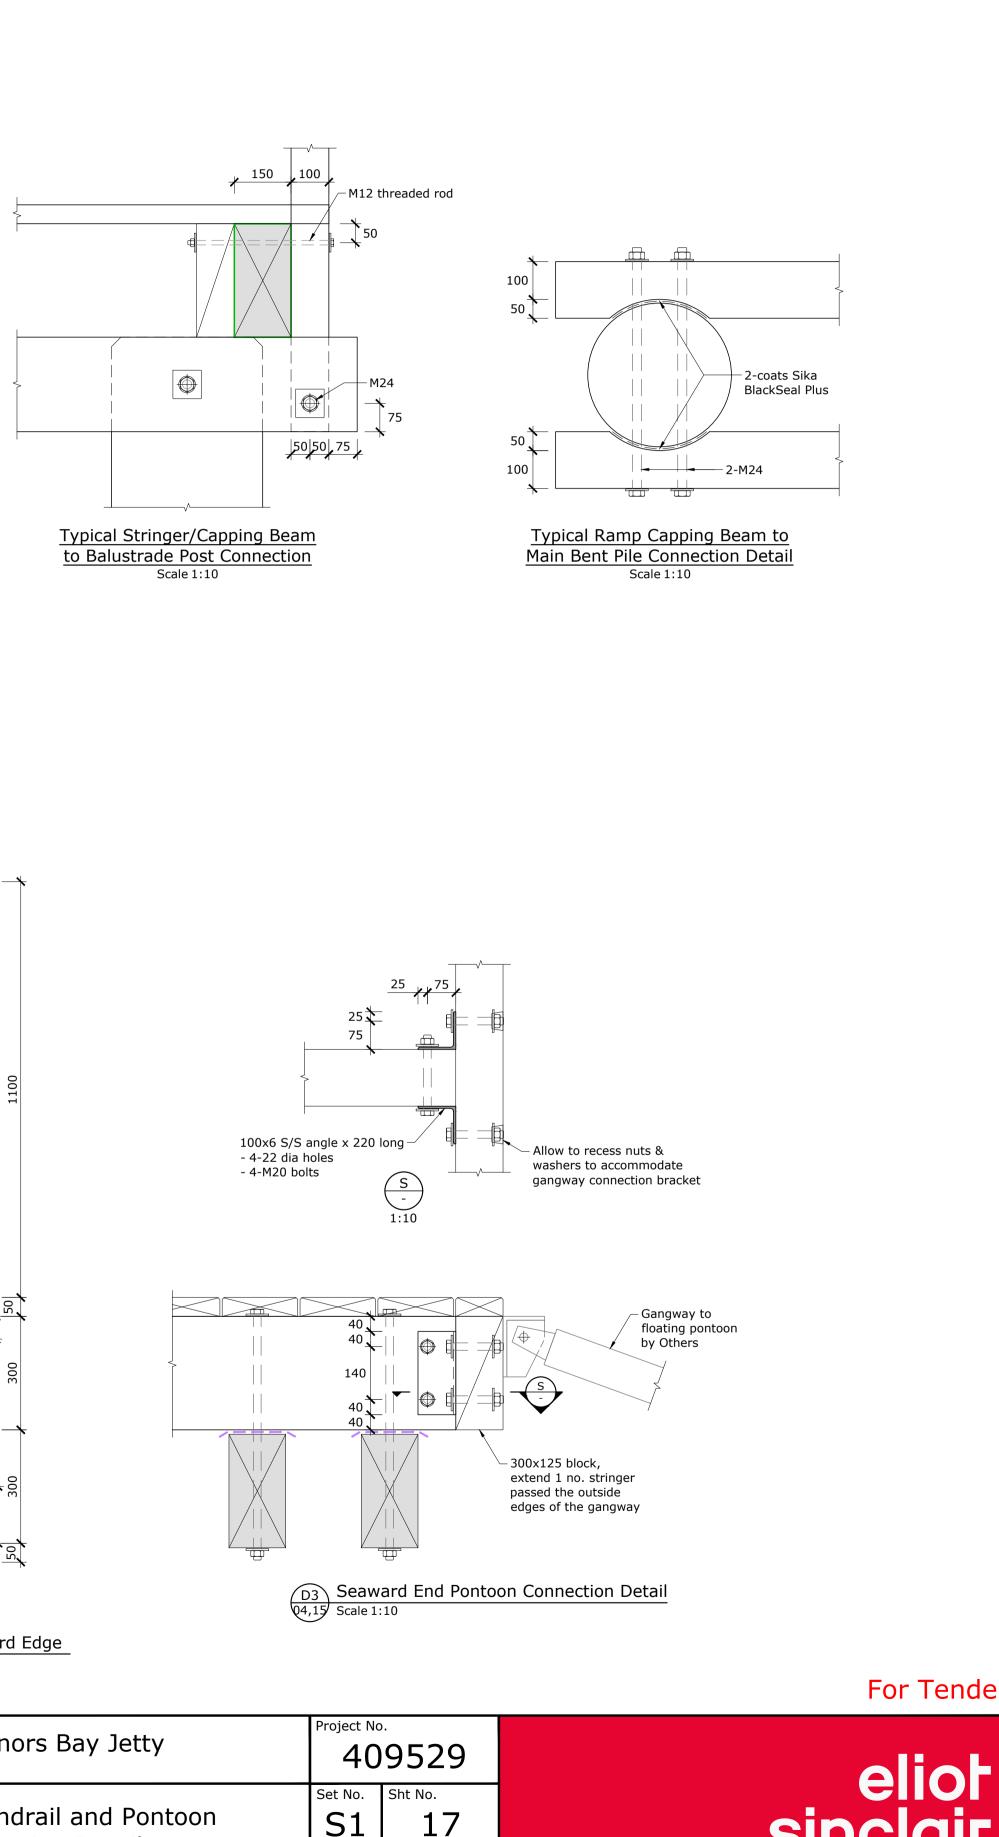
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mstrong	30.01.2020	GOVERNORS BAY JETTY	Drawing Title
arwood	31.01.2020	RESTORATION TRUST	Typical Pile and Bracing
	Date		Connection Details
	-		
	Date		Scales 1:10 [A1] 1:20 [A3]
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Main Road



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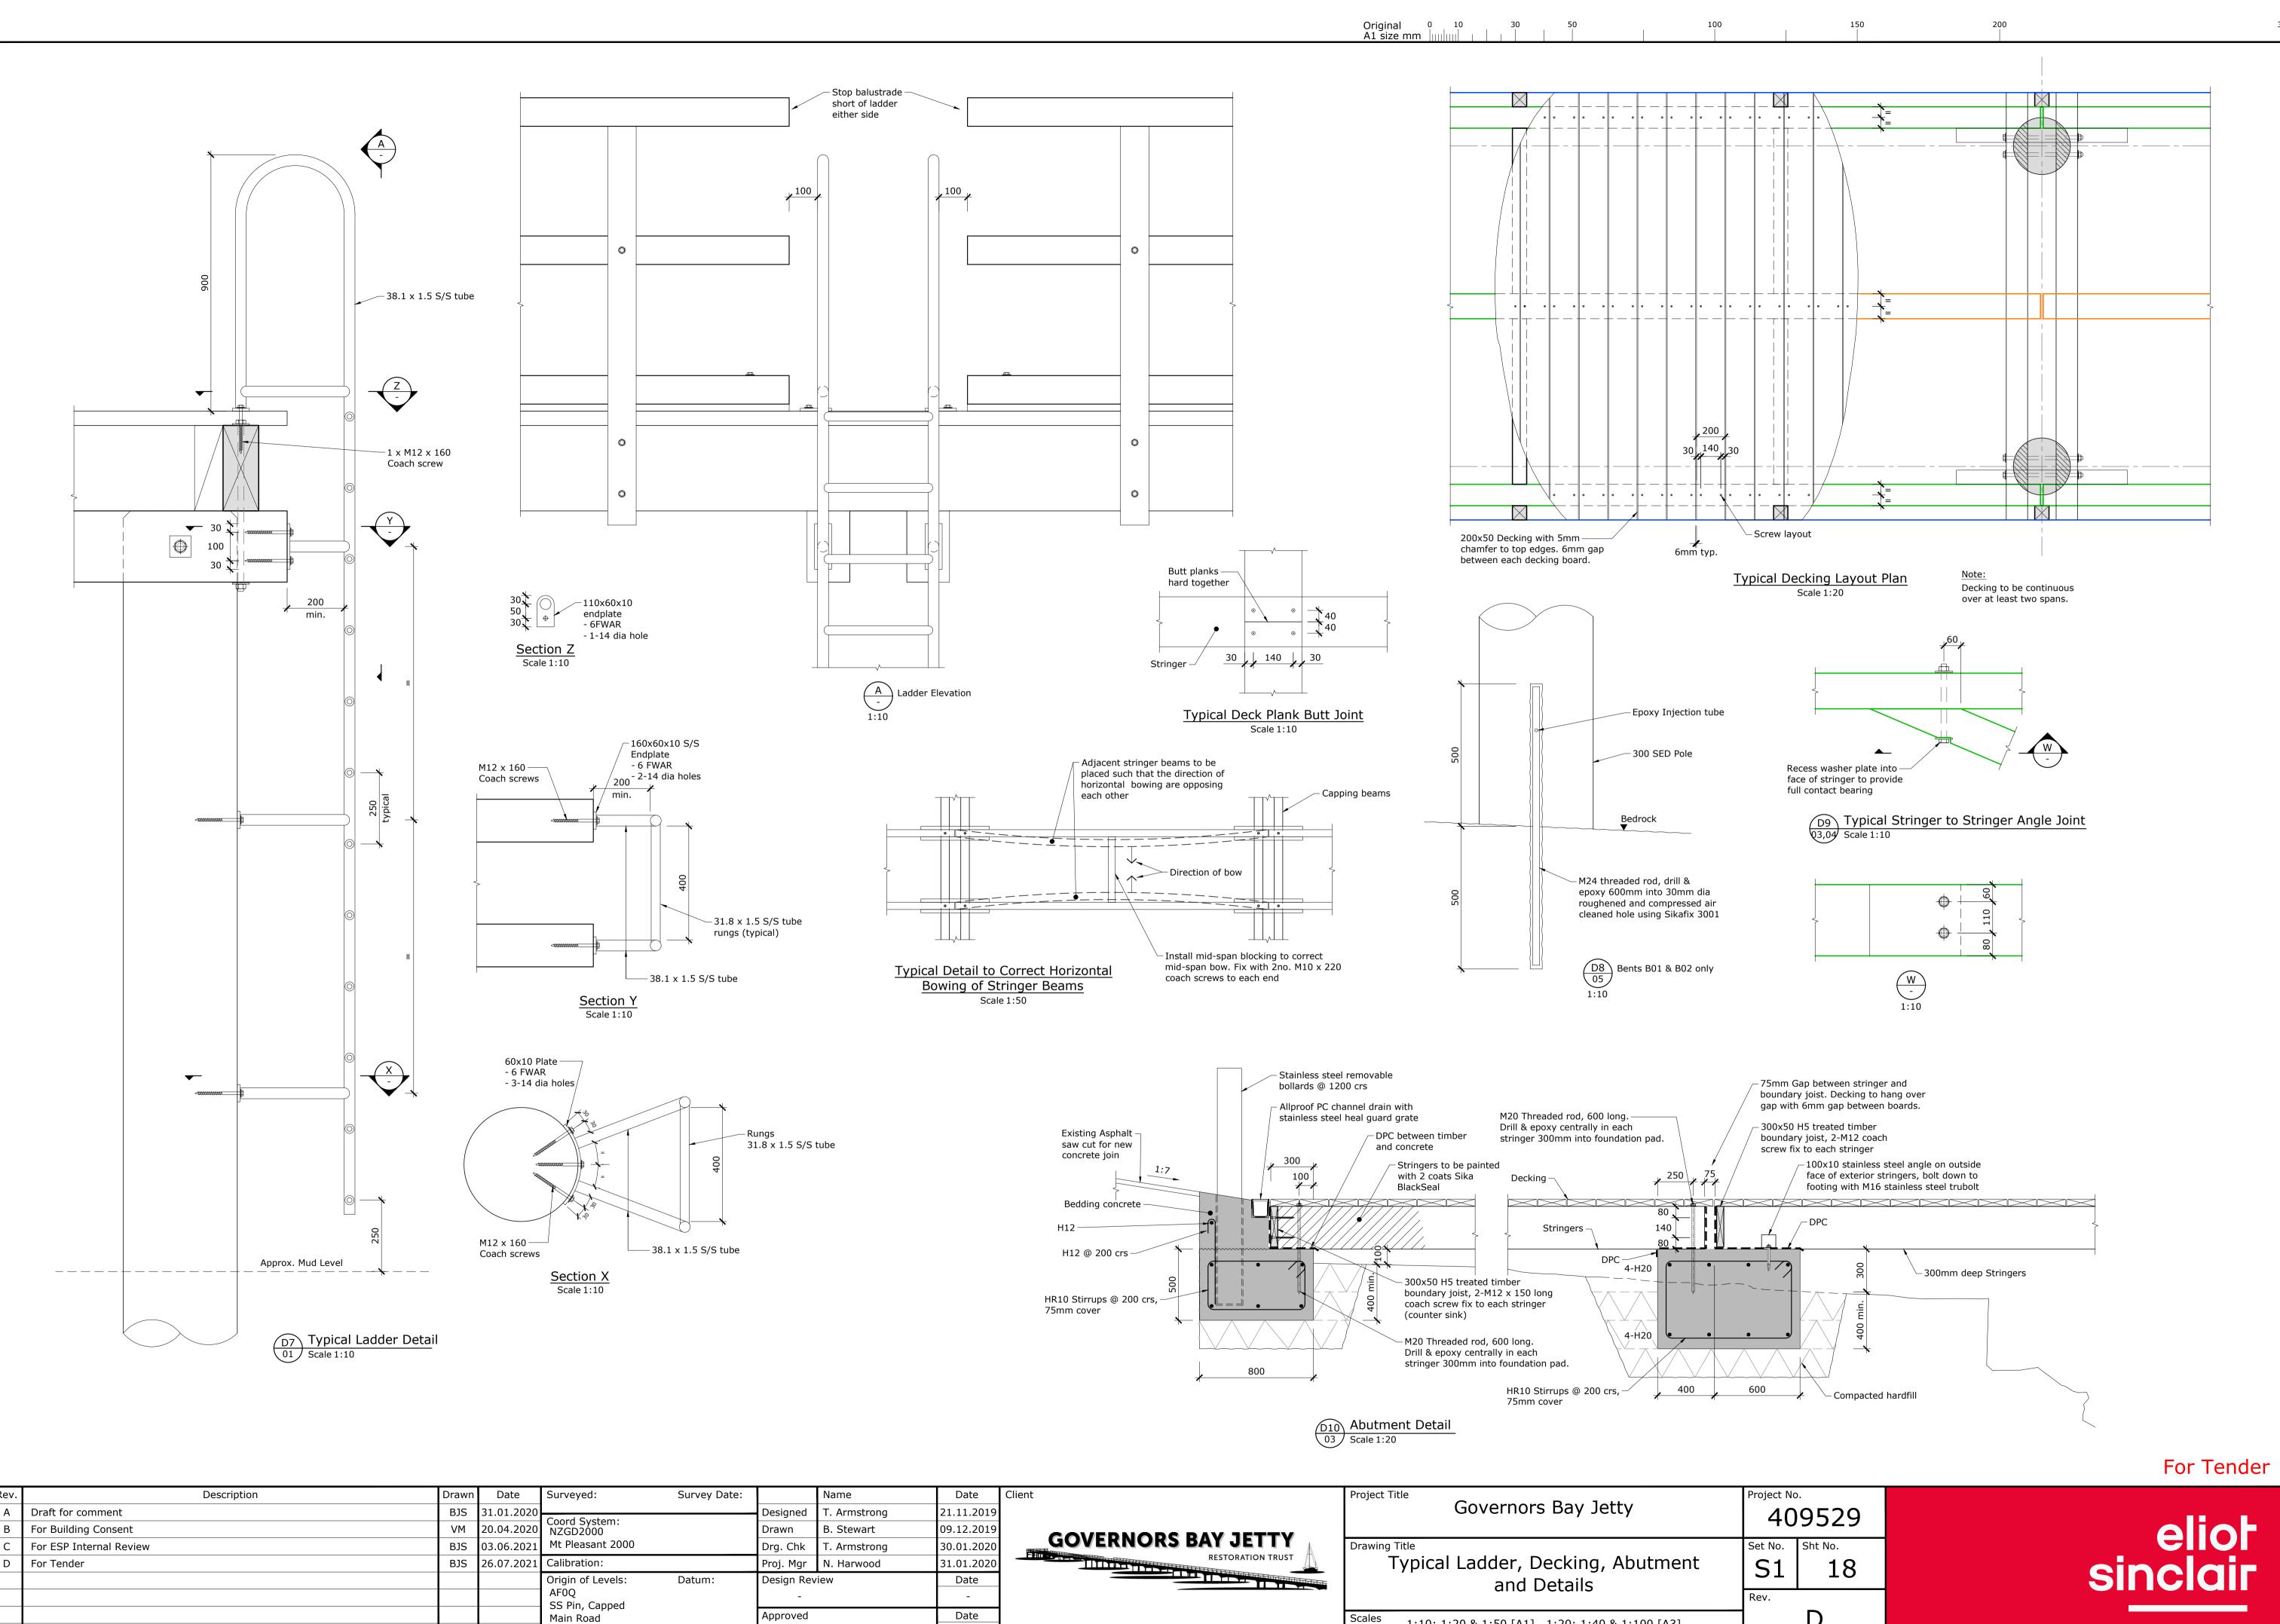
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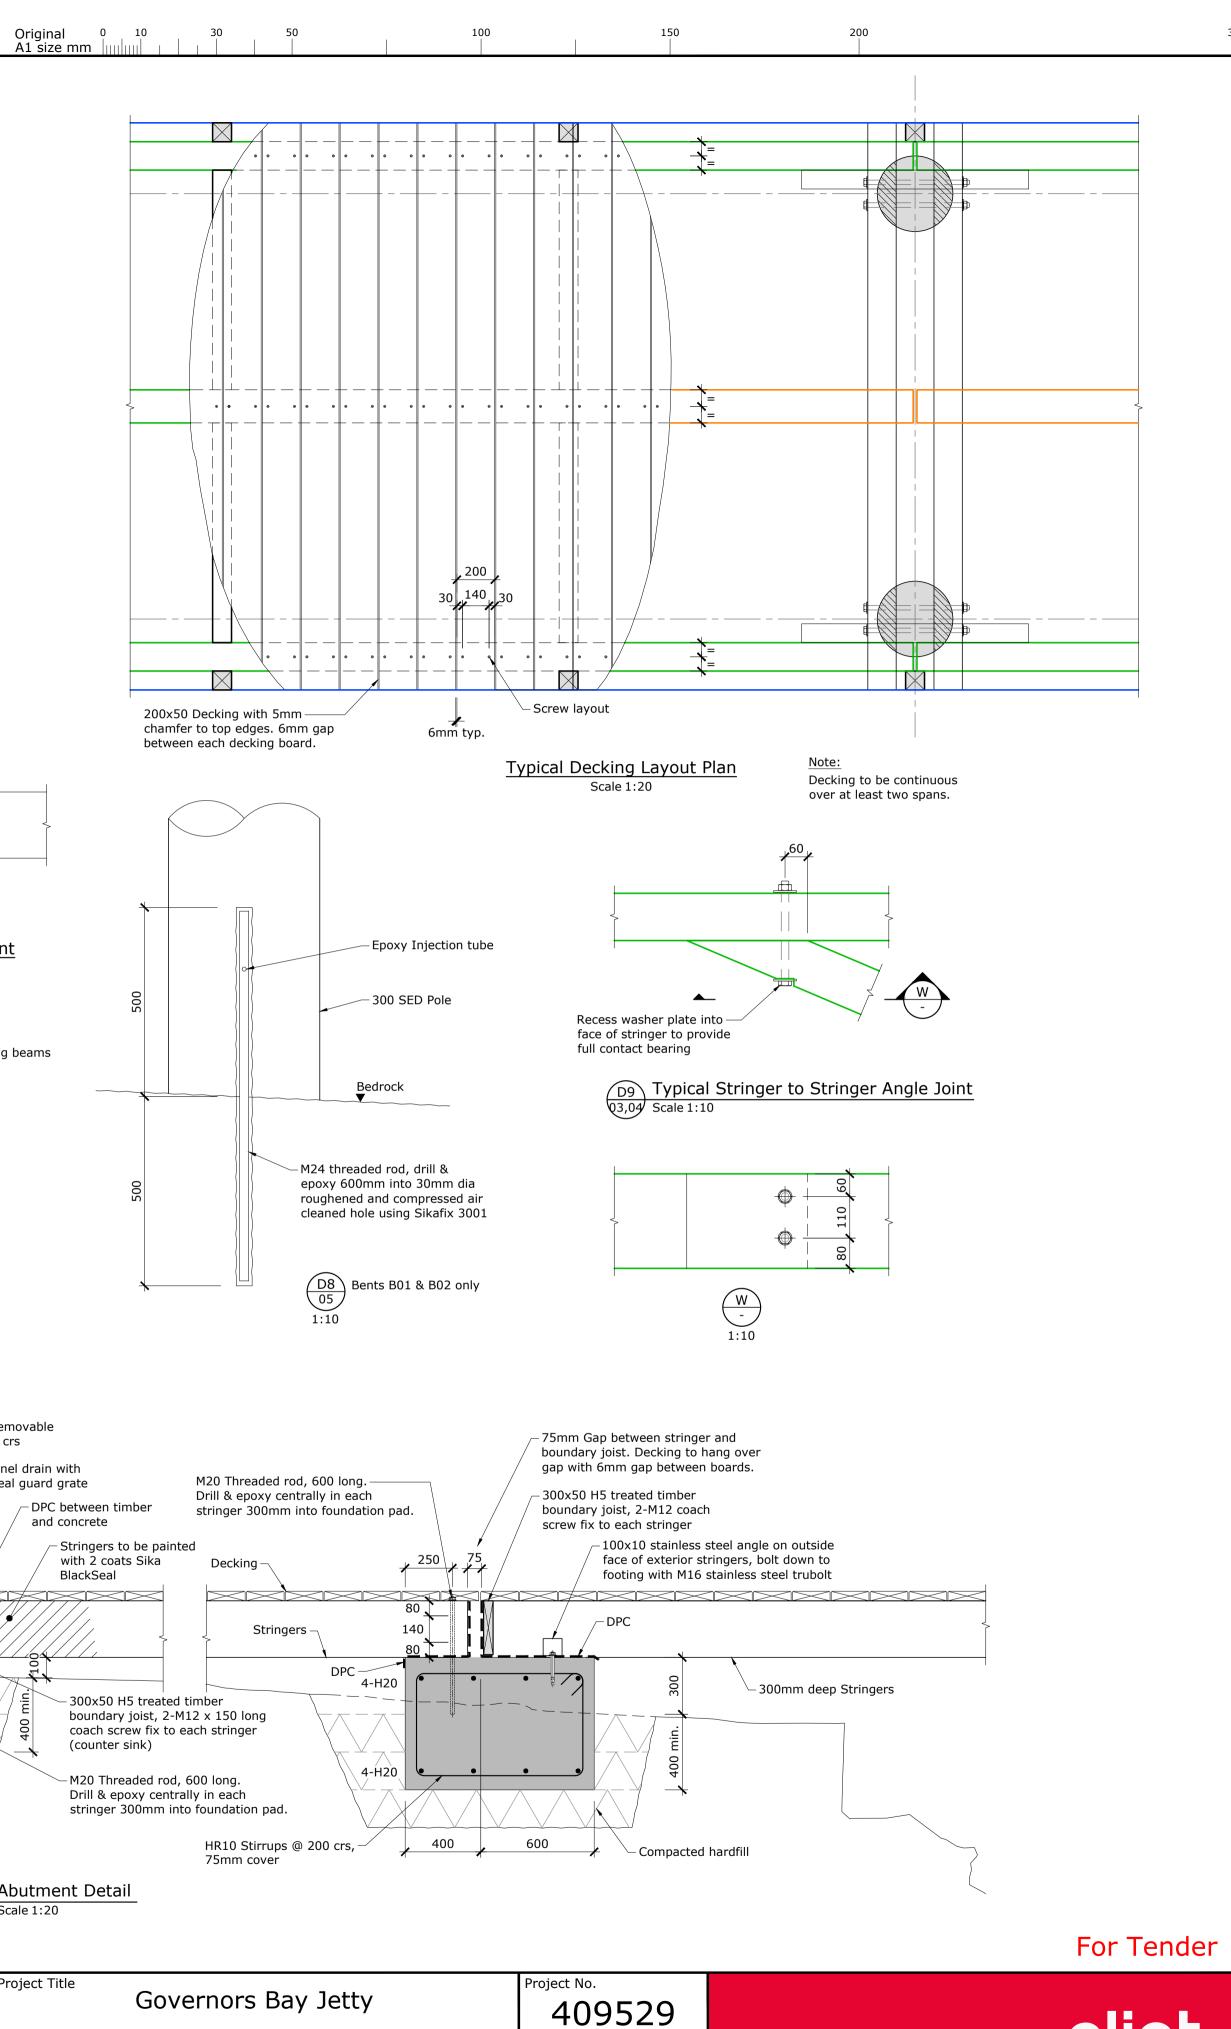




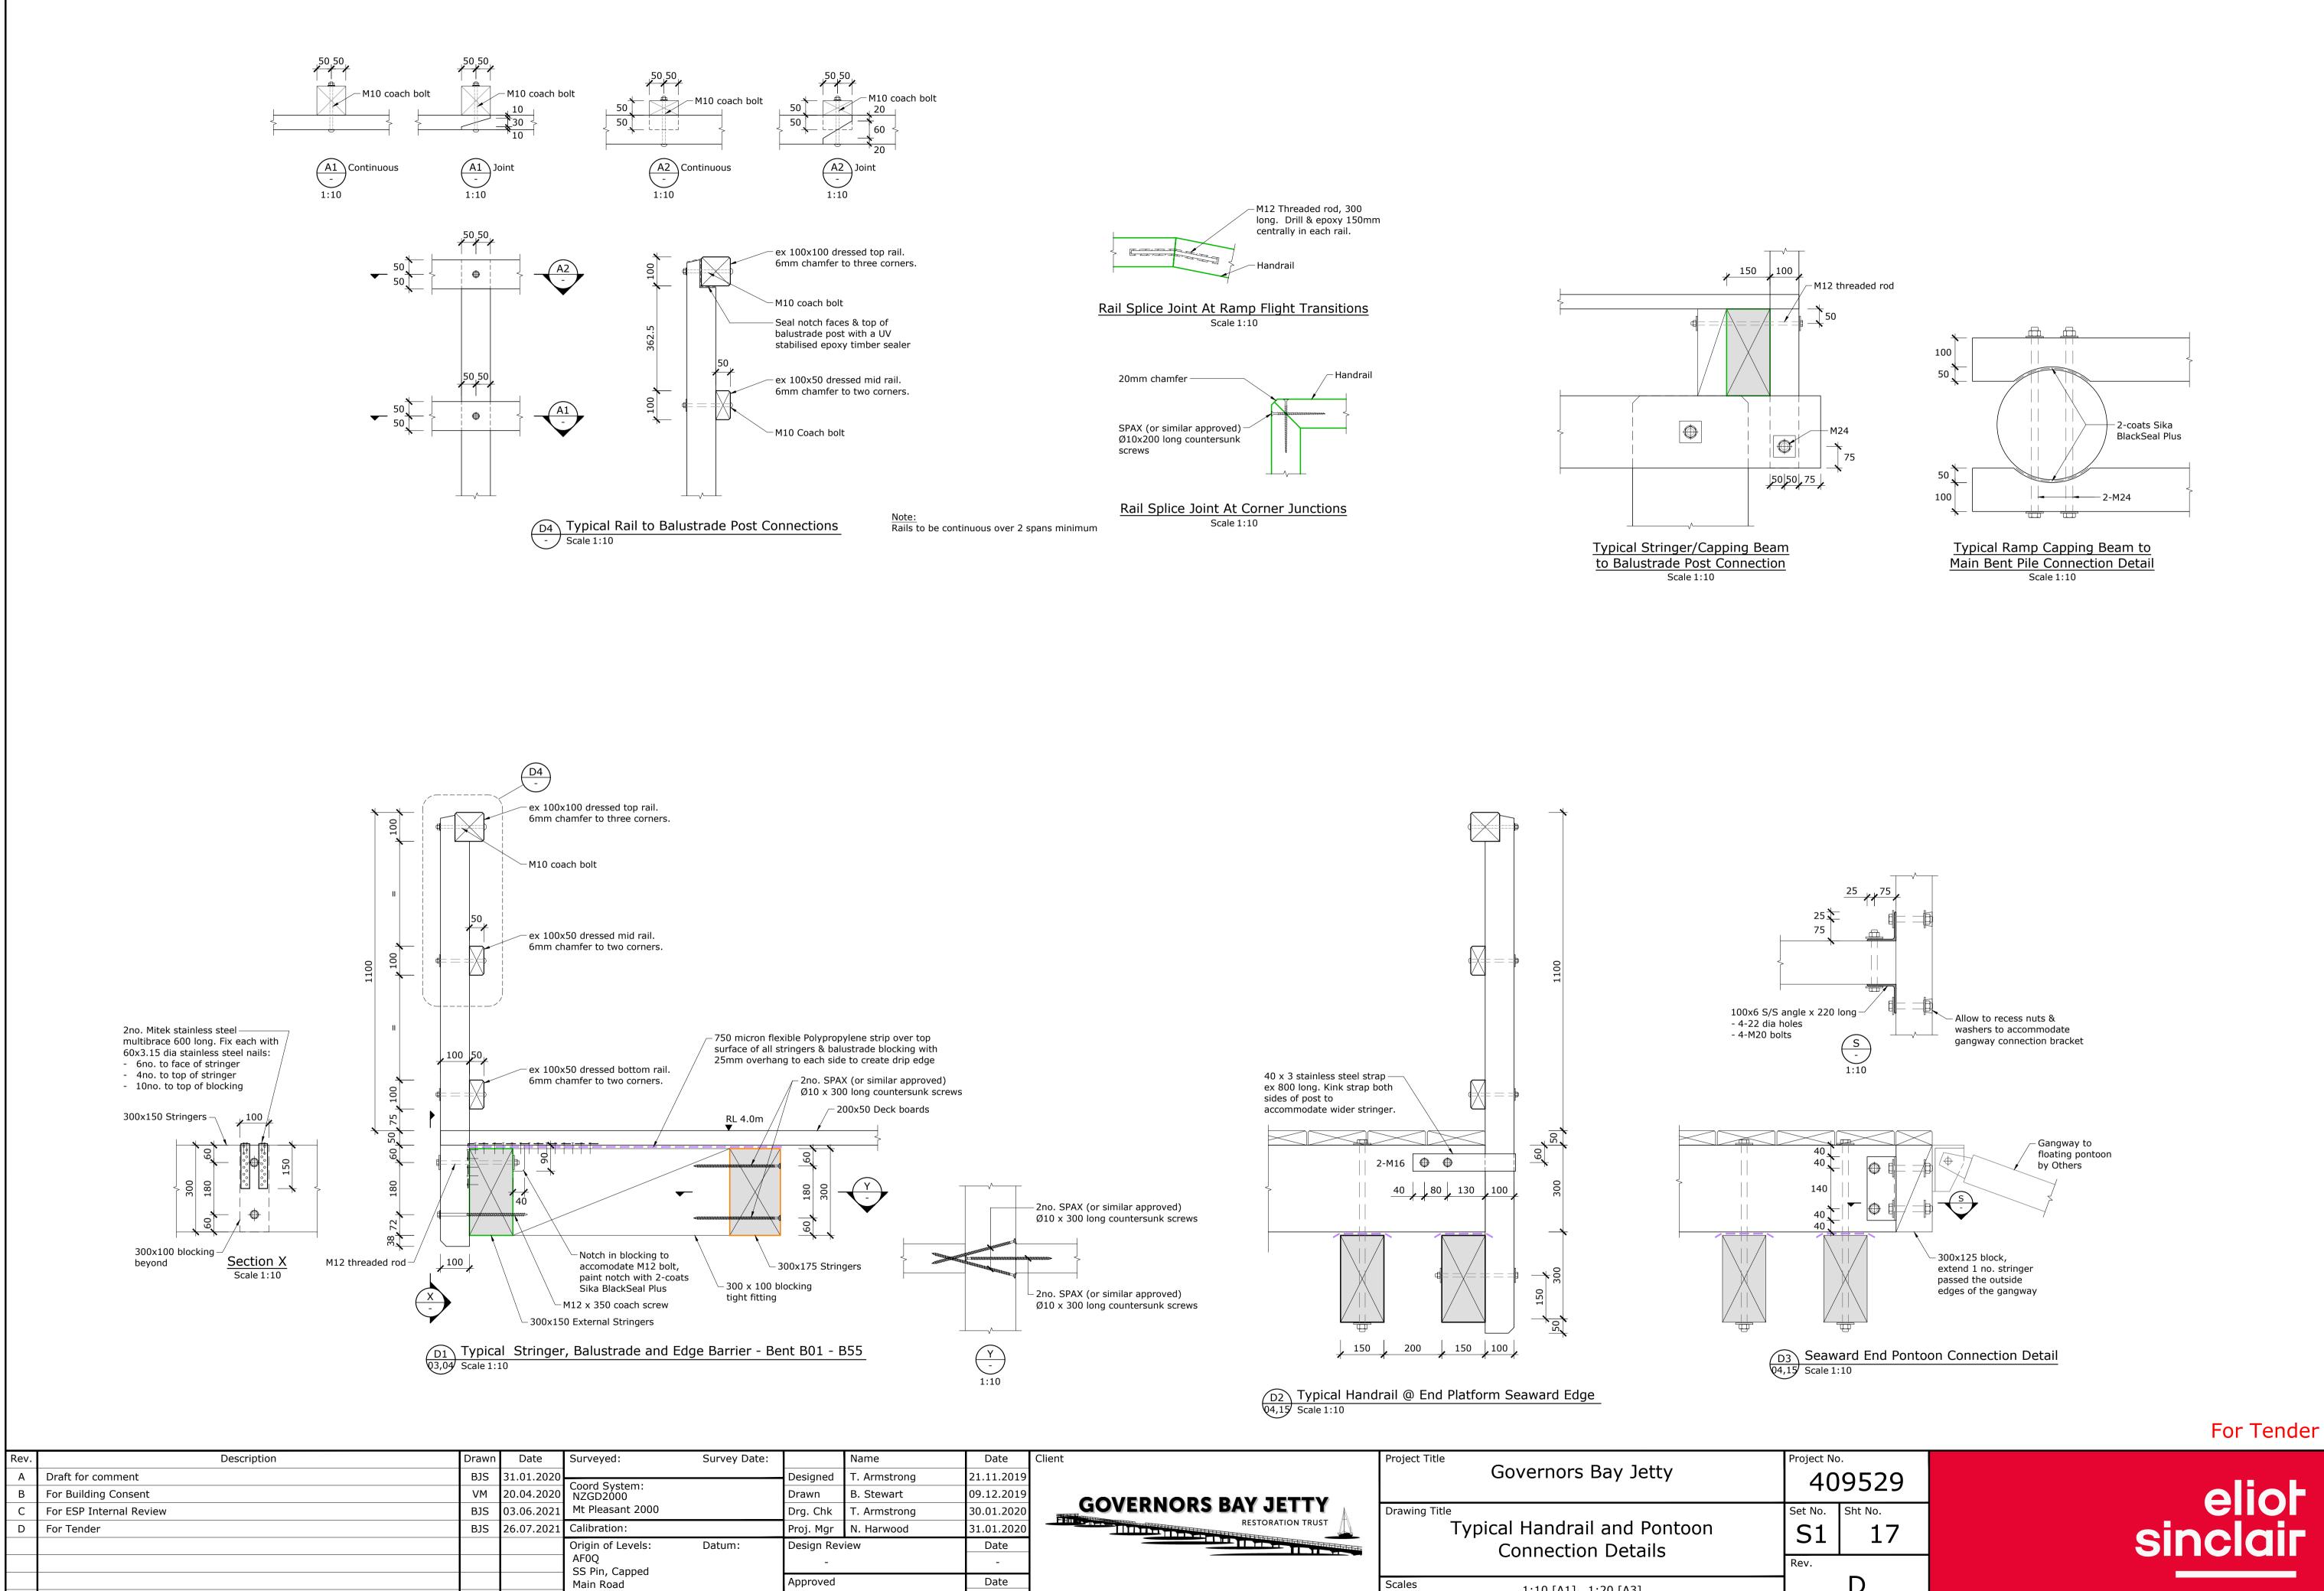



R.L. 55.085 (LINZ Dec 2013)



Scales 1:10; 1:20 & 1:50 [A1] 1:20; 1:40 & 1:100 [A3]

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