
Site Info: Wind Zone: High Earthquake Zone: 2 Exposure Zone: B Snow Loading Zone: N4	Finished Floor Level: Shall be at least 225mm above the finished level of the surrounding ground immediately adjacent to the building and no less than 150mm above the road crown on at least one cross section through the building and roadway.	General Note: - Electric cook top - Electric HWC
General Site Note: Dimensions to foundation	Heights are in terms of LVD1937. Origin B4AL V90 - 7.62m.	MB: Meter Box
Refer to foundation plan for more detailed drainage Site to be fully fenced before commencing construction,	Finished Floor level Note: FFL comply with NZBC E1/AS1 clause 2 page 33. The main contractor shall confirm all levels on site prior to works and shall ensure the finished floor level shall comply with the requirements	

clause F5/AS1 part 1

LEGAL DESCRIPTION:

Lot:532 DP: 569585 SITE AREA:424m2 AREA OVER FRAMING: 157.01 m² AREA OVER FOUNDATION: 164.55 m² ROOF AREA OVER 600MM: COMBINED SITE COVERAGE: 169.36m² TOTAL SITE COVERAGE:39.9%

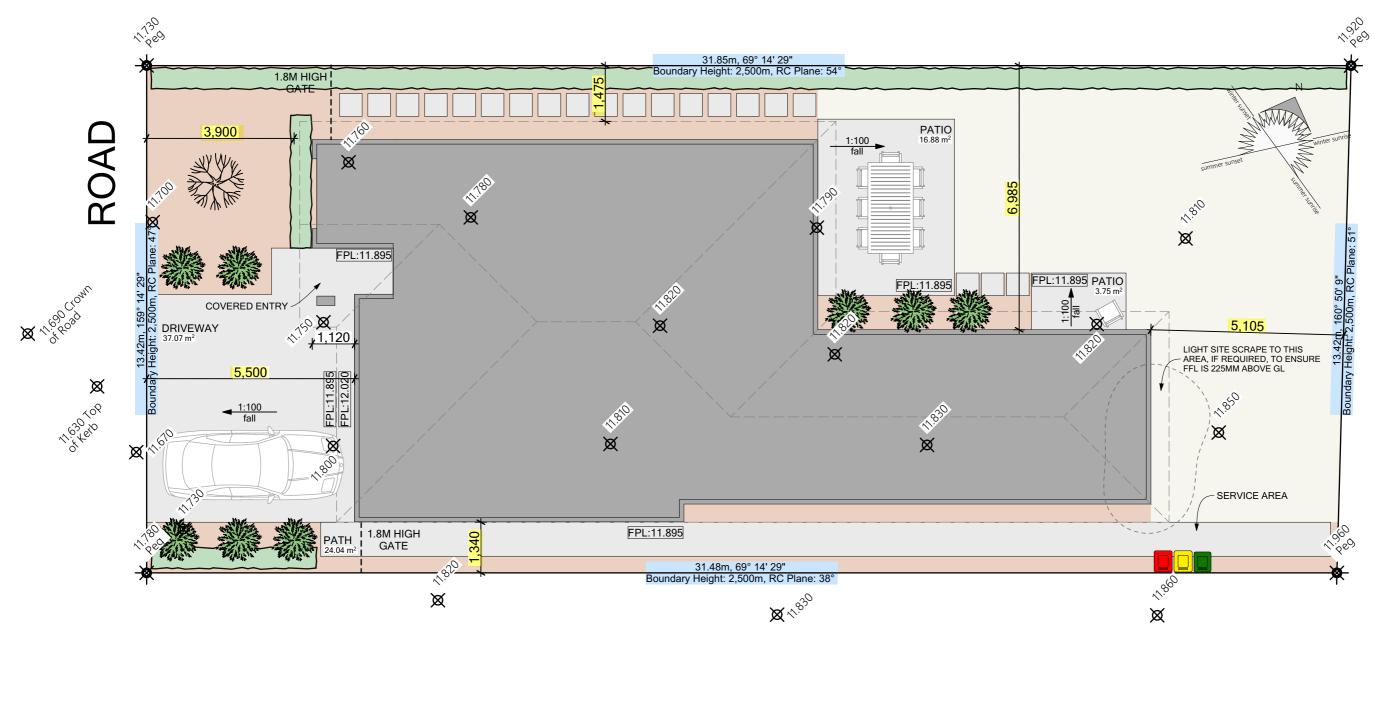



RAVENSWOOD STAGE 3D CONSENT PLANS / ISSUE 01

Sheet title: Site Plan

Scale: 1:100 @ A3 © Copyright the drawings remain the property of LMS drafting and design and may not be copied in any form or passed onto a third party without prior written approval



General Note: -Electric Solar Ready 300I HWC -Electric Hob

Antislip floor coverings on all access routes (both external and internal), to comply with NZBC D1/AS1 Table 2 (except surface areas inside entries as dry areas)

All down lights inside insulation envelope to be CA rated

Bathroom / Ensuite to have an inline auto extraction fan to provide a flow rate of at least 25I/s. The kitchen extraction fan shall provide a rate of at least 50l/s (including associated ducting)

HWC Note:

300I Hot water cylinder cylinder with seismic restraints and tempering valve set to 55°c. HWC shall be secured to the wall framing using 3/25x1mm Galv steel straps with 8mm coach screw with 30x2mm washers.Screws to penetrate framing a minimum of 50mm. Refer to supporting documents for more detail. Ensure a safetray is installed below the HWC as per the requirements of G12 AS1 NZBC section 5.2.3 page 24.


C/AS1 Compliance:

Escape routes comply with table 3.2 as they are less than 25m. External fire spread is not relevant to this project due to the separtion between the building and the boundary being over 1m and no eaves are being constructed

within 650mm of the boundary. - Smoke alarms are to be positioned within 3m of each bedroom as shown on the floor plan and lighting plan.

> CEDAR ENTRY SLATS WITH STAIN FINISH



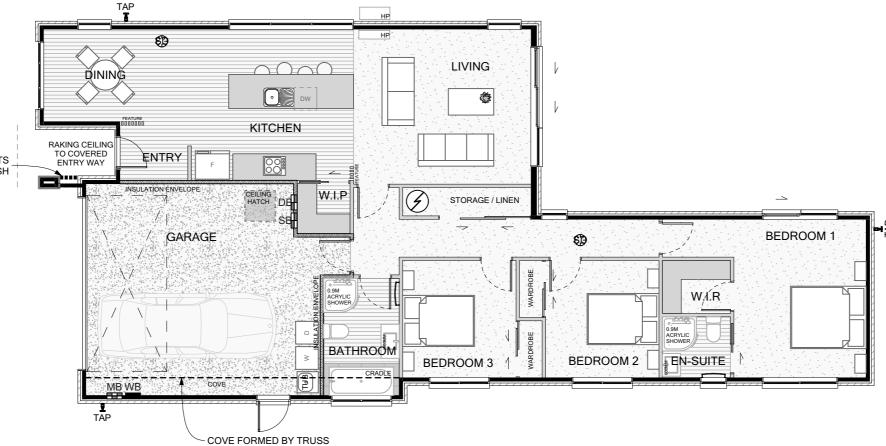

Internal Loadbearing wall: Refer to Truss manufacturer for all internal load bearing walls

Window & Door Note: Refer to window and door layout for positions

Framing Note: Refer to Sections for framing treatment & schedule All framing shall comply with NZS3604:2011.

Ceiling Access Note:

Access shall be provided to the ceiling space with an opening of at least 600mm x 500mm with 600mm in height between the top of the ceiling joist and other roof members.

Lintel Fixing Notes: Please refer to the as-built truss design for all lintel fixing requirements and sheet B005 for further information

Durability Fixing Notes: Please refer to the supporting documents at the Lumberlok durability flow chart for all fixing requirements.

All fixings shall comply with B2/AS1 and NZS3604 section 4.4



RAVENSWOOD STAGE 3D




Sheet title: Floor Plan

Scale: 1:100 @ A3 © Copyright the drawings remain the property of LMS drafting and design and may not be copied in any form or passed onto a third party without prior written approval Framing Note:

Raking entry soffit

Stud height 2.420m Double top plate height 2.455m

All dimensions to framing only, refer to drainage plan for foundation dimensions

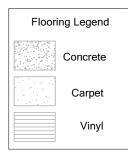






WV: Water Valve SB: Switch Board DB: Data Board HP: Heat Pump Unit SD: Smoke Detector

Smoke Alarm Note: Photoelectric smoke alarms shall be installed and have test and hush buttons to comply with F7/AS1

Kitchen Note: All surface finishes to the kitchen joinery, walls, etc. to comply with the requirements of NZBC G3. Kitchen layout to be confirmed prior to construction refer to the kitchen plan provided by others

Wet Area Waterproofing Notes: -Baths shall have a waterproofing membrane extending at least 150 mm above and beyond the top of the side and ends of the bath



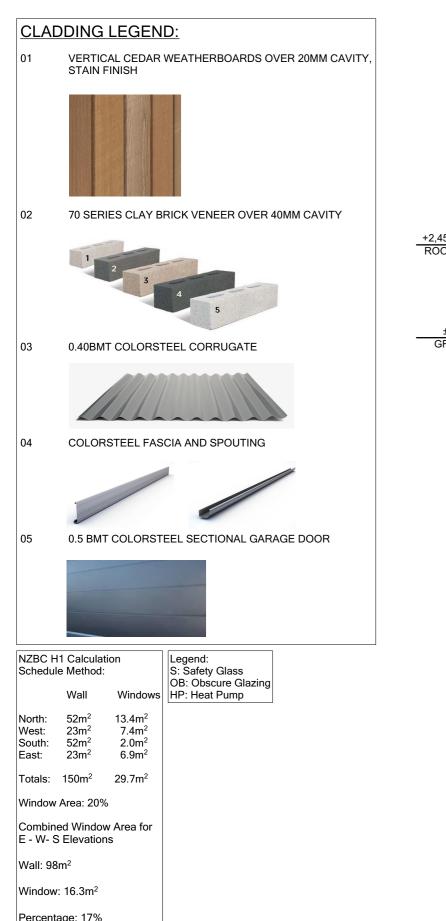

Percentage: 17% (DO NOT USE CALCULATIONS FOR CLADDING AREAS)




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BUILDING ENVELOPE RISK MATRIX				
North Elevation				
Risk Factor	Risk Severity	Risk Score		
Wind zone (per NZS 3604)	High risk	1		
Number of storeys	Low risk	0		
Roof/wall intersection design	Low risk	0		
Eaves width	High risk	2		
Envelope complexity	Medium risk	1		
Deck design	Low risk	0		
Total Risk Score:		4		

BUILDING ENVELOPE RISK MATRIX				
West Elevation				
Risk Factor	Risk Severity	Risk Score		
Wind zone (per NZS 3604)	High risk	1		
Number of storeys	Low risk	0		
Roof/wall intersection design	Low risk	0		
Eaves width	High risk	2		
Envelope complexity	Medium risk	1		
Deck design	Low risk	0		
Total Risk Score:		4		



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 DR
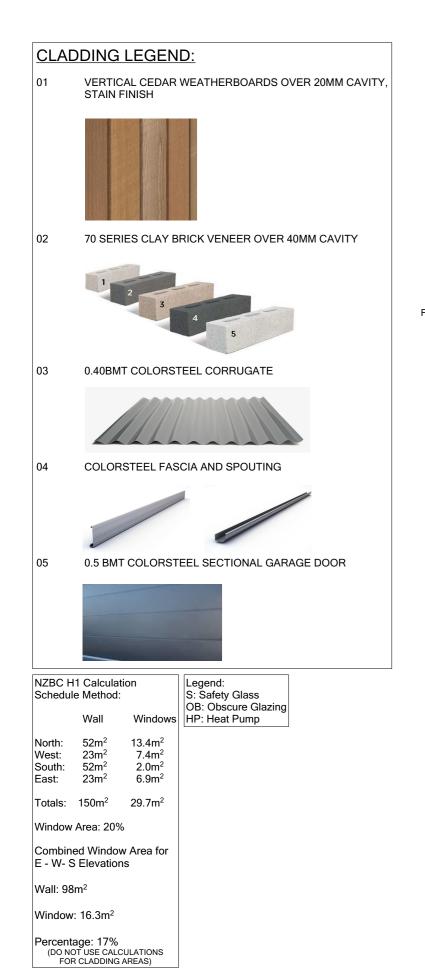
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BUILDING ENVELOPE RISK MATRIX				
South Elevation				
Risk Factor	Risk Severity	Risk Score		
Wind zone (per NZS 3604)	High risk	1		
Number of storeys	Low risk	0		
Roof/wall intersection design	Low risk	0		
Eaves width	High risk	2		
Envelope complexity	Medium risk	1		
Deck design	Low risk	0		
Total Risk Score:		4		

BUILDING ENVELOPE RISK MATRIX				
East Elevation				
Risk Factor	Risk Severity	Risk Score		
Wind zone (per NZS 3604)	High risk	1		
Number of storeys	Low risk	0		
Roof/wall intersection design	Low risk	0		
Eaves width	High risk	2		
Envelope complexity	Medium risk	1		
Deck design	Low risk	0		
Total Risk Score:		4		