





R19015 - Chalmers Street Apartments 20 Chalmers Street Wanaka 9305 Building Consent

Sheet Index

Sheet	Sheet Name	Rev
000	Cover	-
001	Notes & Legends	Α
101	Site Plan	-
201	L0 Foundation Plan	-
202	L1 Foundation Plan	Α
203	L2 Plumbing Plan	Α
204	L0 Basement Plan	Α
205	L1 Ground Floor Plan	-
206	L2 First Floor Plan	-
207	L1 Roof Plan	Α
208	L2 Roof Plan	Α
209	L0 Reflected Ceiling Plan	-
210	L1 Reflected Ceiling Plan	Α
211	L2 Reflected Ceiling Plan	Α
212	L0 Electrical Plan	-
213	L1 Electrical Plan	Α
214	L2 Electrical Plan	Α
301	Elevations	Α
401	Section A	-
402	Section B	-
403	Section C	Α
404	Section C Continued	-
405	Section D	Α
406	Section E	Α
407	Section F	Α
408	Section F Continued	-
409	Section G	_
410	Section H	-
411	Section H Continued	-
412	Section I	Α
413	Section I Continued	Α
414	Section J	Α
415	Section J Continued	Α
501	Details	-
502	Details	-
503	Details	-
504	Details	Α
505	Details	-
506	Details	Α
507	Details	Α
508	Details	Α
509	Details	Α
601	Window & Door Schedule	-
602	Window & Door Schedule	-
603	Window & Door Schedule	-

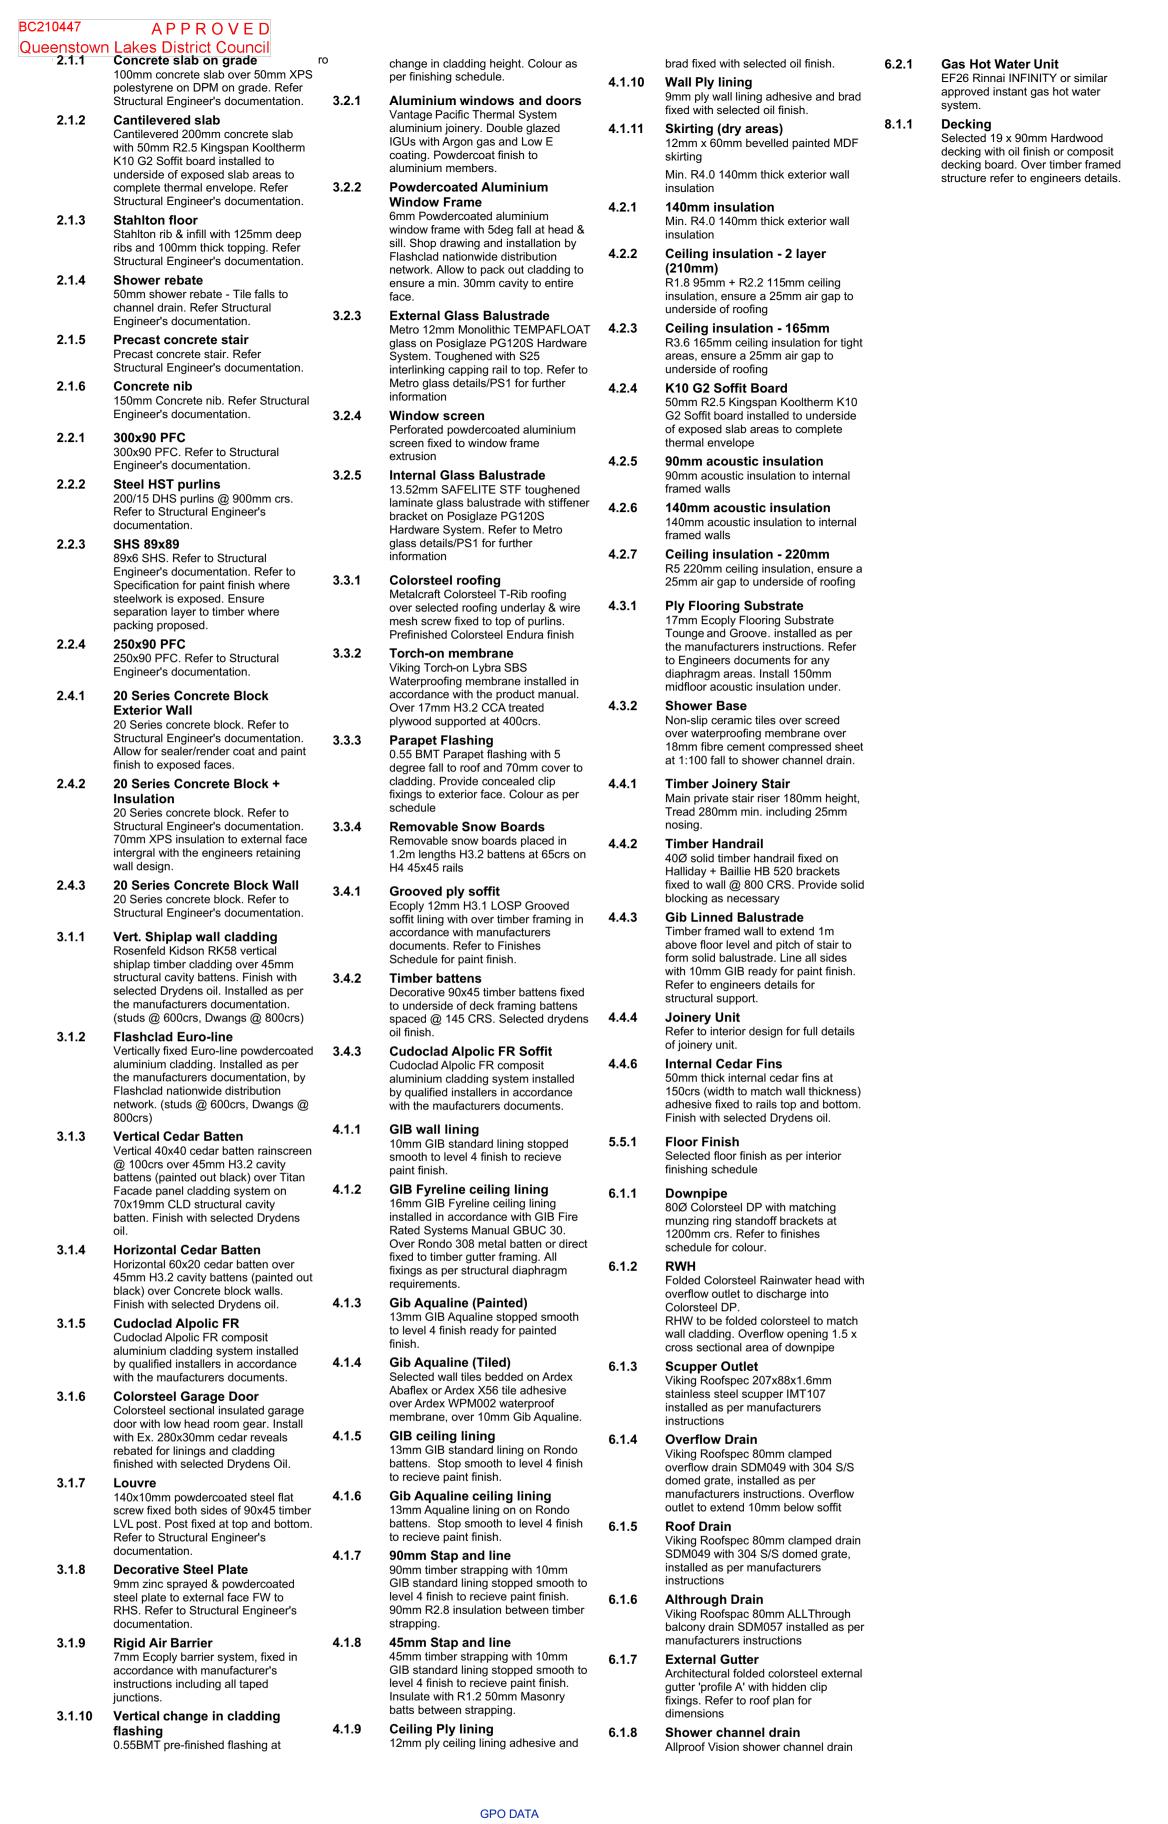

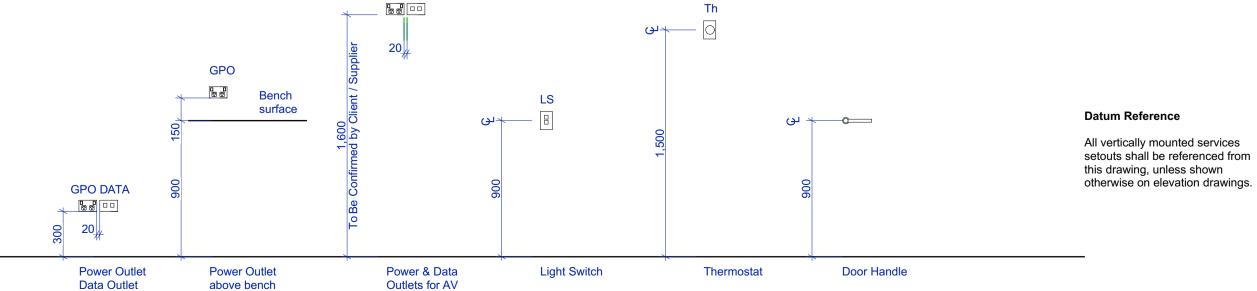

Building Consent

Notes

All dimensions shall be verified on site by the contractor before starting any work or ordering any materials.
All work must comply with NZS 3604 2011 and the New Zealand Building Code.

 Rev:
 Date:
 Issue:

 16/04/2021
 Building Consent Issue

Three Sixty Architecture



Chalmers Street
Apartments
20 Chalmers Street
Wanaka

Notes & Legends


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File No. R19015
Date 9/06/2021
Revision A

Sheet No.

001

Thee Sixty Architects Limited Level 1, The Yard 173 St Asaph Street Christchurch 8140

t: 03 366 3349

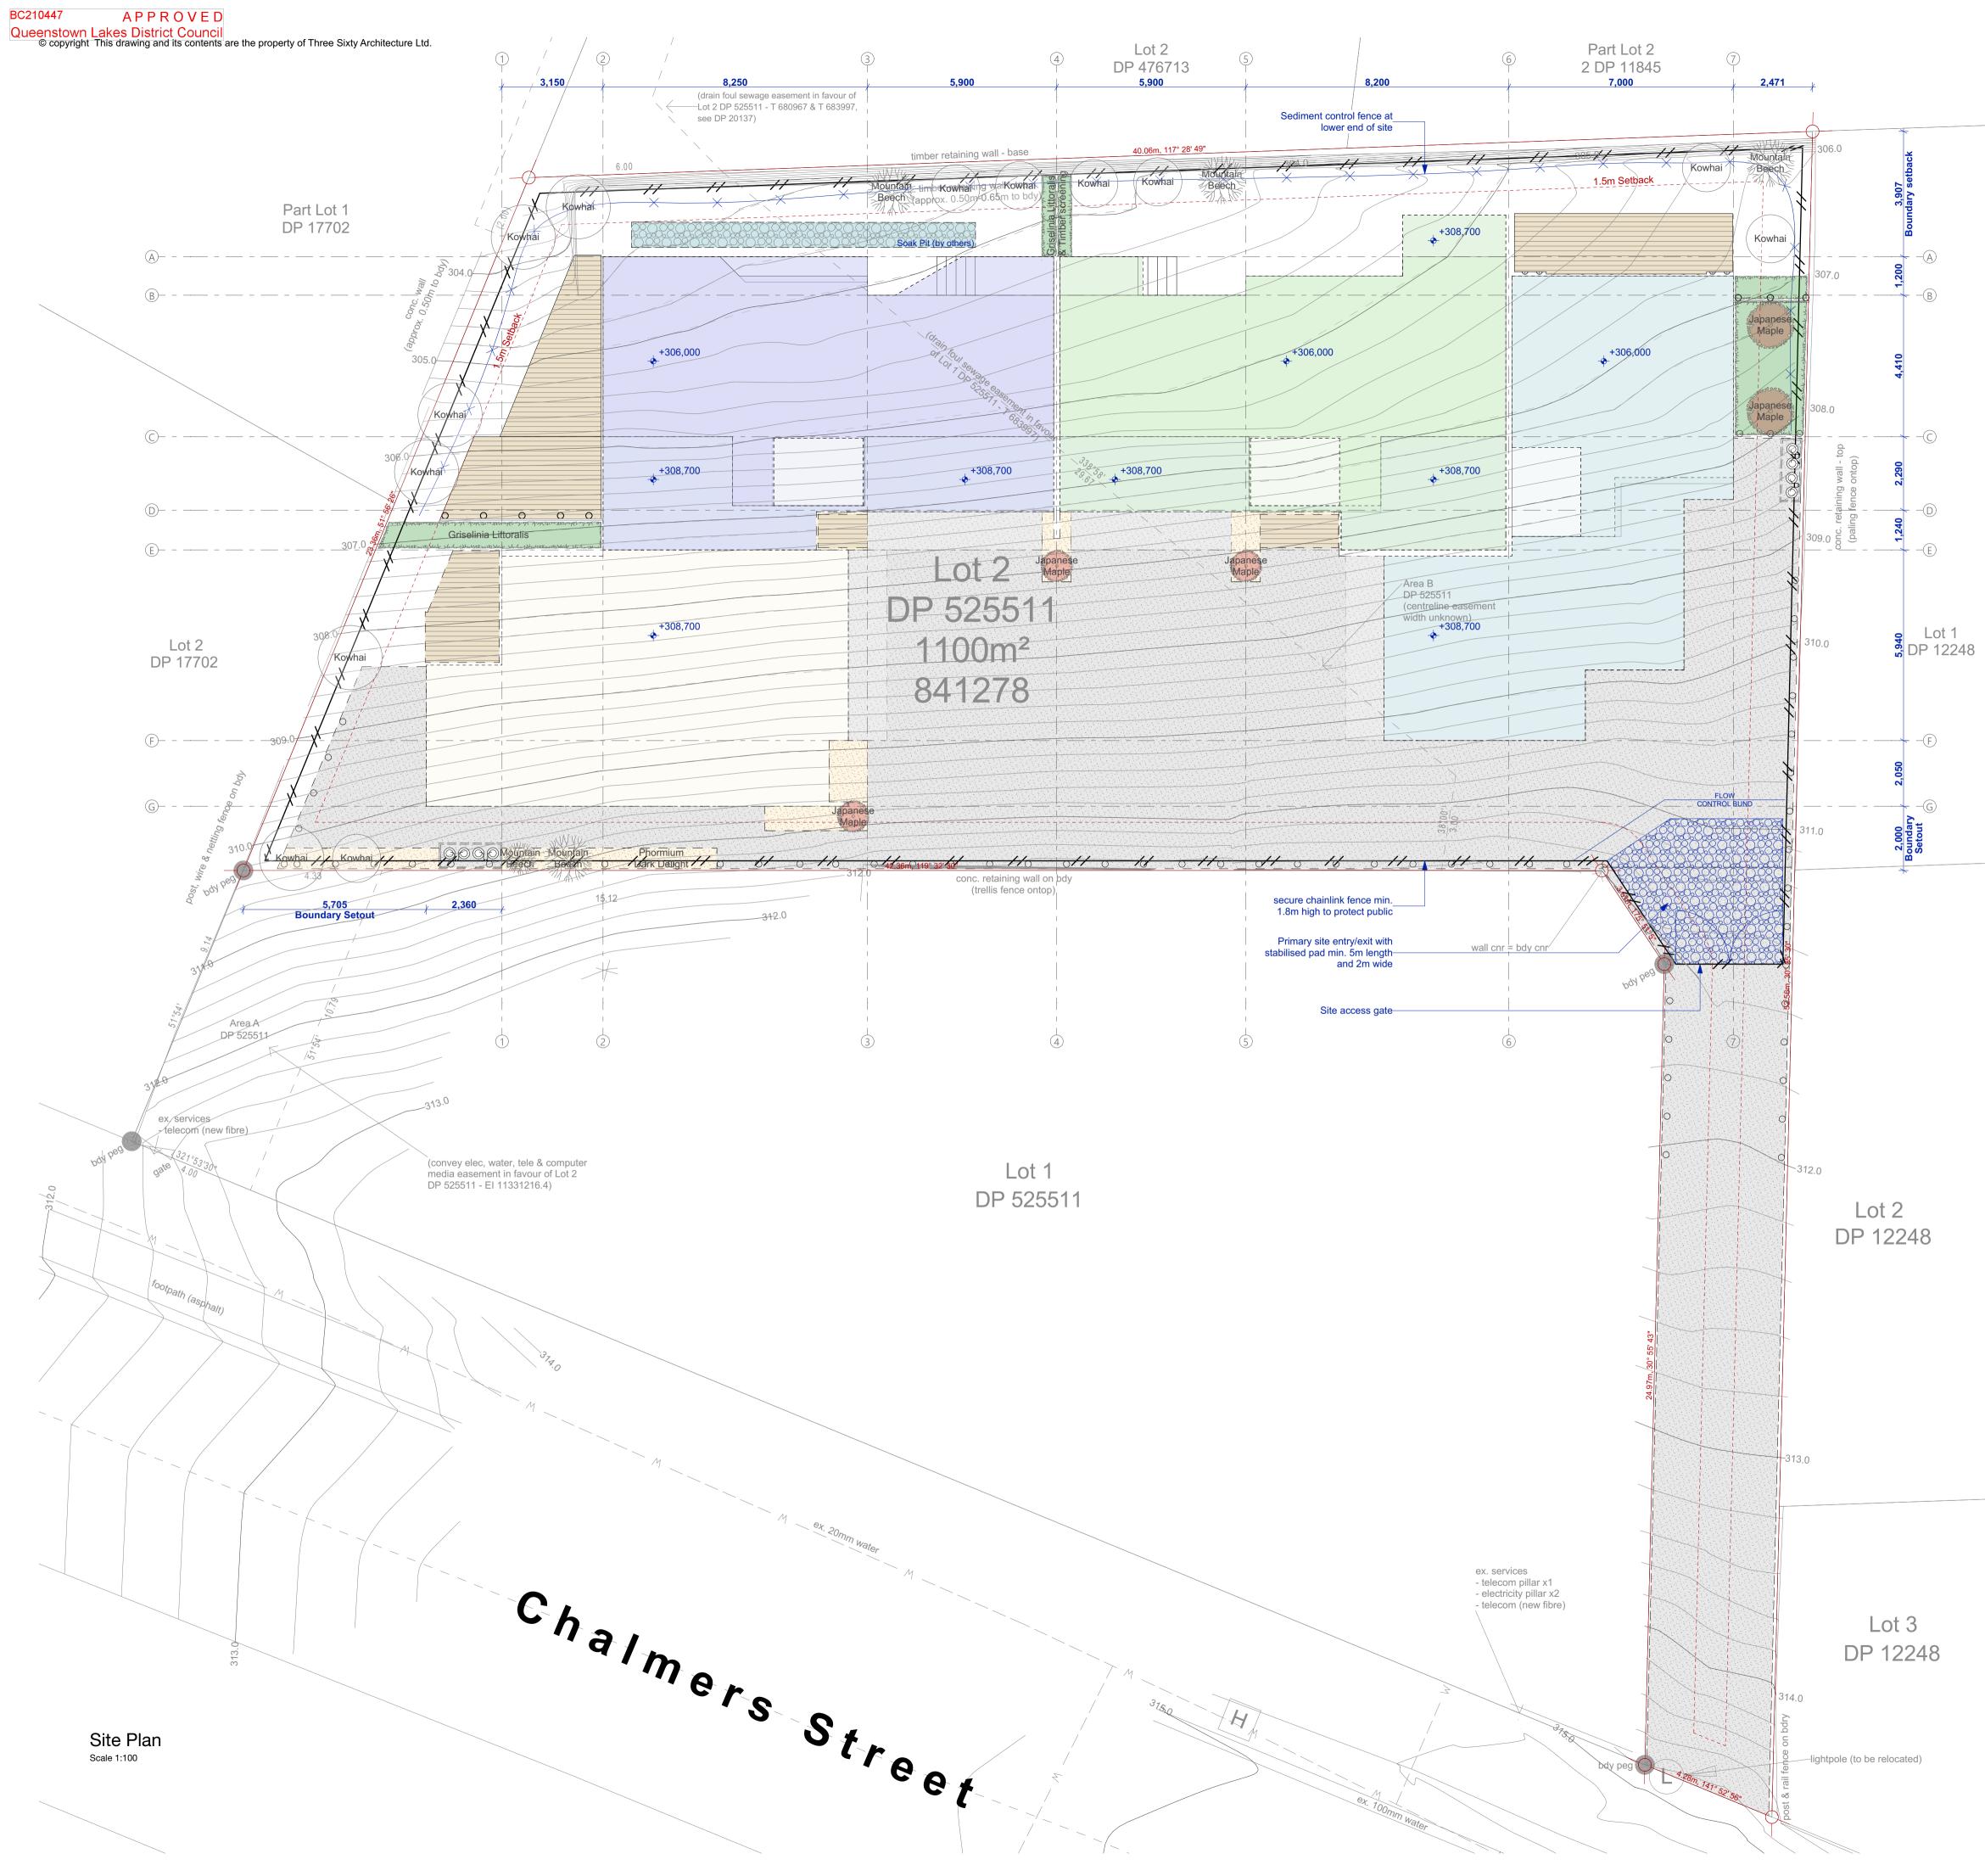



All dimensions shall be verified on site by the contractor before starting any work or ordering any materials.
All work must comply with NZS 3604 2011 and the New Zealand Building Code.

Site description

Legal Description: Lot:2 DP:525511 Address: 20 Chalmers Street Wanaka 9305

0 1 2 3 4 5

1100 m². Site Area: Building Footprint: 443 m². Site Coverage: 50% Wind Zone: Medium Earthquake Zone: 3 Corrosion Zone: B

Climate Zone: 3 Rainfall Intensity: 20-30mm Snow Zone: N5 Planning Zone: Medium Residential Zone

Sediment Control Plan

- 1. The site manager is responsible for ensuring compliance with this management plan during the entire construction period
- 2. Sediment control measures are intended to remove coarse silt and debris from storm water runoff leaving the site. The effectiveness of the measures is to be reviewed immediately after rain or at least weekly by the site manager and if necessary further controls put in place to prevent excess sediment or rubbish from entering the public storm water system
- 3. Expected control measures are shown on this plan
- Vehicle access trips are located at the proposed entranceways and are to be constructed as detailed in the Local Authorities sediment control guide line. Silt control fences if required are detailed on the drawing. If necessary shallow trenches are to be cut along the site boundaries to direct all storm water runoff to within the catch areas created by the vehicle access strips or silt control fences
- 5. All vehicles entering the site are to use the proposed vehicle crossings dug out and back filled as detailed in the Local Authorities sediment control guide lines. Any soil or debris deposited on areas outside of the site boundary is to be properly removed to within the site.

Public Safety & Security

- Provide full height fencing to all sides of the construction site. Liaise with neighbours to secure existing boundary fences where undersized.
- Provide temporary site access gate as shown on the plan and secure storage set up clear of new work site. Allow to maintain secure access through project.

- 1. The site falls to the North where the ROW located to the South. Sediment control to be located as shown to collect as much runoff as practical. Ensure all building debris is removed from site upon completion.
- Refer to engineers drawings regarding specific designs of retaining structures, excavations and soak pitts.
- 3. Refer to approved Resource Consent conditions. Reference: RM200499. Note all excavation, geotechnical and landscaping requirements are to be met during construction.

Location Plan

Scale: NTS

Scale @ A1 1:100 File No. R19015 9/06/2021 Revision

Chalmers Street

20 Chalmers Street

Apartments

Wanaka

Site Plan

Three


Architecture

Sixty

101

Thee Sixty Architects Limited Level 1, The Yard 173 St Asaph Street Christchurch 8140

t: 03 366 3349

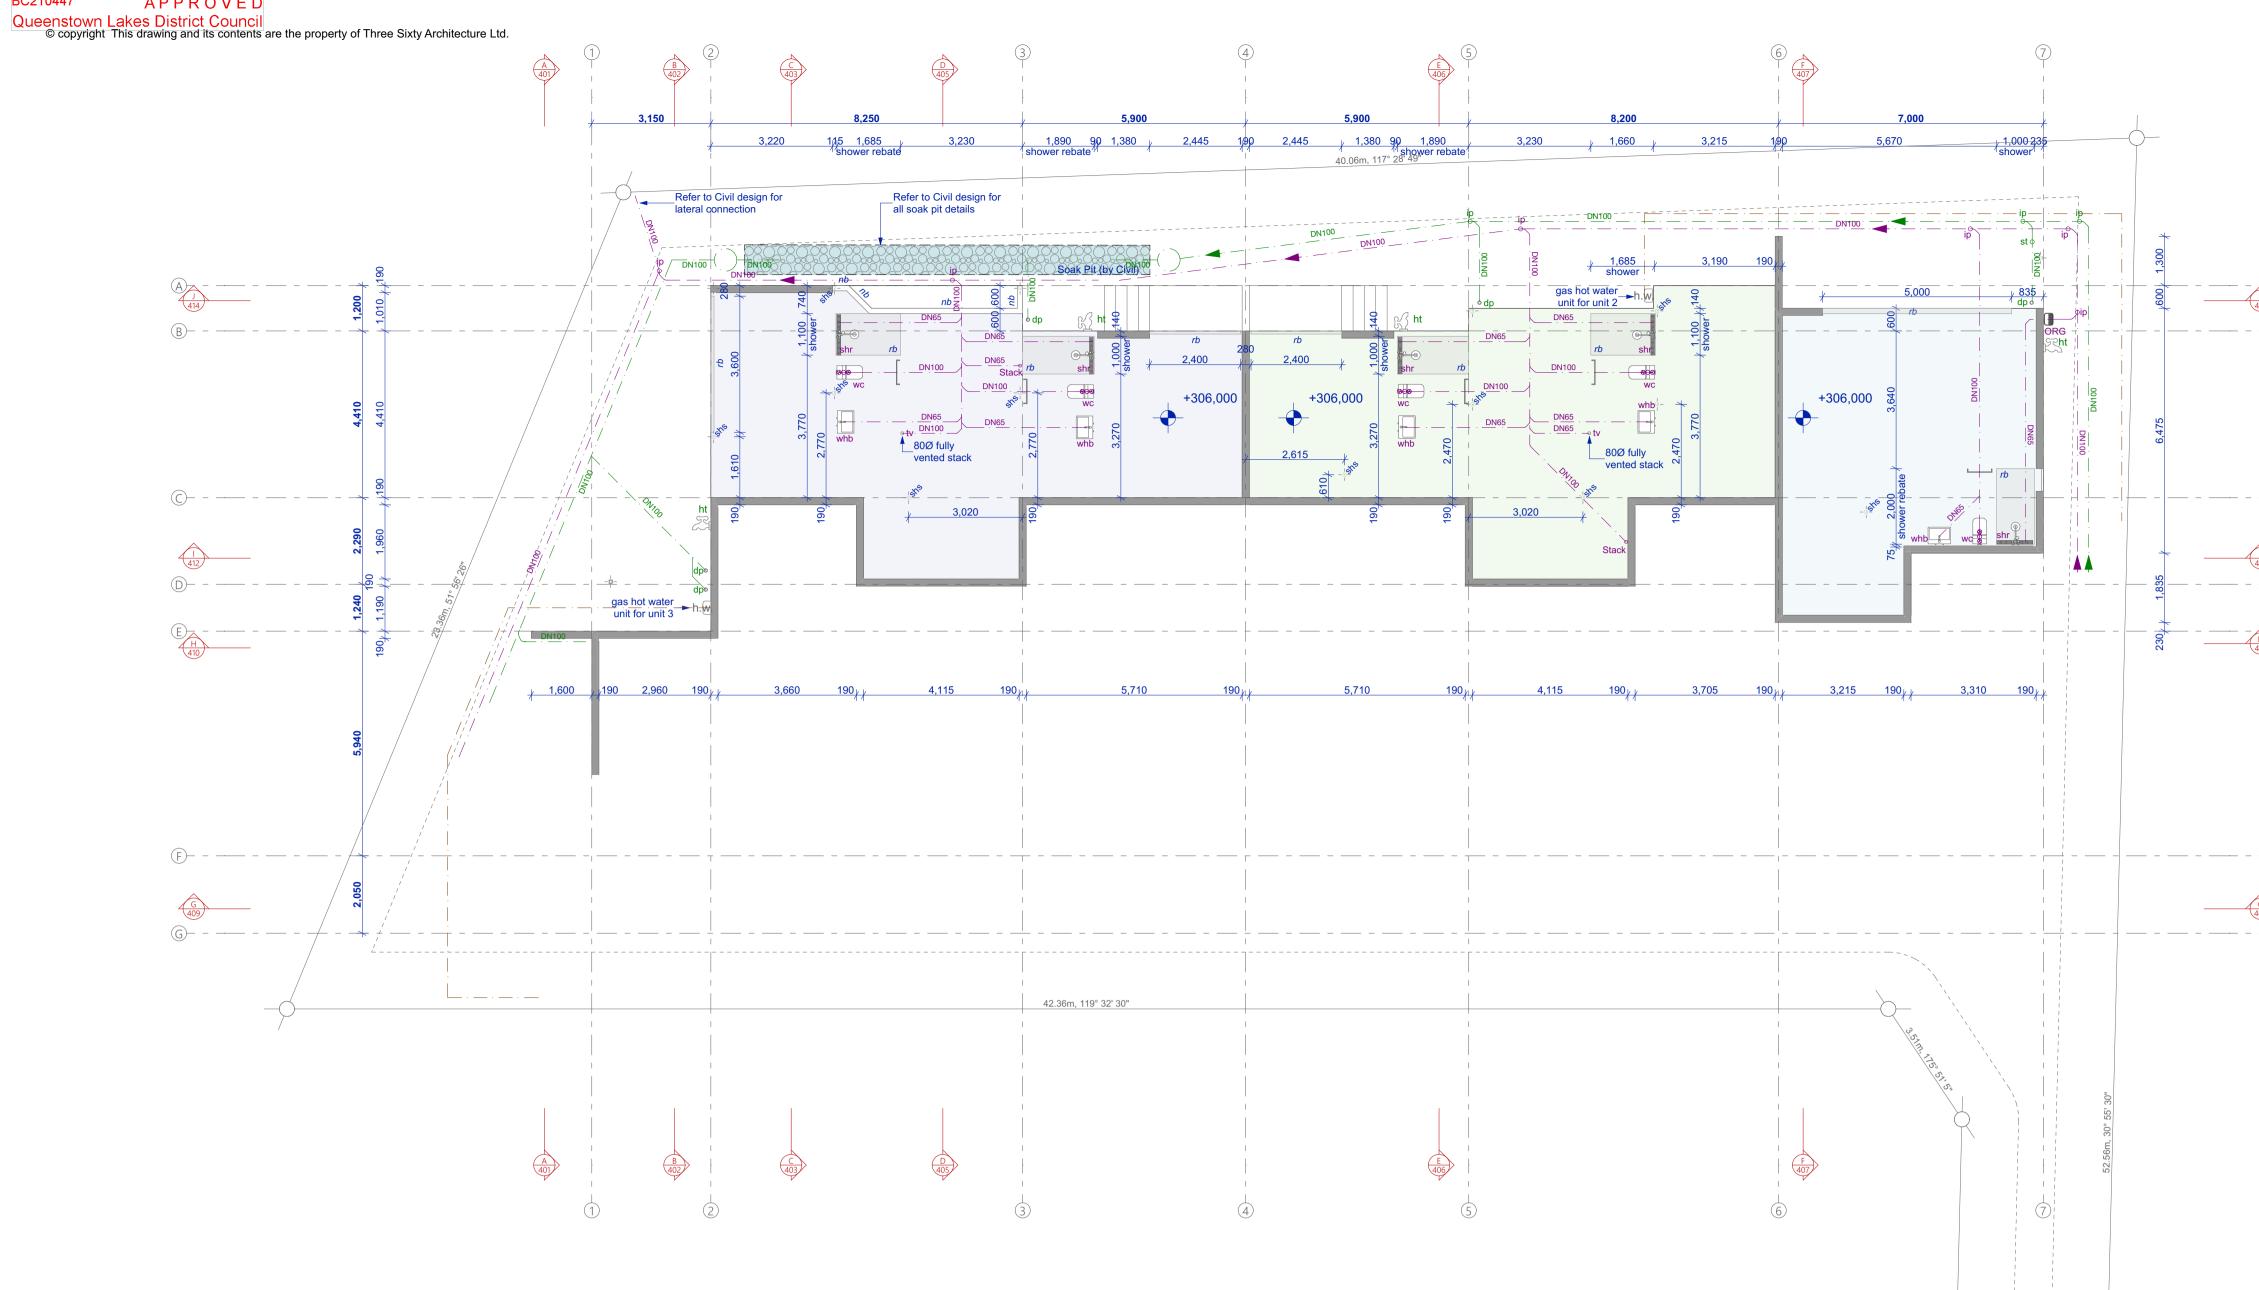

L0 Foundation Plan

0 1 2 3 4 5

Plumbing line types

Gas line

Water supply — — W — —

SW uPVC ø100 mm 1:120 min SS uPVC ø100 mm 1:60 min

Above slab In/below slab whb W/hand basin DN40 1:40 DN65 1:40 sink Sink bath Bath DN50 1:40 DN65 1:40 DN50 1:40 DN65 1:40 shr Shower DN50 1:40 DN65 1:40 wc WC toilet DN80 1:60 DN100 1:60 tv Terminal vent DN80 io Inspection DN40 ht Hose tap st Silt trap Main drains DN100 1:60

nb 150mm high concrete nib wall

rb rebate in floor

Plumbing notes: All materials, workmanship and design of sanitary plumbing and drainage to the following:

AS/NZS3500.1 (water supply) AS/NZS3500.2 (sanitary) AS/NZS3500.3 (stormwater) AS/NZS3500.4 (hot water).

Note: as an alternative to venting all fittings back to terminal vent, air admittance valves may be installed to all fittings.

Note: 20mm condensate drain pipe from ghw be fitted with vacuum break device on waste pipe connected into nearest fixture waste complete with air gap as per AS/NZS3500.4 (refer to product specifications)

Min temperature of cylinder to be 60° degrees Celsius. Limit water temperature to 55° degrees Celsius via a tempering valve where hot water is supplied to sanitary fittings used for personal hygiene all to comply with AS/NZS3500.4.

Slab notes:

Slab thickenings as per engineers documents

Structural steel posts to be rebated into slab as detailed by engineer.

Tiled showers to have 50mm rebate into slab to allow for mortar fill with tiles over to form required falls to outlets.

Liaise with electrical & hvac contractor for underground or in slab conduit for electrical cabling and hvac ducting.

Drainage notes:

Allow to check all levels on site prior to

Read in conjunction with slab and footing

Building Consent

All dimensions shall be verified on site by the contractor

before starting any work or ordering any materials.
All work must comply with NZS 3604 2011 and the New Zealand Building Code. Issue: Building Consent Issue

Three Sixty Architecture



Chalmers Street Apartments 20 Chalmers Street Wanaka

L0 Foundation Plan


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Sheet No.

201

Thee Sixty Architects Limited Level 1, The Yard 173 St Asaph Street Christchurch 8140


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L1 Foundation Plan

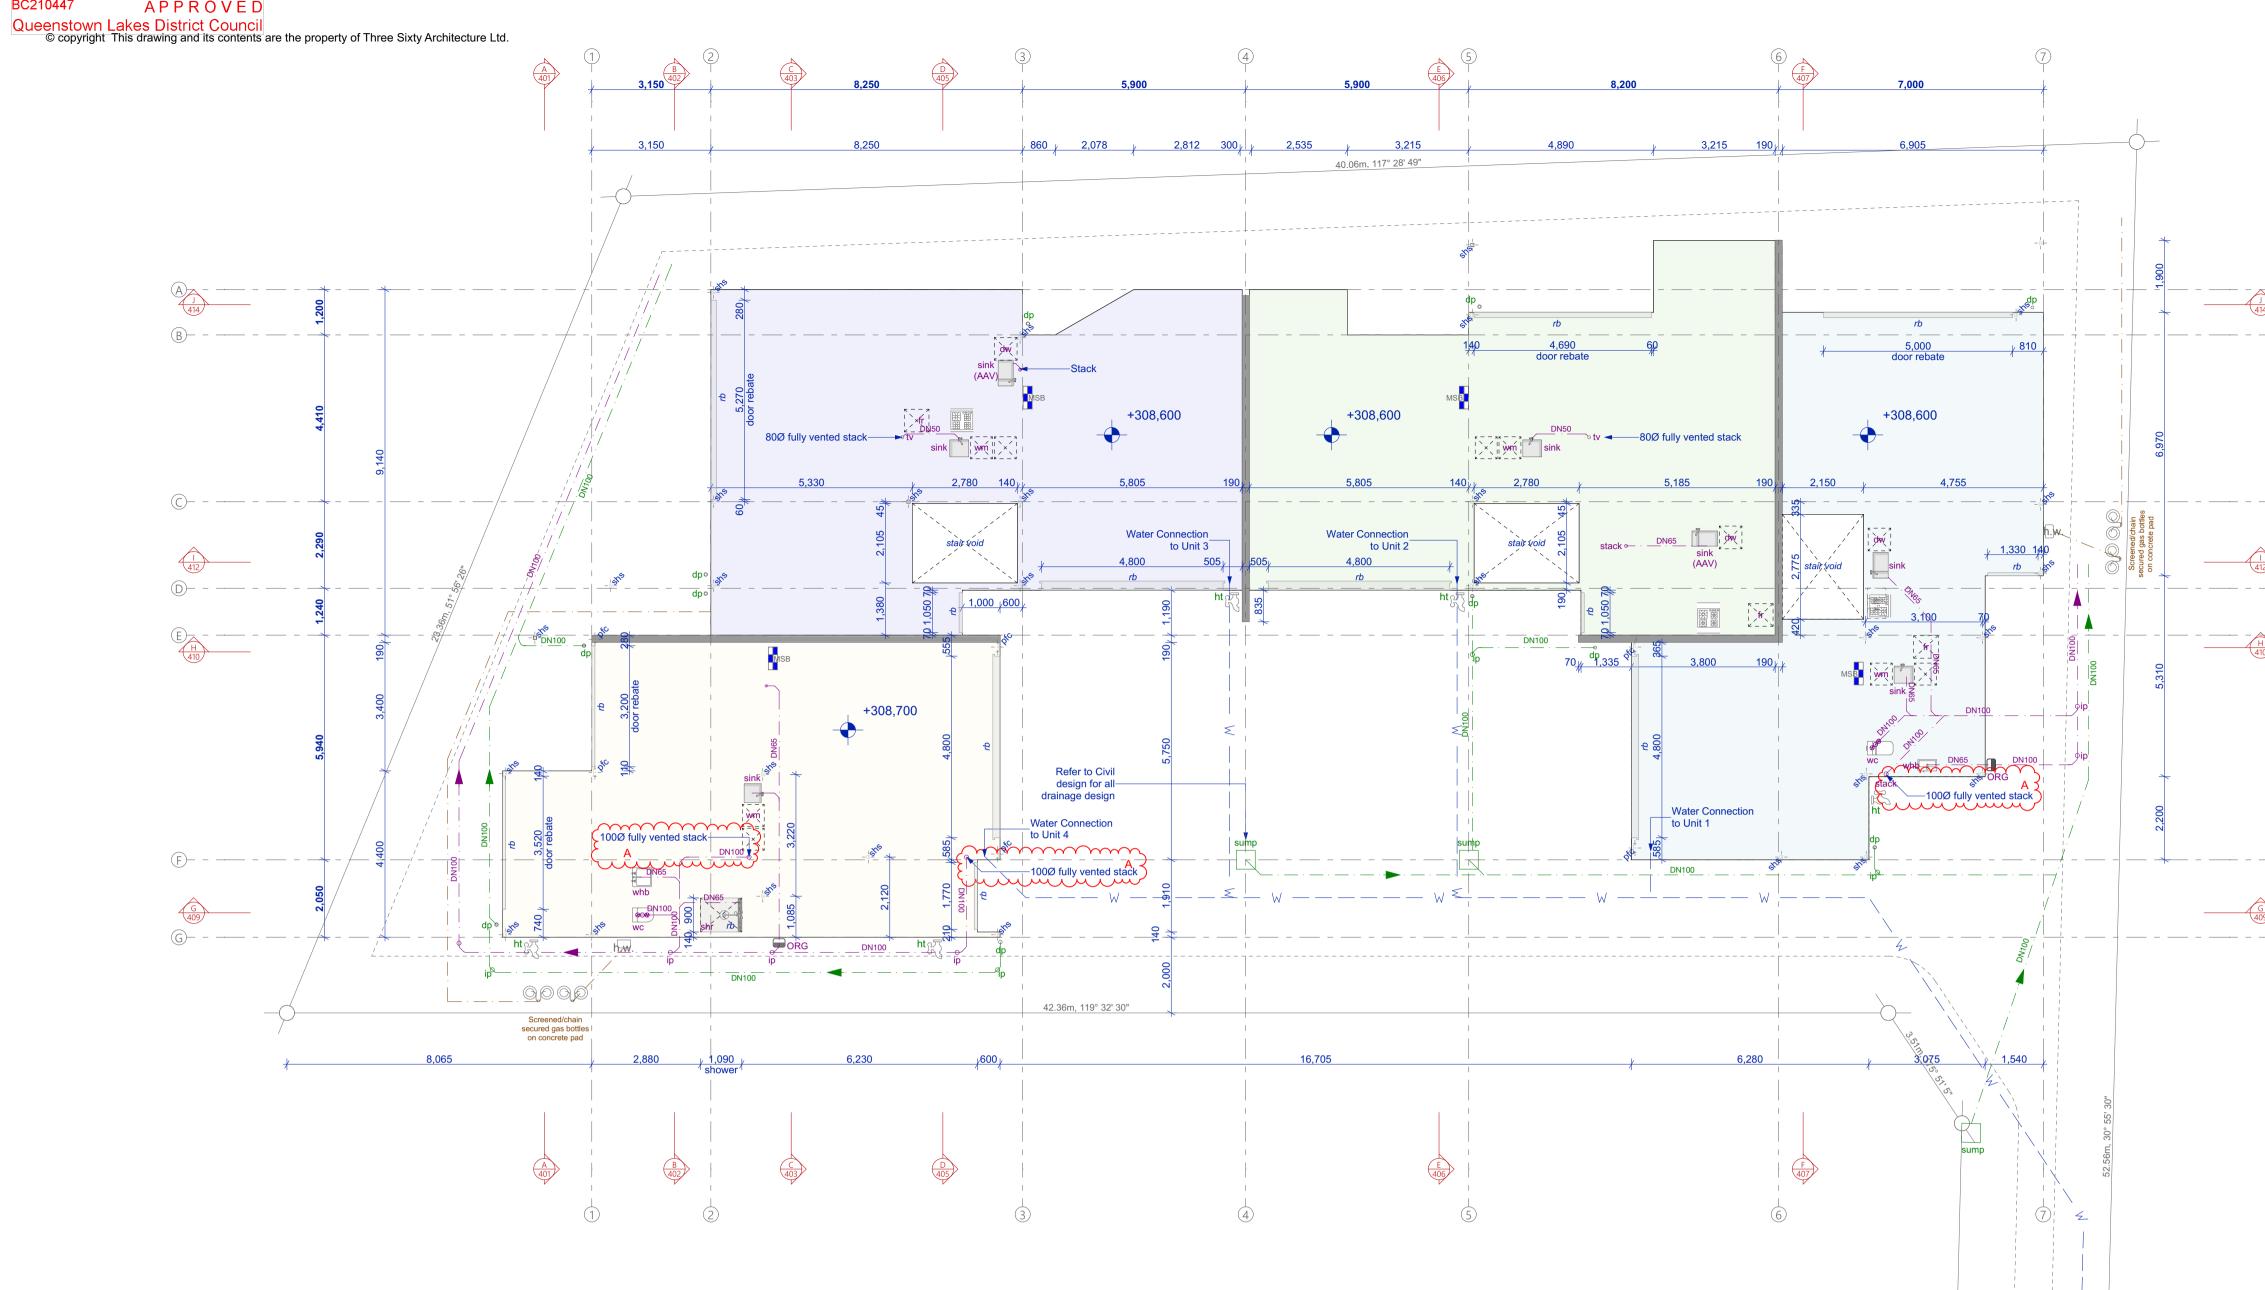

Issue:
Building Consent Issue
Council RFI



Above slab In/below slab

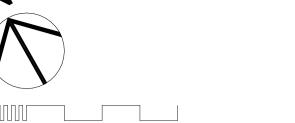Plumbing line types

Water supply — — W — —

SW uPVC ø100 mm 1:120 min SS uPVC ø100 mm 1:60 min

Gas line

whb W/hand basin DN40 1:40 DN65 1:40 DN50 1:40 DN65 1:40 sink Sink bath Bath DN50 1:40 DN65 1:40 shr Shower DN50 1:40 DN65 1:40 wc WC toilet DN80 1:60 DN100 1:60 tv Terminal vent DN80 io Inspection DN40 ht Hose tap st Silt trap Main drains DN100 1:60

nb 150mm high concrete nib wall

rb rebate in floor

Plumbing notes: All materials, workmanship and design of sanitary plumbing and drainage to the following: AS/NZS3500.1 (water supply)

AS/NZS3500.2 (sanitary) AS/NZS3500.3 (stormwater) AS/NZS3500.4 (hot water).

Note: as an alternative to venting all fittings back to terminal vent, air admittance valves may be installed to all fittings.

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Min temperature of cylinder to be 60° degrees Celsius. Limit water temperature to 55° degrees Celsius via a tempering valve where hot water is supplied to sanitary fittings used for personal hygiene all to comply with AS/NZS3500.4.

Slab notes:

Slab thickenings as per engineers documents

Structural steel posts to be rebated into slab as detailed by engineer.

Tiled showers to have 50mm rebate into slab to allow for mortar fill with tiles over to form required falls to outlets.

Liaise with electrical & hvac contractor for underground or in slab conduit for electrical cabling and hvac ducting.

Drainage notes:

Allow to check all levels on site prior to

Read in conjunction with slab and footing

Three Sixty Architecture



Chalmers Street Apartments 20 Chalmers Street Wanaka

L1 Foundation Plan


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Sheet No. 202

Thee Sixty Architects Limited Level 1, The Yard


173 St Asaph Street Christchurch 8140

t: 03 366 3349

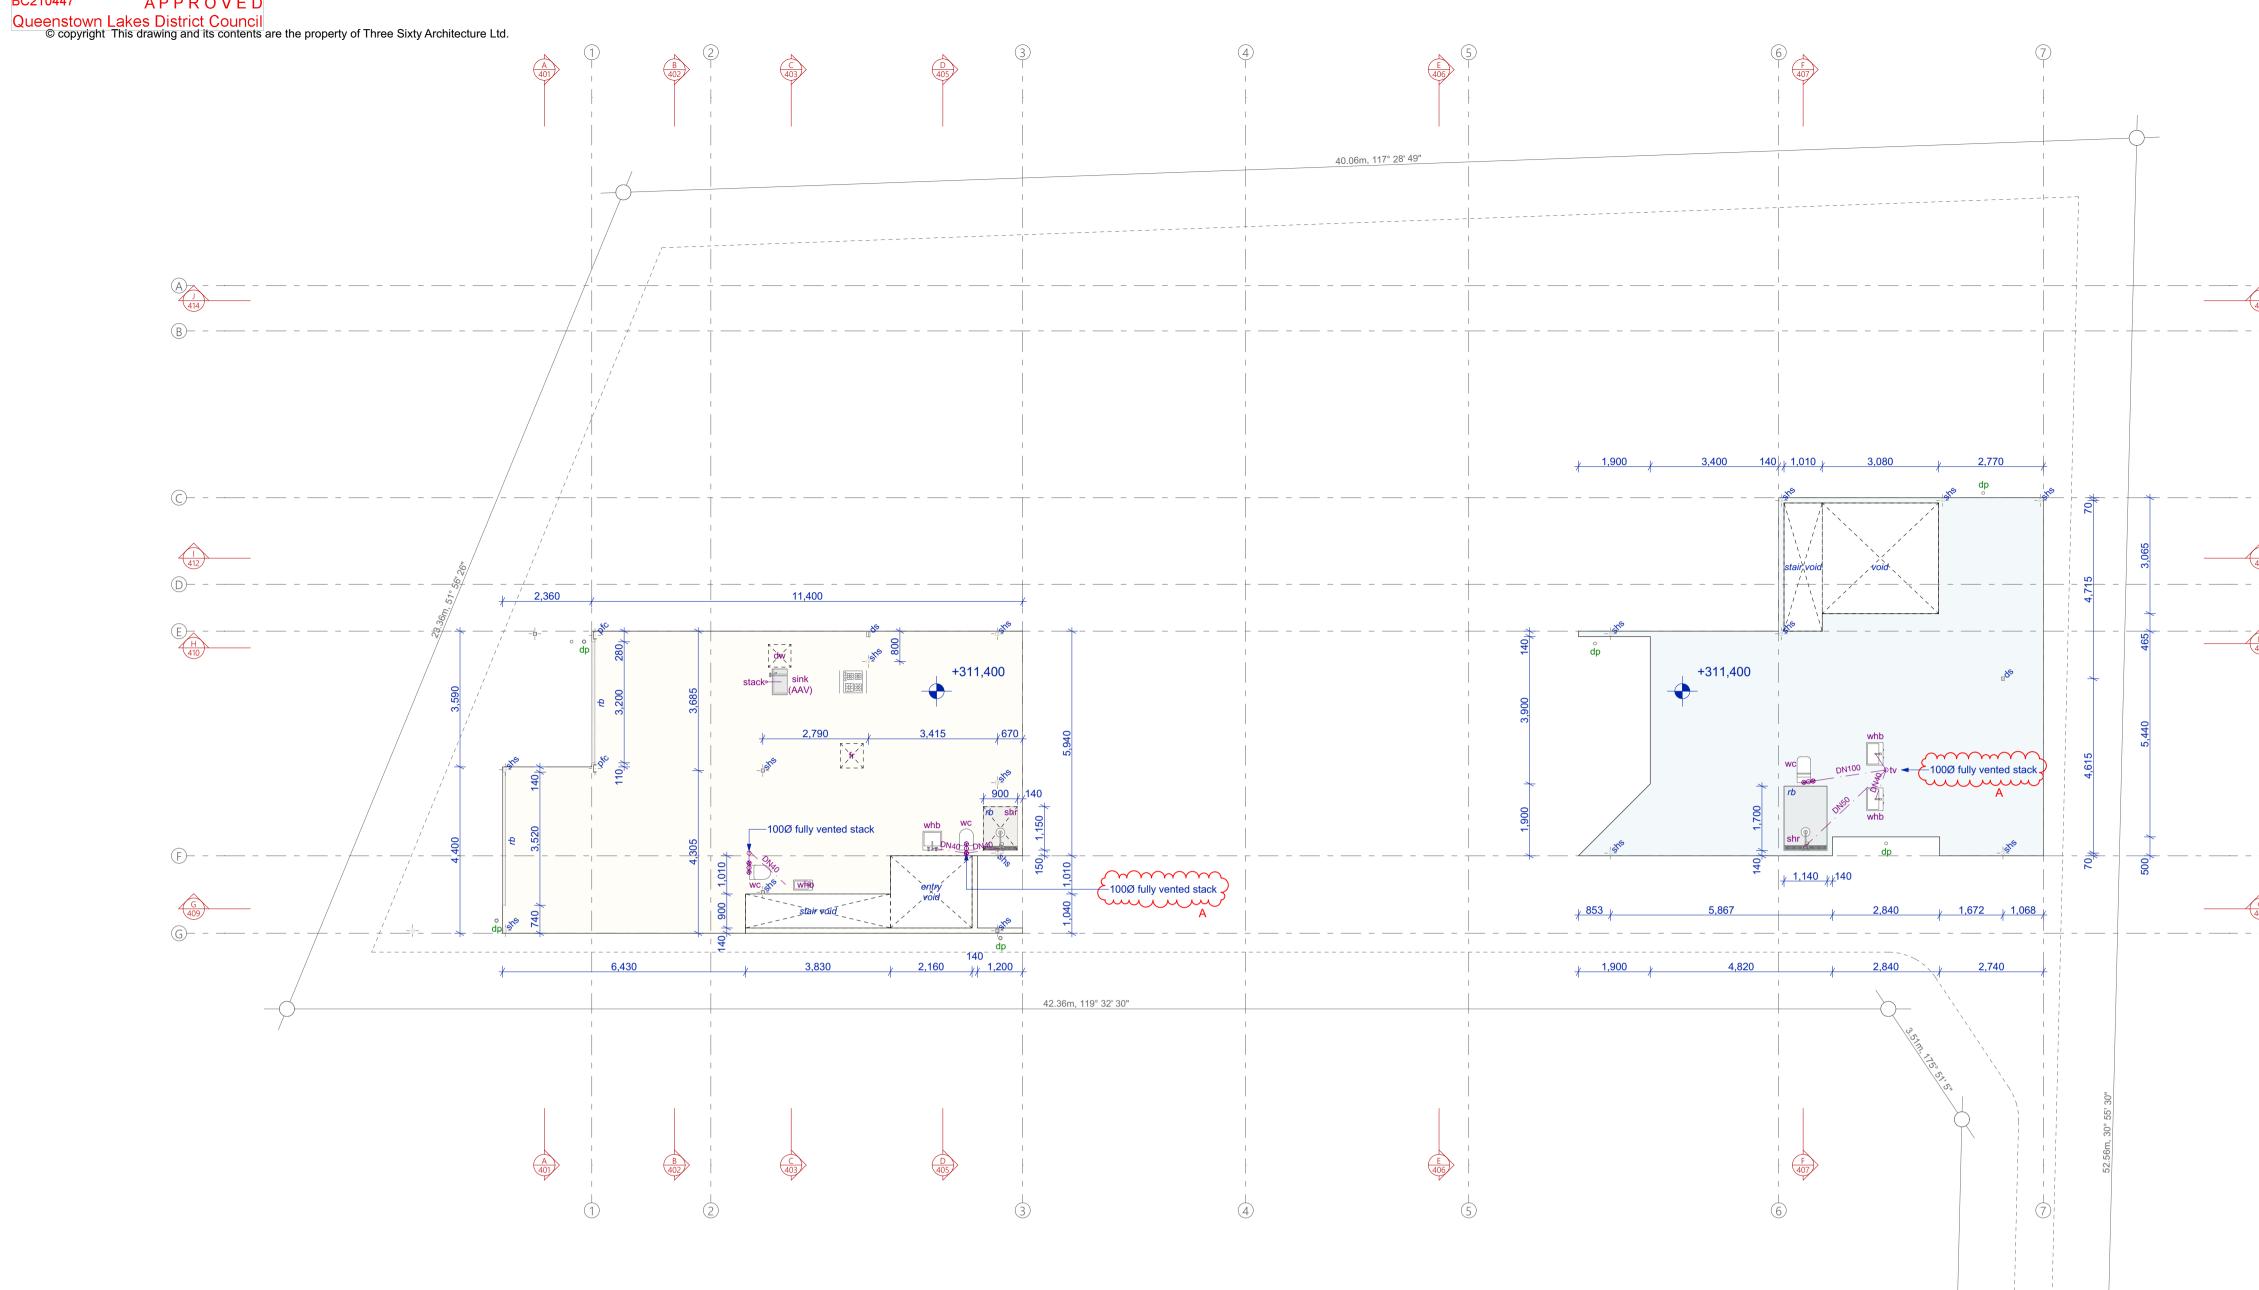

L2 Plumbing Plan

Building Consent

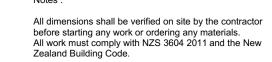

Issue:
Building Consent Issue
Council RFI

Plumbing line types

Water supply — — W — —

SW uPVC ø100 mm 1:120 min SS uPVC ø100 mm 1:60 min

Above slab In/below slab whb W/hand basin DN40 1:40 DN65 1:40 sink Sink DN50 1:40 DN65 1:40 sink Sink bath Bath DN50 1:40 DN65 1:40 shr Shower DN50 1:40 DN65 1:40 wc WC toilet DN80 1:60 DN100 1:60 tv Terminal vent DN80 io Inspection DN40 ht Hose tap st Silt trap

Main drains DN100 1:60 nb 150mm high concrete nib wall

rb rebate in floor

Plumbing notes: All materials, workmanship and design of sanitary plumbing and drainage to the

following: AS/NZS3500.1 (water supply) AS/NZS3500.2 (sanitary) AS/NZS3500.3 (stormwater) AS/NZS3500.4 (hot water).

Note: as an alternative to venting all fittings back to terminal vent, air admittance valves may be installed to all fittings.

Note: 20mm condensate drain pipe from ghw be fitted with vacuum break device on waste pipe connected into nearest fixture waste complete with air gap as per AS/NZS3500.4 (refer to product specifications)

Min temperature of cylinder to be 60° degrees Celsius. Limit water temperature to 55° degrees Celsius via a tempering valve where hot water is supplied to sanitary fittings used for personal hygiene all to comply with AS/NZS3500.4.

Slab notes:

Slab thickenings as per engineers documents

Structural steel posts to be rebated into slab as detailed by engineer.

Tiled showers to have 50mm rebate into slab to allow for mortar fill with tiles over to form required falls to outlets.

Liaise with electrical & hvac contractor for underground or in slab conduit for electrical cabling and hvac ducting.

Drainage notes:

Allow to check all levels on site prior to

Read in conjunction with slab and footing

Three Sixty Architecture



Chalmers Street Apartments 20 Chalmers Street Wanaka


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1:100 Scale @ A1 R19015 File No. Date 9/06/2021 Revision

Thee Sixty Architects Limited Level 1, The Yard 173 St Asaph Street Christchurch 8140

203

t: 03 366 3349

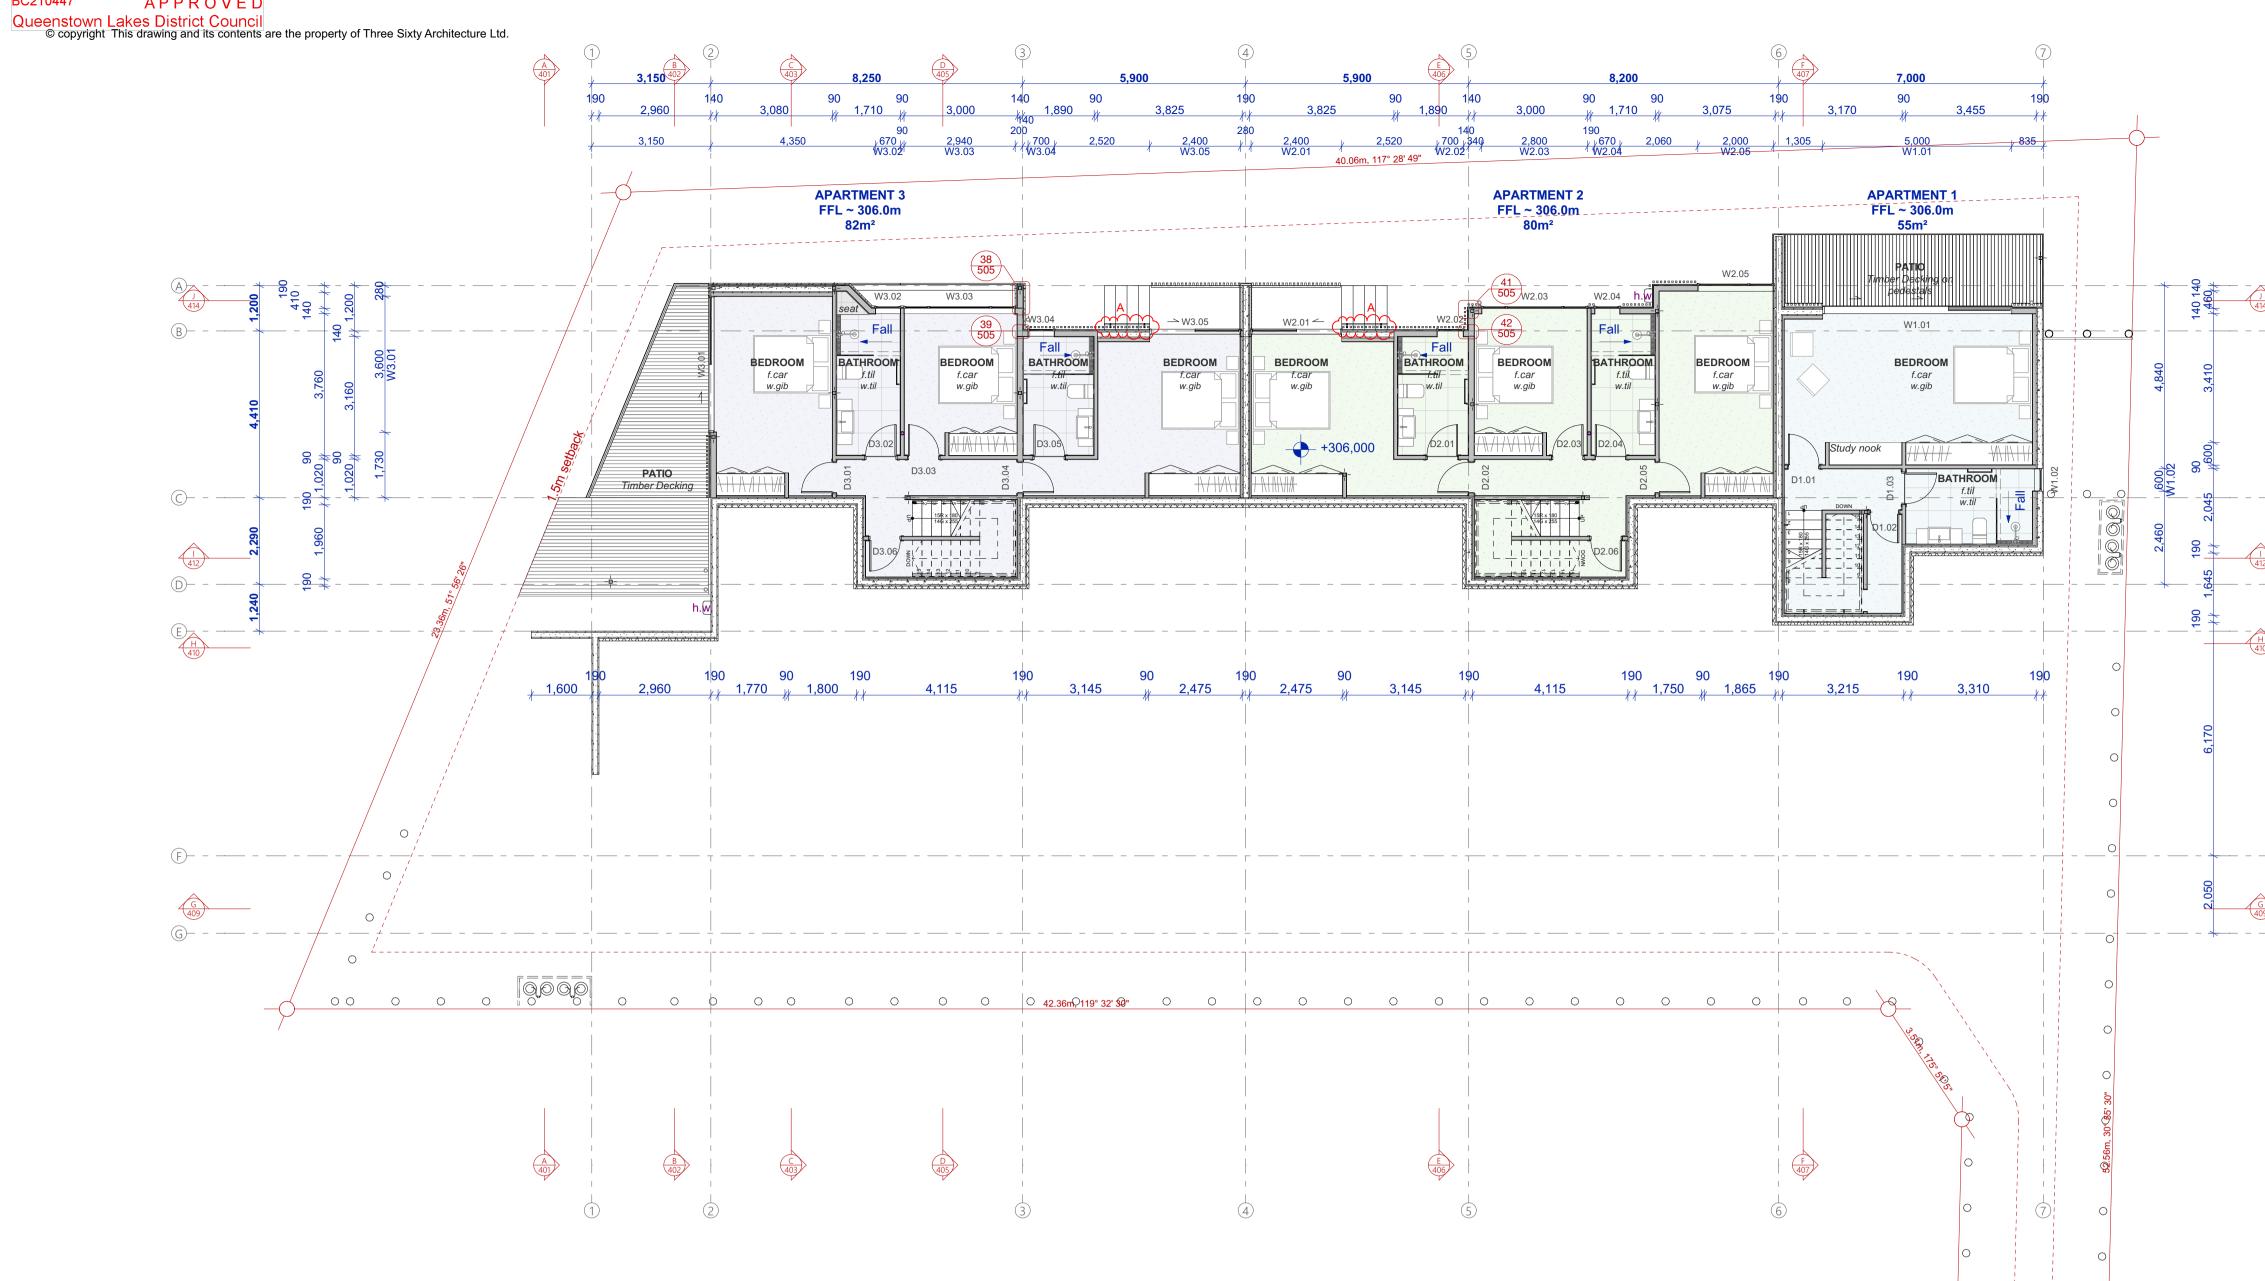

L0 Basement Plan

Building Consent

All dimensions shall be verified on site by the contractor before starting any work or ordering any materials.
All work must comply with NZS 3604 2011 and the New Zealand Building Code.

Issue:
Building Consent Issue
Council RFI

Interior linings:

Walls generally: Walls Wet areas: Walls Garage: Shower walls:

Ceilings generally: Soffits Generally:

Ceilings Garage:

Refer to internals for extent of tiling to bathrooms, ensuite etc. Refer to engineers bracing schedule for details of bracing

10mm Gib lining

10mm Aqualine 9mm Ply Selected tiles

installed over

waterbarrier.

at 600mm.

12mm Ply

13mm Gib supported

Bandsawn Grooved Ply Paint Finish

Timber framing:

Exterior wall framing: H1.2 treated Wall cavity battens: H3.2 treated Membrane roofing ply: H3.2 treated cca Membrane rafters: H1.2 treated Roof framing: H1.2 treated H1.2 treated Ceiling framing

CCA treated timber must not come in contact with Colorsteel or structural steel.

All structural timber shall be MSG8 grade unless stated otherwise.

Refer to cladding specifications for framing set out to suit non-structural cavity systems. In general all walls to be framing set out as Structural: 140x45 framing: studs @ 600mm /

dwangs @ 800mm 90x45 framing: studs @ 600mm / dwangs @ 800mm


Partitions: Up to 3m 90x45 framing: studs @ 600mm / dwangs @ 800mm

Insulation:

All external 140mm walls to be insulated with minimum R4.0 Roof areas to have R5.0 insulation installed above the ceiling lining.

- 50mm XPS polystyrene under slab insulation
- All bathroom spaces to have acoustic insulation to all cavities.
- Provide acoustic insulation between bedrooms & living areas.

Window setout diagram

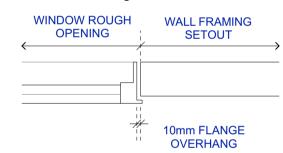

Window rough opening dimensions allow for 10mm overhang between window flange and framing edge.

FLOORING LEGEND

CARPET OVER UNDERLAY

19mm ADHESIVE FIXED TIMBER FLOORING NONSLIP TILES 600x600

CONCRETE FINISHED WITH SEALER COAT

Three Sixty Architecture



Chalmers Street Apartments 20 Chalmers Street Wanaka

L0 Basement Plan


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Sheet No.

204

Thee Sixty Architects Limited Level 1, The Yard 173 St Asaph Street Christchurch 8140

t: 03 366 3349

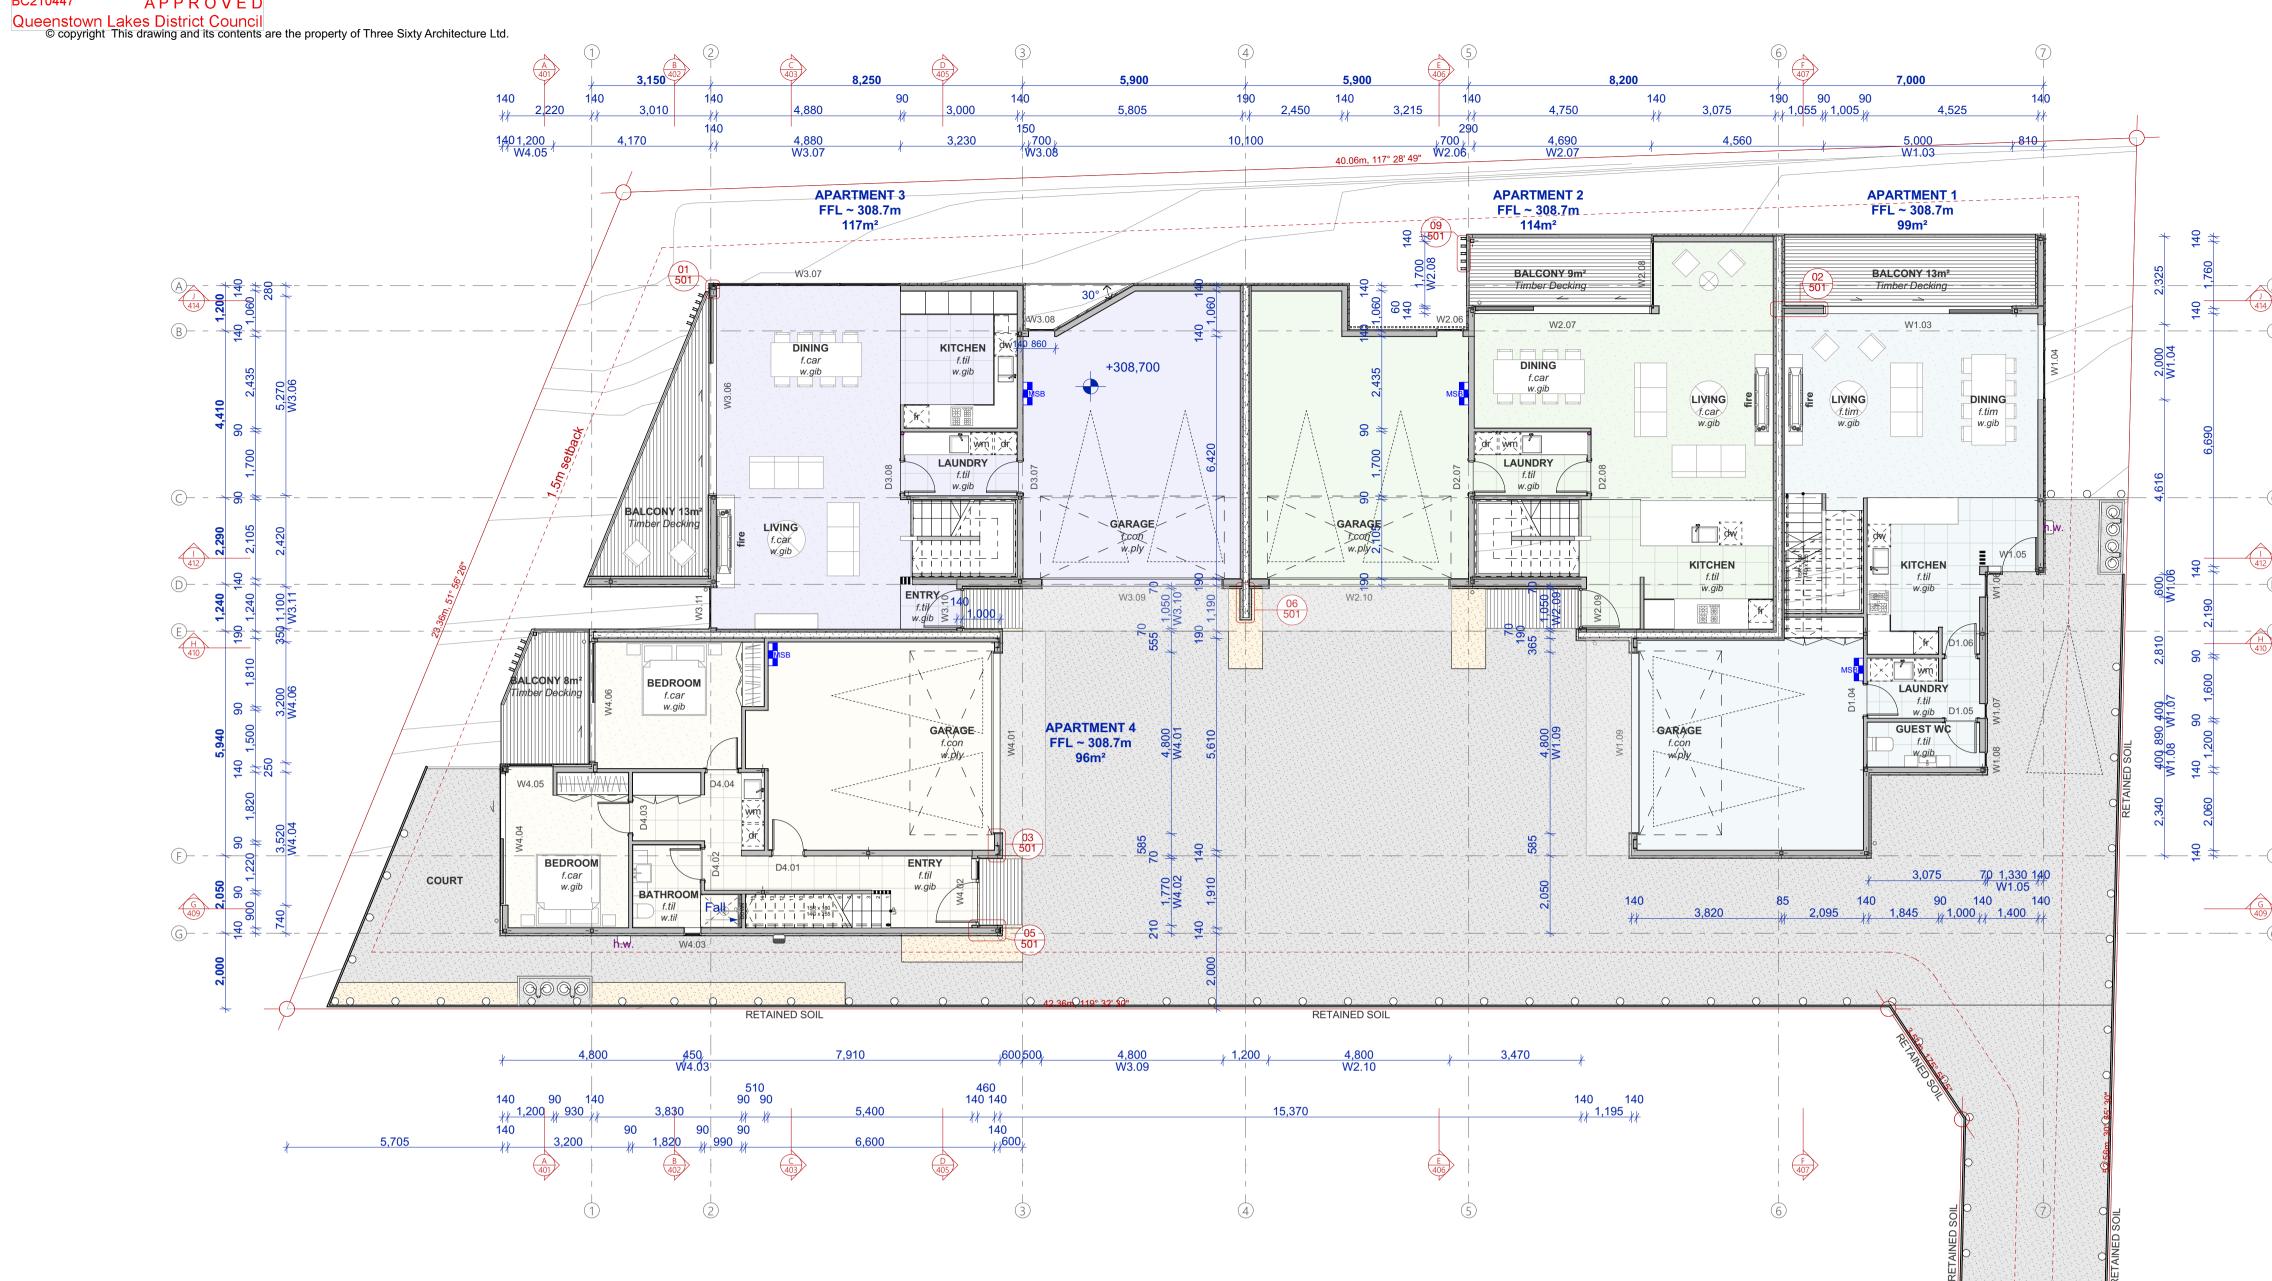


L1 Ground Floor Plan

Building Consent

All dimensions shall be verified on site by the contractor before starting any work or ordering any materials.
All work must comply with NZS 3604 2011 and the New Zealand Building Code.

Issue: Building Consent Issue

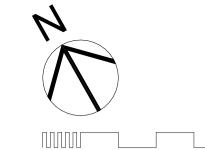

Interior linings:

Walls generally: 10mm Gib lining Walls Wet areas: 10mm Aqualine 9mm Ply Selected tiles Walls Garage: Shower walls: installed over waterbarrier.

Ceilings generally: Soffits Generally:

Ceilings Garage: 12mm Ply Refer to internals for extent of tiling to bathrooms, ensuite etc. Refer to engineers bracing schedule for details

13mm Gib supported

Bandsawn Grooved

Ply Paint Finish

at 600mm.

Timber framing:

of bracing

Exterior wall framing: H1.2 treated Wall cavity battens: H3.2 treated Membrane roofing ply: H3.2 treated cca Membrane rafters: H1.2 treated Roof framing: H1.2 treated H1.2 treated Ceiling framing

CCA treated timber must not come in contact with Colorsteel or structural steel.

All structural timber shall be MSG8 grade unless stated otherwise.

Refer to cladding specifications for framing set out to suit non-structural cavity systems. In general all walls to be framing set out as Structural: 140x45 framing: studs @ 600mm /

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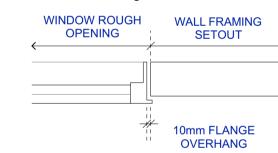
Partitions: Up to 3m 90x45 framing: studs @ 600mm / dwangs @ 800mm

Insulation:

All external 140mm walls to be insulated with minimum R4.0 Roof areas to have R5.0 insulation installed above the ceiling lining.

- 50mm XPS polystyrene under slab insulation
- All bathroom spaces to have acoustic
- insulation to all cavities. Provide acoustic insulation between bedrooms & living areas.

Window setout diagram



Window rough opening dimensions allow for 10mm overhang between window flange and framing edge.

FLOORING LEGEND

CARPET OVER UNDERLAY

19mm ADHESIVE FIXED TIMBER FLOORING

NONSLIP TILES 600x600

CONCRETE FINISHED WITH SEALER COAT

Three Sixty Architecture



Chalmers Street Apartments 20 Chalmers Street Wanaka

L1 Ground Floor Plan


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Sheet No.

205

Thee Sixty Architects Limited Level 1, The Yard 173 St Asaph Street Christchurch 8140

t: 03 366 3349

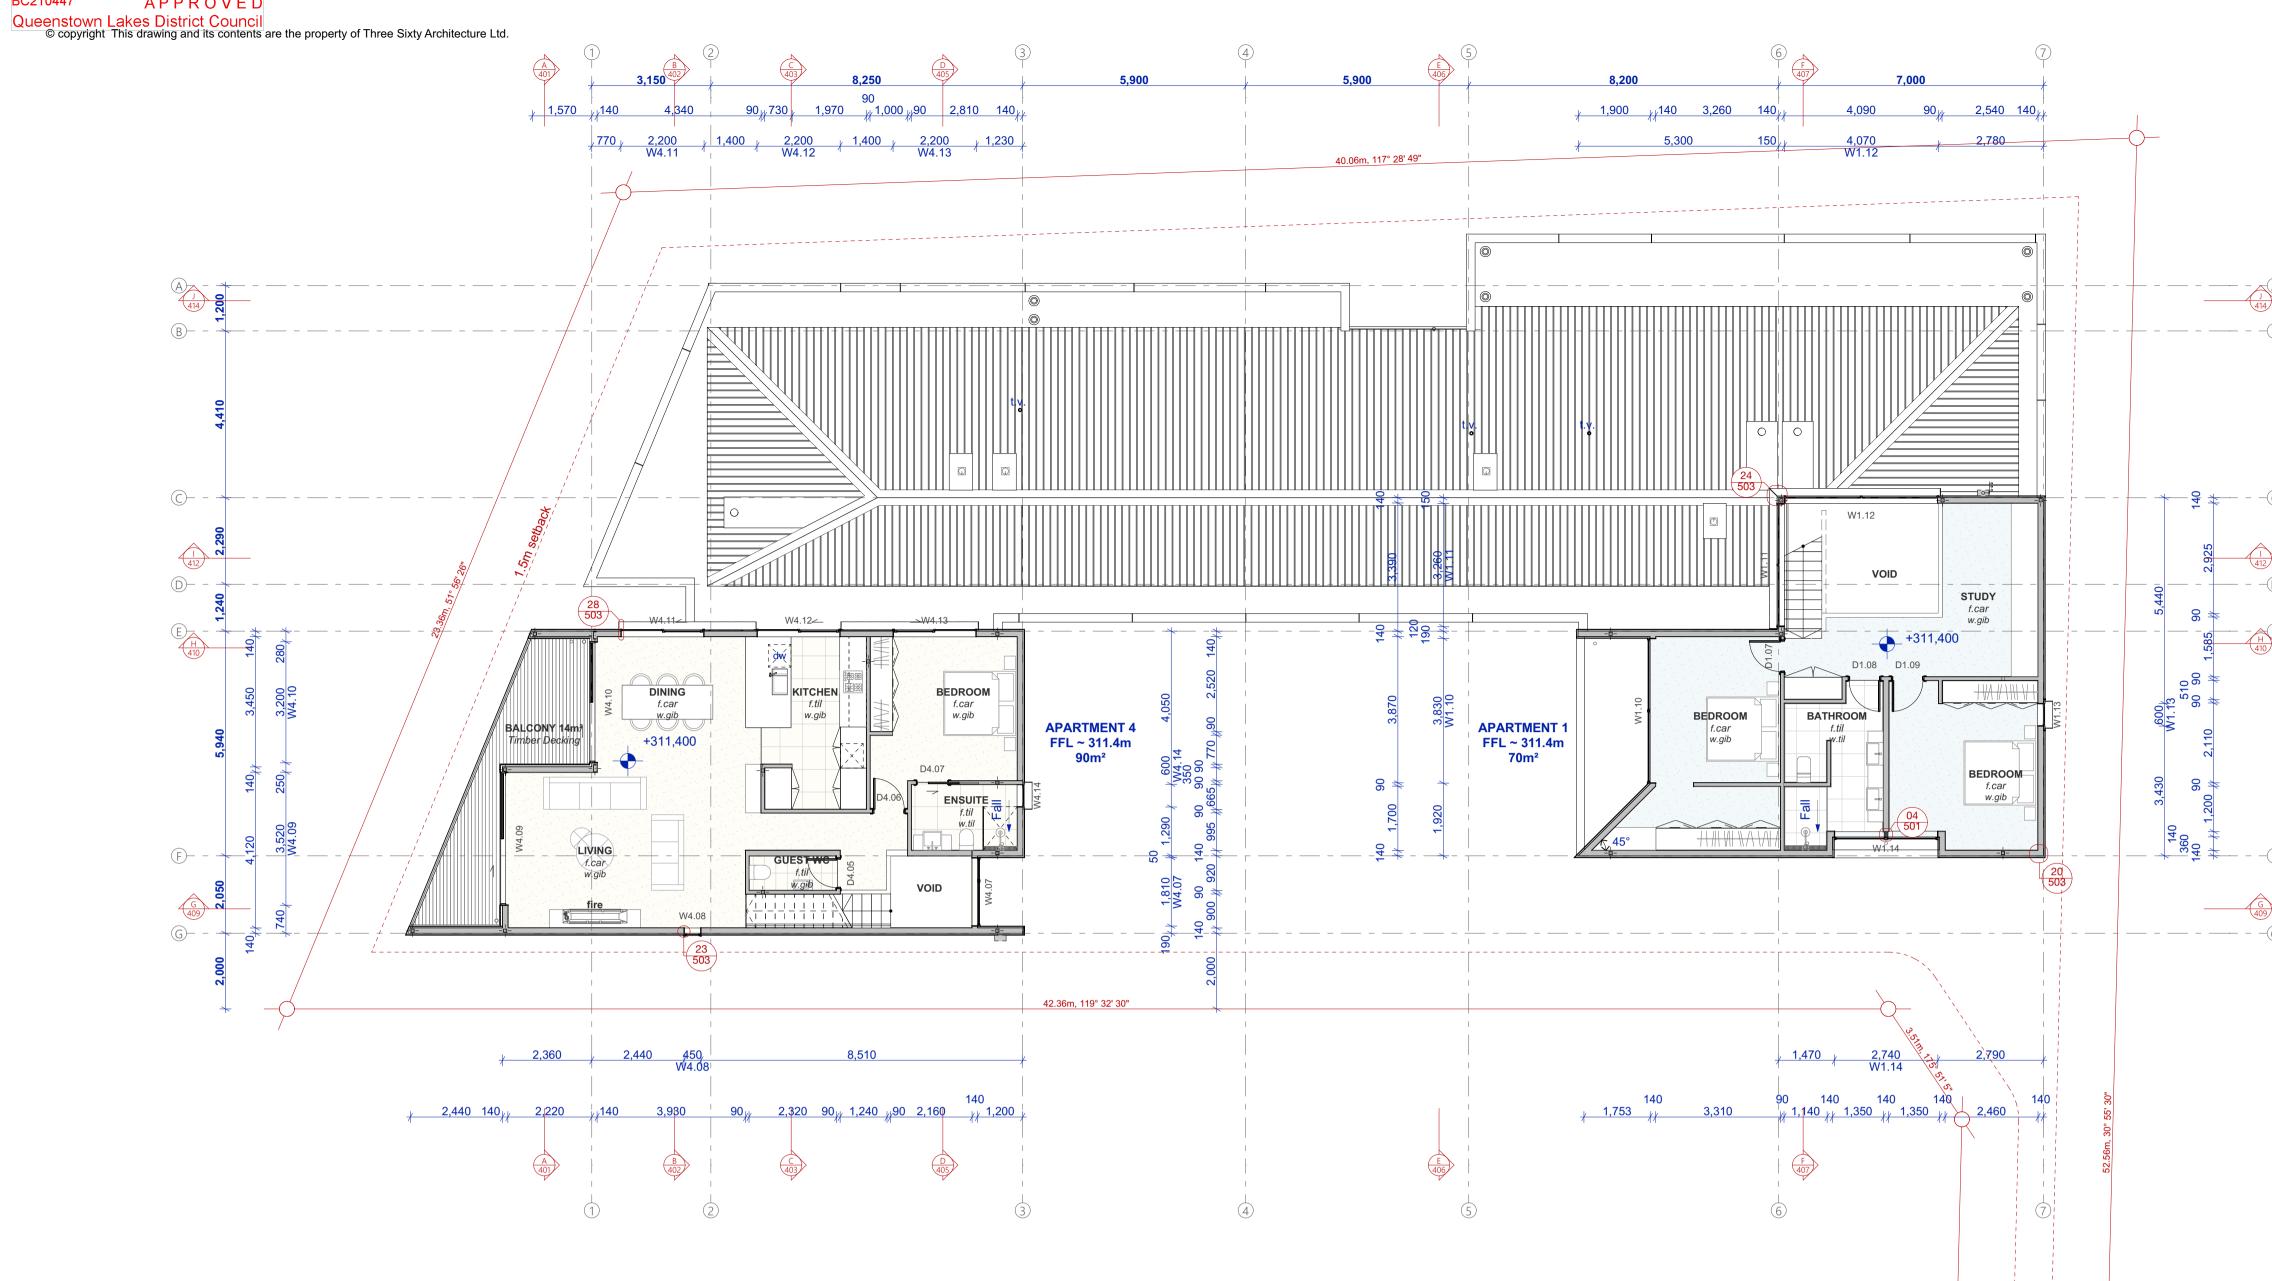


L2 First Floor Plan

Building Consent

All dimensions shall be verified on site by the contractor before starting any work or ordering any materials.
All work must comply with NZS 3604 2011 and the New Zealand Building Code.

Issue: Building Consent Issue

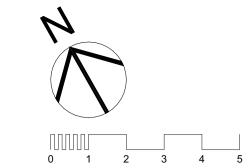

Interior linings:

Walls generally: 10mm Gib lining 10mm Aqualine Walls Wet areas: 9mm Ply Selected tiles Walls Garage: Shower walls: installed over waterbarrier.

Ceilings generally: Soffits Generally:

Ceilings Garage:

Refer to internals for extent of tiling to bathrooms, ensuite etc. Refer to engineers bracing schedule for details of bracing

13mm Gib supported

Bandsawn Grooved Ply Paint Finish

at 600mm.

12mm Ply

Timber framing:

Exterior wall framing: H1.2 treated Wall cavity battens: H3.2 treated Membrane roofing ply: H3.2 treated cca Membrane rafters: H1.2 treated Roof framing: H1.2 treated Ceiling framing H1.2 treated

CCA treated timber must not come in contact with Colorsteel or structural steel.

All structural timber shall be MSG8 grade unless stated otherwise.

Refer to cladding specifications for framing set out to suit non-structural cavity systems. In general all walls to be framing set out as Structural: 140x45 framing: studs @ 600mm /

dwangs @ 800mm 90x45 framing: studs @ 600mm / dwangs @ 800mm


Partitions: Up to 3m 90x45 framing: studs @ 600mm / dwangs @ 800mm

Insulation:

All external 140mm walls to be insulated with minimum R4.0 Roof areas to have R5.0 insulation installed above the ceiling lining.

- 50mm XPS polystyrene under slab insulation
- All bathroom spaces to have acoustic insulation to all cavities. Provide acoustic insulation between

bedrooms & living areas.

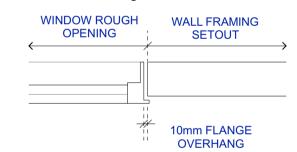

Window rough opening dimensions allow for 10mm overhang between window flange and framing edge.

FLOORING LEGEND

CARPET OVER UNDERLAY

19mm ADHESIVE FIXED TIMBER FLOORING

NONSLIP TILES 600x600

CONCRETE FINISHED WITH SEALER COAT

Three Sixty Architecture



Chalmers Street Apartments 20 Chalmers Street Wanaka

L2 First Floor Plan


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Sheet No.

206

Thee Sixty Architects Limited Level 1, The Yard 173 St Asaph Street Christchurch 8140

t: 03 366 3349

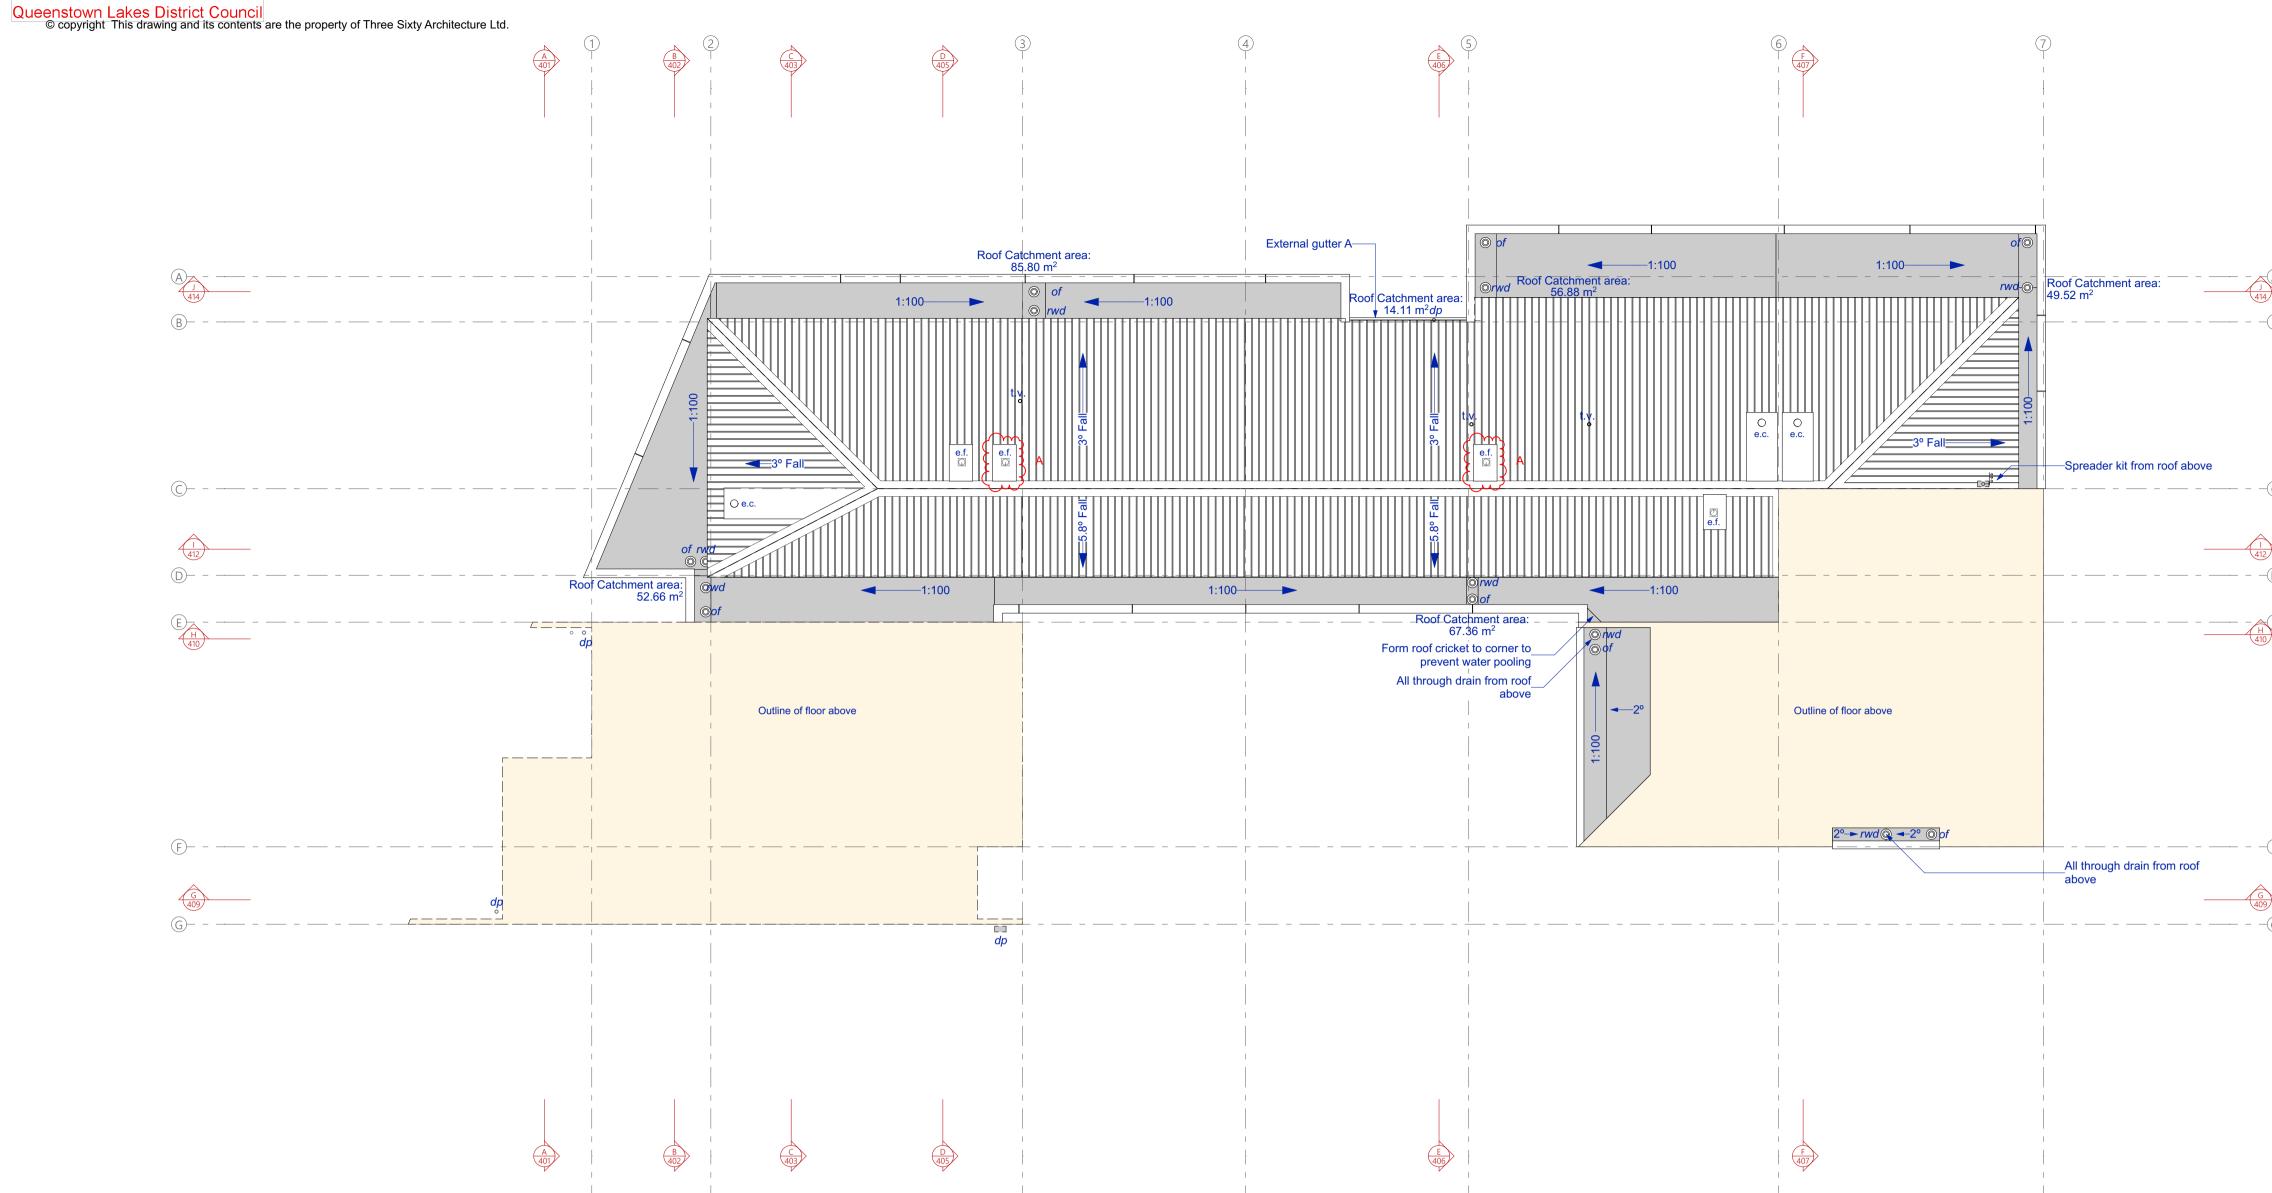

L1 Roof Plan

Building Consent

All dimensions shall be verified on site by the contractor before starting any work or ordering any materials.
All work must comply with NZS 3604 2011 and the New Zealand Building Code.

Issue:
Building Consent Issue
Council RFI



Colorsteel Roofing
0.55 BMT Colorsteel T-Rib Roofing at min.

Membrane roof/gutters
Viking Lybra SBS Torch-on Waterproofing manufacturers details over 17mm F8 H3.2 CCA treated ply supported at 400crs

Snow boards to be installed to all internal gutters formed with H3.2 Ex20x20 battens at 65mm crs on H4 45x45 runners in 1.2m

Legend:

- downpipes where exposed, to be secured in place with matching munzing rings at 1.8m crs
- rwh Folded Colorsteel rainwater heads to be installed over outflow scupper to roof
- outlet SDM049 with S/S domed grate. Connect with colorsteel downpipe below
- of 80mm Roof drain Viking clamped outlet SDM049 with S/S domed grate. PVC outlet to extend 10mm below soffit
- *Irv* lowrise roof cavity vent.
- tv Terminal vent penetration
- ec Chimney penetration for gas fire
- ef Extract fan roof penetration


Membrane roofing to be laid in accordance with manufacturers instructions. Refer specifications

All spouting to be folded Colorsteel - As per

Where a roof drain drops down through another outlet below, install an Allproof 'Allthrough' drain

Allow to refer to electrical drawings for further details of aerials, dishes and ac equipment shown on the roof plan. All support brackets

Vented flashing to be installed to skillion ceilings as detailed.

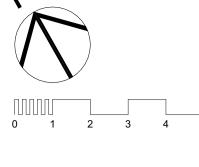

Roofing systems

3deg. over selected roofing underlay and wire mesh, screwed to top of purlins (70x45 900crs max). Prefinished Colorsteel Endura finish.

membrane installed in accordance with the

sections.


- dp 80Ø Downpipes. Provide Colorsteel
- gutter.
- rwd 80mm Roof drain Viking clamped

Roofing notes

profile A below

and align outlets above and below.

through roofing shall be flashed weathertight.

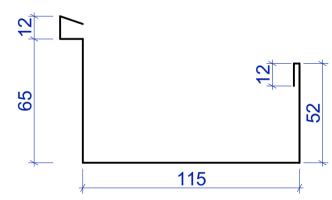

A External Gutter Profile - Scale 1:2

Three Sixty Architecture



Chalmers Street Apartments 20 Chalmers Street Wanaka

L1 Roof Plan


Sheet No.	007	
Revision	Α	
Date	9/06/2021	
File No.	R19015	
Scale @ A1	1:100, 1:2	

207

Thee Sixty Architects Limited Level 1, The Yard 173 St Asaph Street Christchurch 8140

t: 03 366 3349

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Building Consent

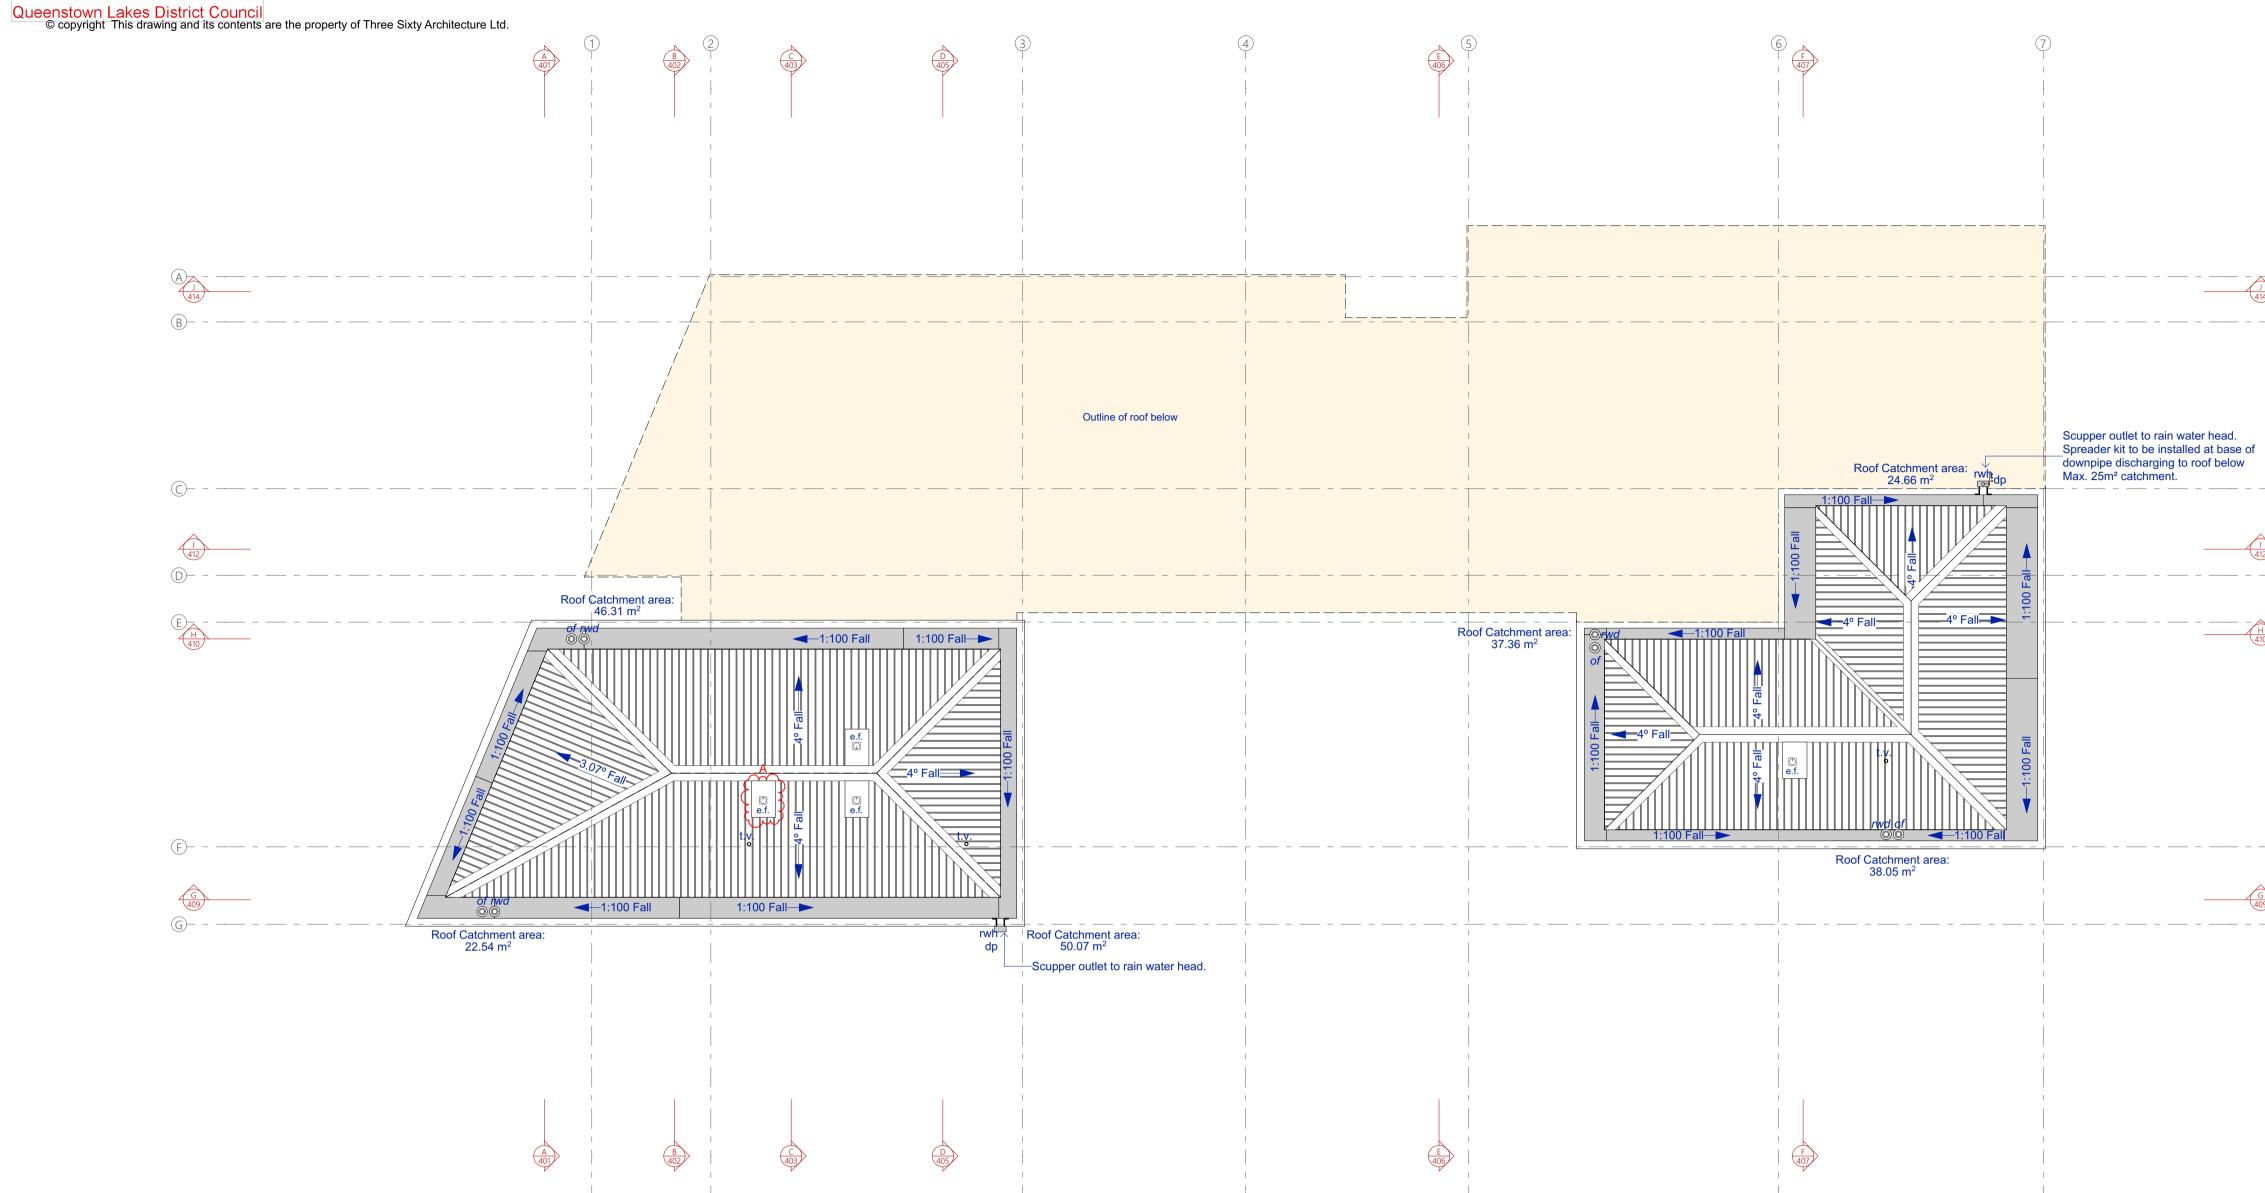
Notes :

All dimensions shall be verified on site by the contractor before starting any work or ordering any materials.
All work must comply with NZS 3604 2011 and the New Zealand Building Code.

 Rev:
 Date:
 Issue:

 16/04/2021
 Building Consent Issue

 A
 9/06/2021
 Council RFI

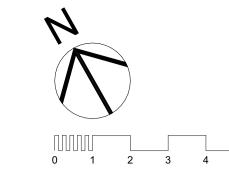

Roofing systems

Colorsteel Roofing
0.55 BMT Colorsteel T-Rib Roofing at min.
3deg. over selected roofing underlay and wire mesh, screwed to top of purlins (70x45 900crs max). Prefinished Colorsteel Endura finish.

Membrane roof/gutters
Viking Lybra SBS Torch-on Waterproofing
membrane installed in accordance with the
manufacturers details over 17mm F8 H3.2 CCA
treated ply supported at 400crs

Snow boards to be installed to all internal gutters formed with H3.2 Ex20x20 battens at 65mm crs on H4 45x45 runners in 1.2m sections.

Legend:

- dp 80Ø Downpipes. Provide Colorsteel downpipes where exposed, to be secured in place with matching munzing rings at 1.8m crs
- rwh Folded Colorsteel rainwater heads to be installed over outflow scupper to roof gutter.
- rwd 80mm Roof drain Viking clamped outlet SDM049 with S/S domed grate. Connect with colorsteel downpipe below
- of 80mm Roof drain Viking clamped outlet SDM049 with S/S domed grate.
 PVC outlet to extend 10mm below soffit
- Irv lowrise roof cavity vent.
- tv Terminal vent penetration
- ec Chimney penetration for gas fire
- ef Extract fan roof penetration

Roofing notes


Membrane roofing to be laid in accordance with manufacturers instructions. Refer specifications

All spouting to be folded Colorsteel - As per profile A below

Where a roof drain drops down through another outlet below, install an Allproof 'Allthrough' drain and align outlets above and below.

Allow to refer to electrical drawings for further details of aerials, dishes and ac equipment shown on the roof plan. All support brackets through roofing shall be flashed weathertight.

Vented flashing to be installed to skillion ceilings as detailed.

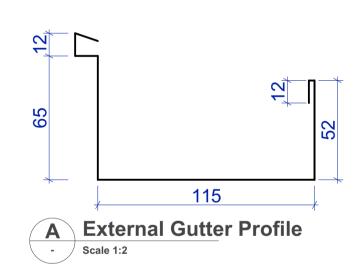

Three Sixty Architecture



Chalmers Street
Apartments
20 Chalmers Street
Wanaka

L2 Roof Plan

Scale @ A1	1:100, 1:2	
File No.	R19015	
Date	9/06/2021	
Revision	Α	


208

Thee Sixty Architects Limited Level 1, The Yard 173 St Asaph Street Christchurch 8140

t: 03 366 3349

Sheet No.

BC210447 APPROVED

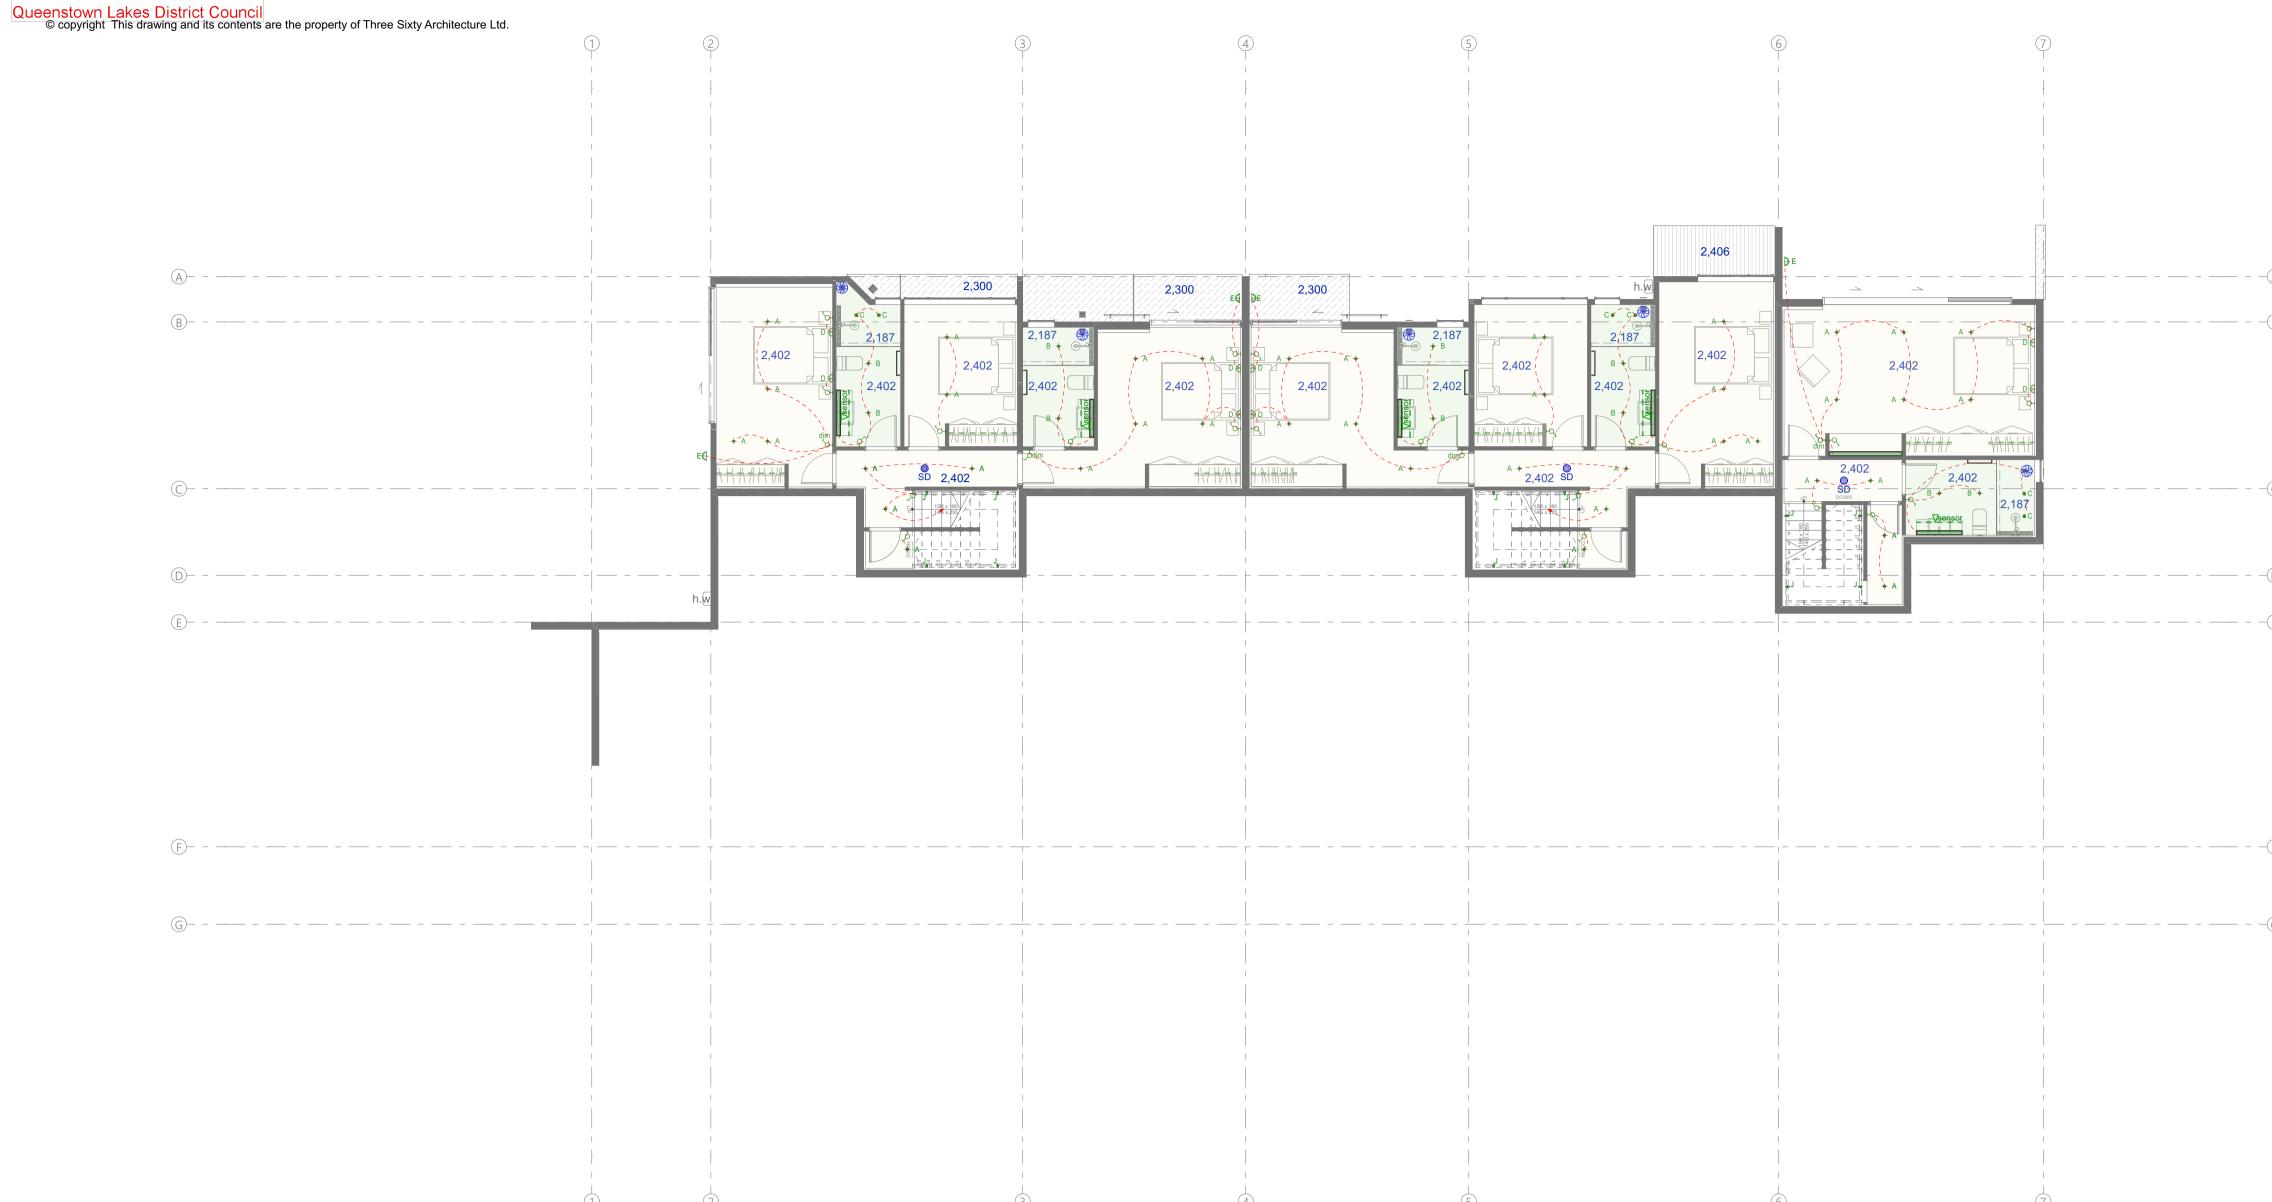



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Lighting le

+ A Recessed LED downlight

* B Recessed LED downlight IP rated

C Mini Spot LED downlight IP rated D Wall mounted light fitting above bed

Pendant light fitting

T endant light littli

Feature pendant cluster

H Soffit mounted mini Spot LED downlight IP rated
 Directional recessed LED downlight

■ J Recessed LED low wall mounted stair light

Suspended LED track

LED Strip integrated into joinery

LED Mirror light

Surface Mounted Fluorescent light

Light switch

dim Dimmer Circuit

Circuit Wire

Smoke detector with hush facility

Lighting Notes

Installation of all light fittings must comply with fire regulations


Installation of smoke detection system to meet nzbc c1, including hush facility to all smoke detectors

Ensure that all IP ratings of fittings is suited for their selected install location.


Ceiling legend



13mm Gib standard lining on Rondo battens. Stop smooth to level 4 finish to receive paint

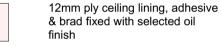

13mm GIB Aqualine stopped smooth to level 4 finish ready for painted finish.

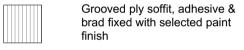

Cudoclad Alpolic FR composit aluminium soffit intergrated with cladding system

Building Consent

Notes :

All dimensions shall be verified on site by the contractor before starting any work or ordering any materials. All work must comply with NZS 3604 2011 and the New Zealand Building Code.

 Rev:
 Date:
 Issue:

 16/04/2021
 Building Consent Issue

Three Sixty Architecture



Chalmers Street
Apartments
20 Chalmers Street
Wanaka

L0 Reflected Ceiling Plan

 Scale @ A1
 1:100

 File No.
 R19015

 Date
 9/06/2021

 Revision

Sheet No.


209


Thee Sixty Architects Limited Level 1, The Yard 173 St Asaph Street Christchurch 8140

t: 03 366 3349



L1 RCP Scale 1:100

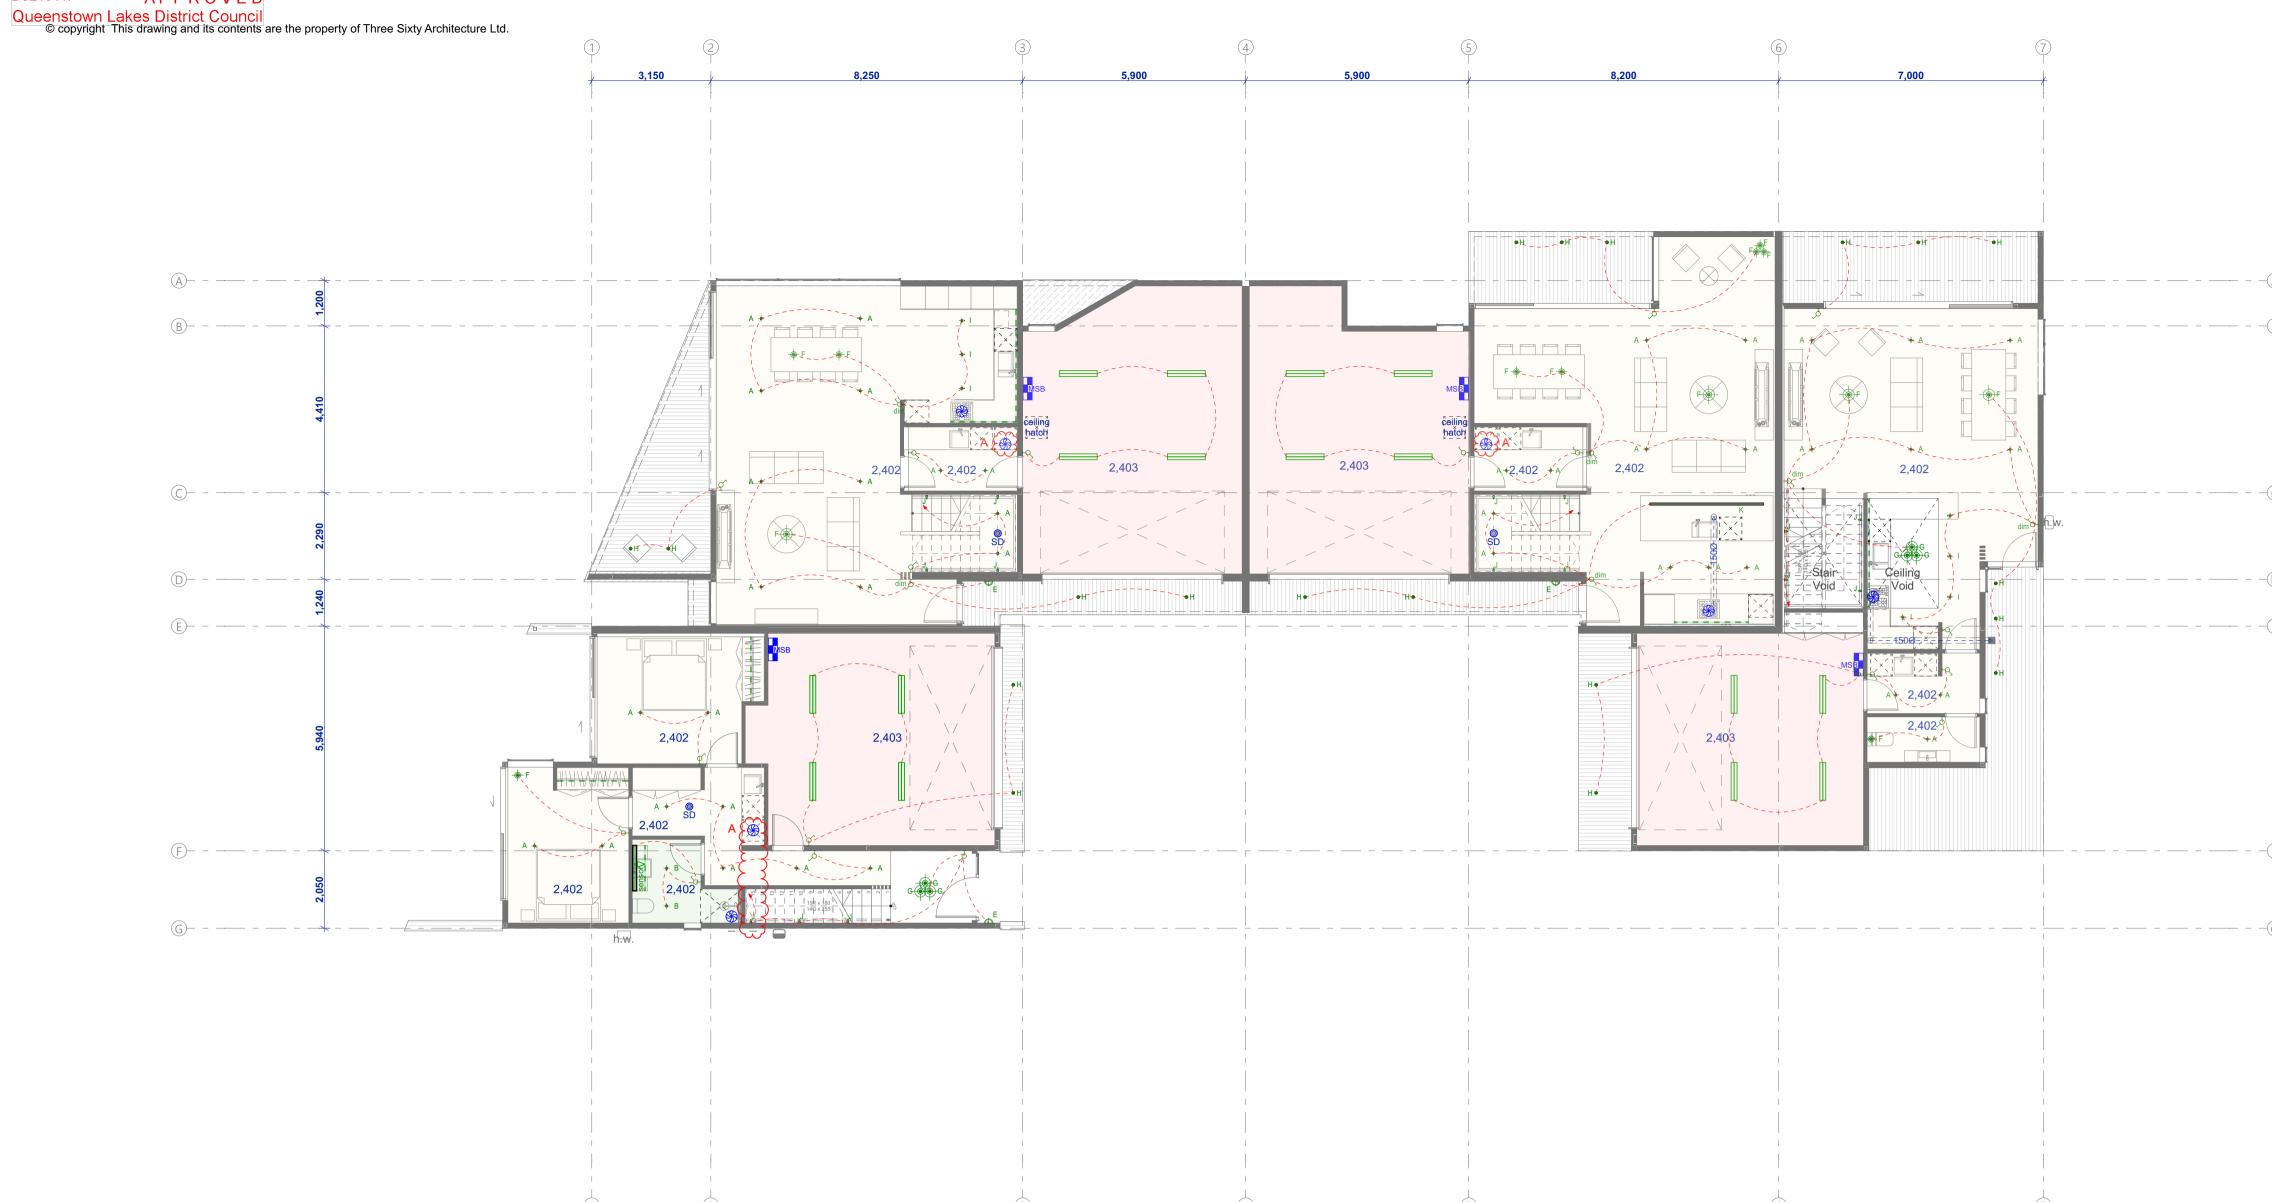

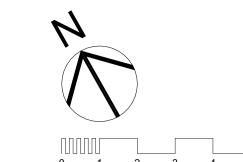

Lighting legend

+ A Recessed LED downlight

- Recessed LED downlight IP rated
- Mini Spot LED downlight IP rated
- Wall mounted light fitting above bed
- Exterior wall mounted light fitting IP rated
- Pendant light fitting
- Feature pendant cluster
- Soffit mounted mini Spot LED downlight IP rated
- Directional recessed LED downlight
- Recessed LED low wall mounted stair light
- Suspended LED track
- ---- LED Strip integrated into joinery
- Surface Mounted Fluorescent light Light switch
- Dimmer Circuit
- Circuit Wire Smoke detector with hush facility


Lighting Notes


Installation of all light fittings must comply with fire regulations

Installation of smoke detection system to meet nzbc c1, including hush facility to all smoke

Ensure that all IP ratings of fittings is suited for their selected install location.


Ceiling legend

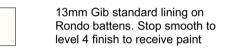

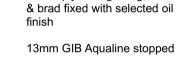

12mm ply ceiling lining, adhesive

smooth to level 4 finish ready for

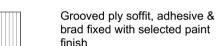

painted finish.

Cudoclad Alpolic FR composit aluminium soffit intergrated with

cladding system

Building Consent

All dimensions shall be verified on site by the contractor before starting any work or ordering any materials.
All work must comply with NZS 3604 2011 and the New Zealand Building Code.

Issue:
Building Consent Issue
Council RFI

Three Sixty Architecture



Chalmers Street Apartments 20 Chalmers Street Wanaka

L1 Reflected Ceiling Plan

1:100 Scale @ A1 R19015 File No. Date 9/06/2021 Revision

Sheet No.

210

Thee Sixty Architects Limited Level 1, The Yard 173 St Asaph Street Christchurch 8140


t: 03 366 3349

L2 RCP Scale 1:100





Issue:
Building Consent Issue
Council RFI

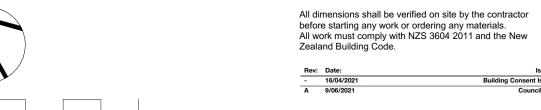

+ A Recessed LED downlight

- Recessed LED downlight IP rated
- Mini Spot LED downlight IP rated
- Wall mounted light fitting above bed Exterior wall mounted light fitting IP rated
- Pendant light fitting
- Feature pendant cluster
- Soffit mounted mini Spot LED downlight IP rated
- Directional recessed LED downlight
- Recessed LED low wall mounted stair light
- Suspended LED track
- LED Strip integrated into joinery LED Mirror light
- Surface Mounted Fluorescent light
- Light switch Dimmer Circuit
- Circuit Wire
- Smoke detector with hush facility

Lighting Notes

Installation of all light fittings must comply with fire regulations


Installation of smoke detection system to meet nzbc c1, including hush facility to all smoke

Ensure that all IP ratings of fittings is suited for their selected install location.


Ceiling legend



13mm Gib standard lining on Rondo battens. Stop smooth to level 4 finish to receive paint

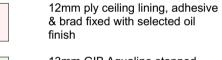

13mm GIB Aqualine stopped smooth to level 4 finish ready for painted finish.

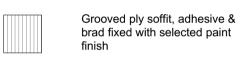

Cudoclad Alpolic FR composit aluminium soffit intergrated with

cladding system

Three Sixty Architecture



Chalmers Street Apartments 20 Chalmers Street Wanaka

L2 Reflected Ceiling Plan


1:100 Scale @ A1 File No. R19015 Date 9/06/2021 Revision

Sheet No.

211

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L0 Electrical Plan

Electrical legend

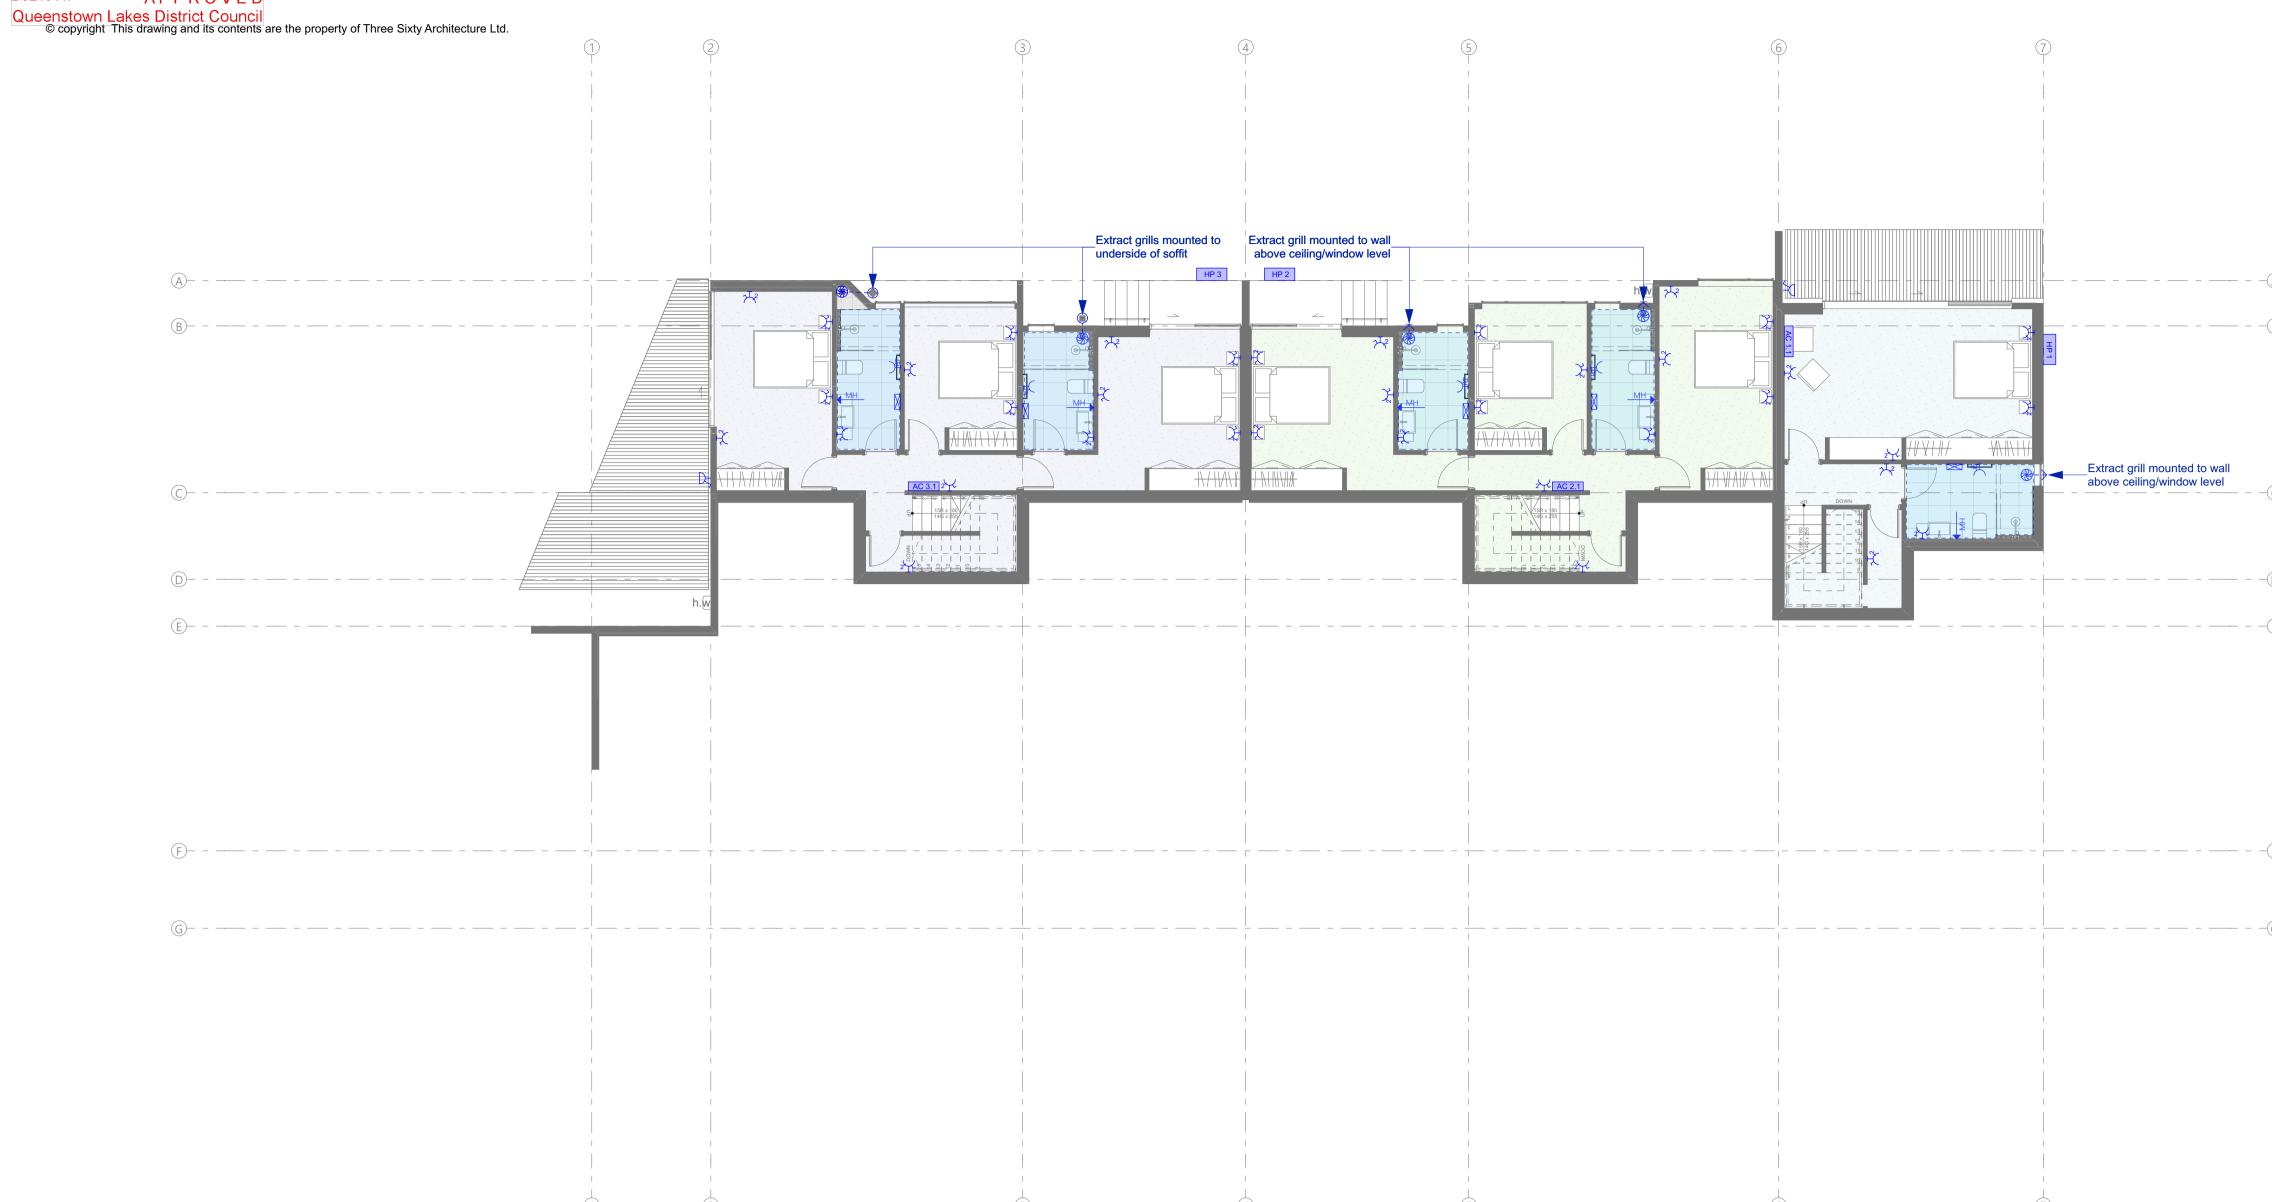Automatic garage door opener (switched off nearest light panel)

Double switched outlet Waterproof external socket

ct - Cook top hwc - Hot Water Cylinder

> Dedicated switched outlet RH - Range hood WM - Multifunction Microwave DW - Dishwasher WD - Waste disposal FF - Fridge freezer HT - Heated towel rail

Dedicated supply

Phone connection (Run to DB board)

TV Aerial socket CAT 6E Data socket (Run to DB Board)

WIFI / Fibre Termination Point (Owner to supply Wireless unit.)

Main switch board Data demarcation board + phone patch panel

Meterboard with remote metering Wall mounted AC unit

Outdoor Heat Pump Mirror anti-mist heater

Bathroom Heater (switch on light panel)

Extract fan (switch on light panel) Flexiduct path to exterior outlet

Under tile heating zones

Door bell / chime

Bell Button

Satellite dish

Misc.. water supply (Fridge freezer) Irrigation timer panel Security legend:

Keypad Security control panel Exterior siren

Electrical Notes

Installation of all fan extracts must provide at least 25 l/s extract vent

Limit water temperature at 55deg tempering valve must be supplied where sanitary fittings are used for personal hygiene

Security system as separate contract to be arranged by owner. allow to co-ordinate as

necessary during construction. Entertainment systems as separate contract to be arranged by owner. allow to co-ordinate as necessary during construction.

Allow to coordinate TV aerial and satellite dish on site. to be descreatly positioned on roof away from view.

Building Consent

All dimensions shall be verified on site by the contractor before starting any work or ordering any materials. All work must comply with NZS 3604 2011 and the New Zealand Building Code.

Issue: Building Consent Issue

Three Sixty Architecture



Chalmers Street Apartments 20 Chalmers Street Wanaka

L0 Electrical Plan


Scale @ A1 1:100 R19015 File No. Date 9/06/2021 Revision

Sheet No.

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L1 Electrical Plan

Electrical legend

Automatic garage door opener (switched off nearest light panel)

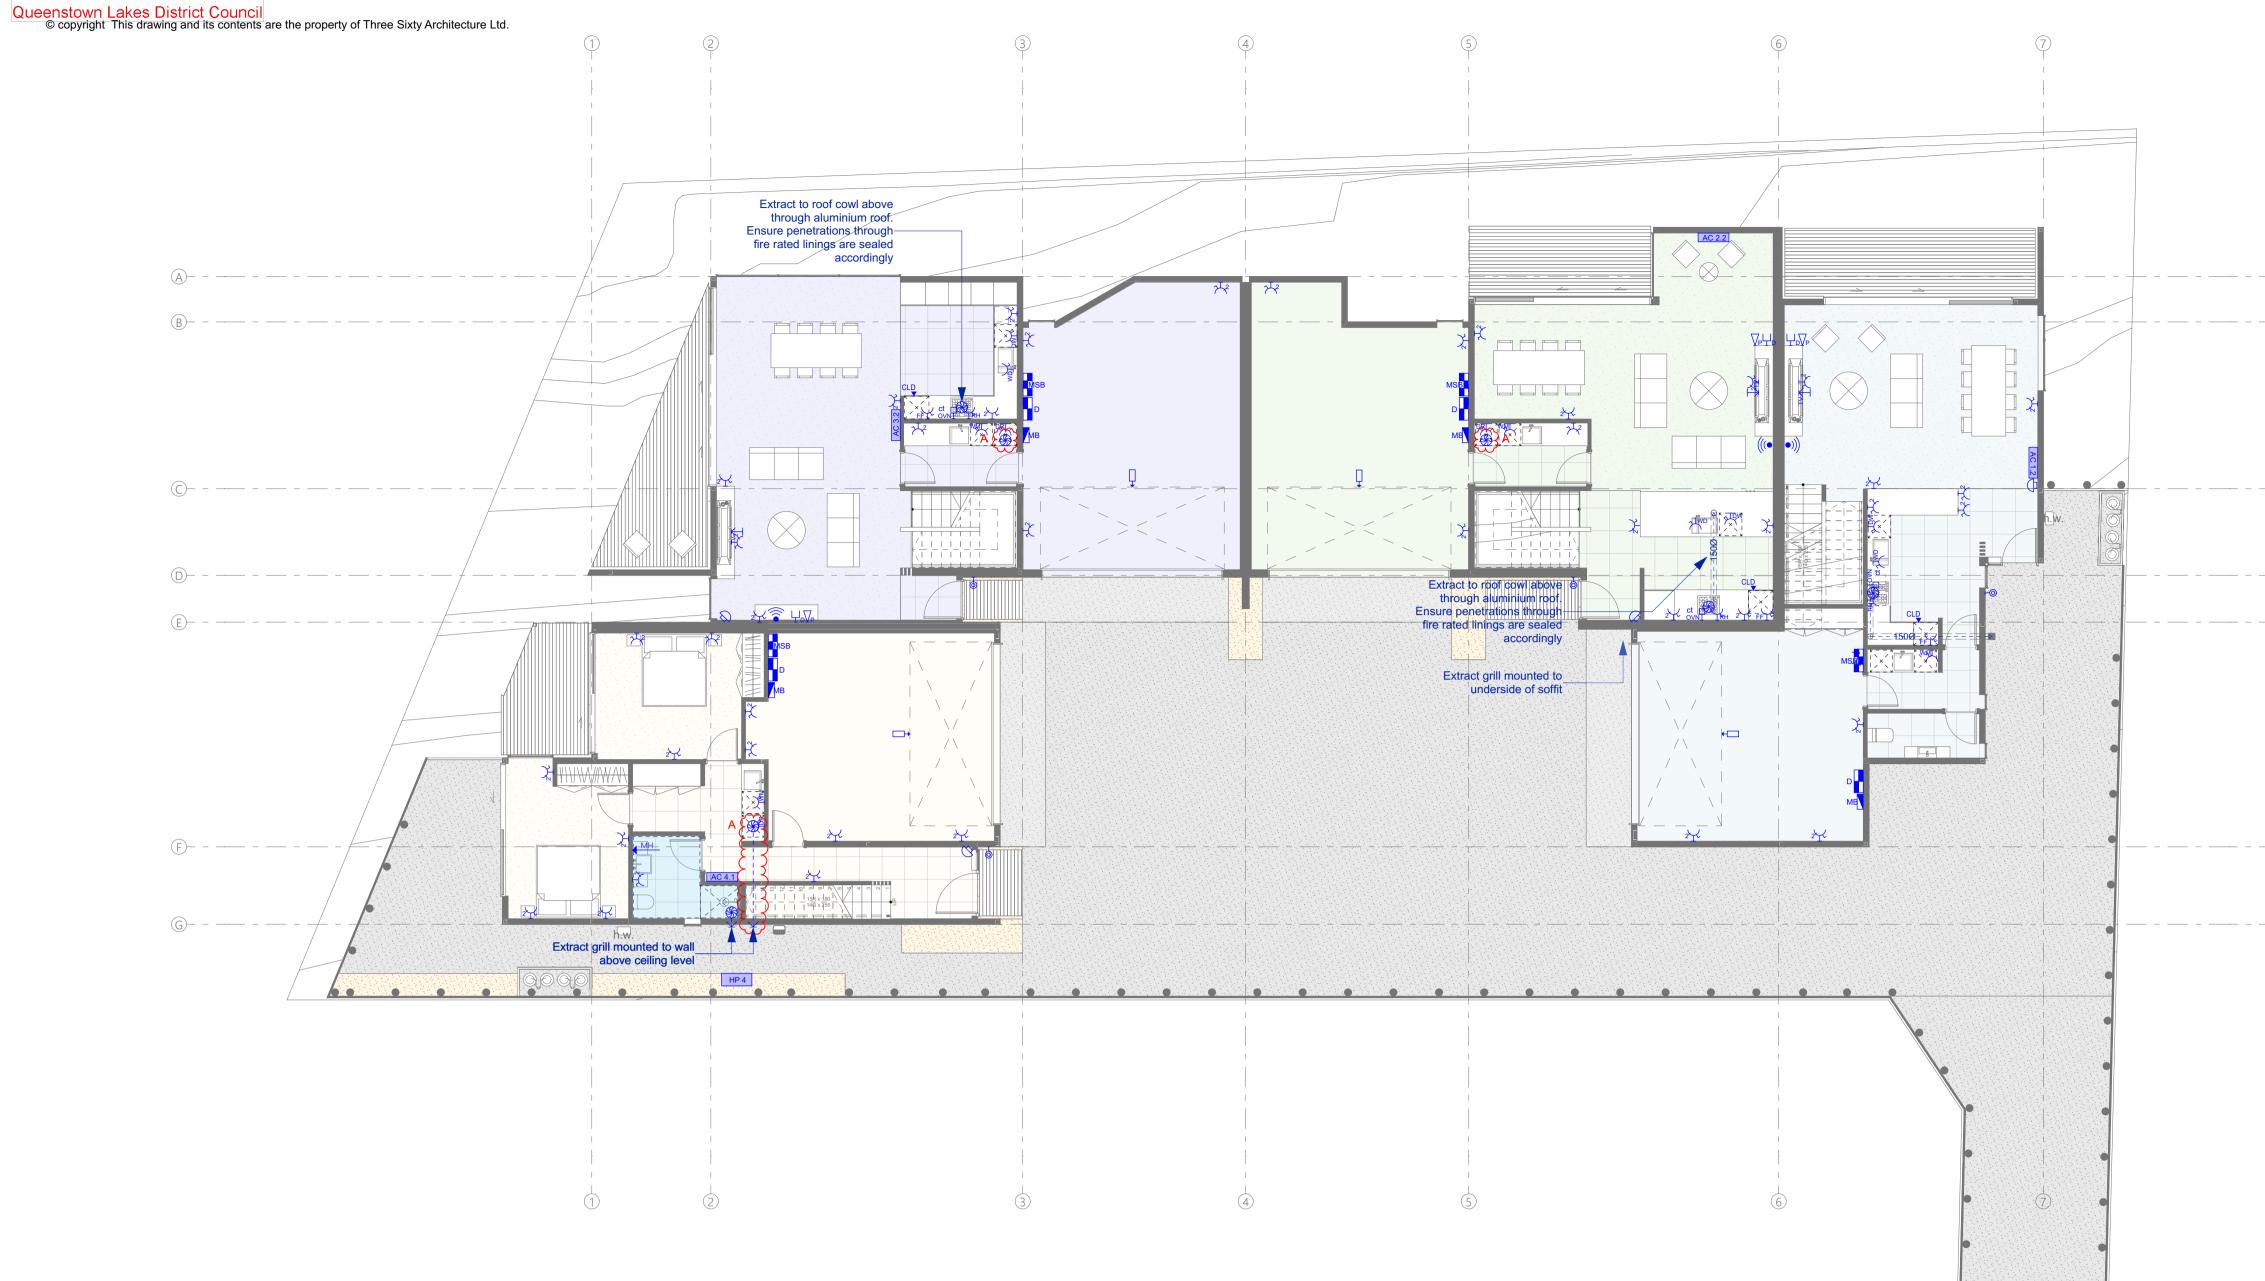Double switched outlet

Waterproof external socket

Dedicated supply

ct - Cook top

ovn - oven

hwc - Hot Water Cylinder

Dedicated switched outlet
RH - Range hood
WM - Multifunction Microwave
DW - Dishwasher
WD - Waste disposal
FF - Fridge freezer

HT - Heated towel rail
Phone connection (Run to DB board)

TV Aerial socket

CAT 6E Data socket (Run to DB Board)

WIFI / Fibre Termination Point (Owner to supply Wireless unit.)

Main switch board

Data demarcation board + phone patch panel

Meterboard with remote metering

Wall mounted AC unit
Outdoor Heat Pump
Mirror anti-mist heater

Bathroom Heater (switch on light panel)

Extract fan (switch on light panel)

Flexiduct path to exterior outlet

Under tile heating zones

☐ Door bell / chime

P Bell Button

TV Aerial

Satellite dish

Misc.. Services:

Misc.. water supply (Fridge freezer)

Irrigation timer panel

Security legend:

Keypad
Security control page

Security control panel
Sensor
Exterior siren

Electrical Notes

Installation of all fan extracts must provide at least 25 l/s extract vent

Limit water temperature at 55deg tempering valve must be supplied where sanitary fittings are used for personal hygiene

Security system as separate contract to be arranged by owner. allow to co-ordinate as necessary during construction.

Entertainment systems as separate contract to be arranged by owner. allow to co-ordinate as necessary during construction.

Allow to coordinate TV aerial and satellite dish on site. to be descreatly positioned on roof away from view.

Building Consent

Notes :

All dimensions shall be verified on site by the contractor before starting any work or ordering any materials. All work must comply with NZS 3604 2011 and the New Zealand Building Code.

 Rev:
 Date:
 Issue:

 16/04/2021
 Building Consent Issue

 A
 9/06/2021
 Council RFI

Three Sixty Architecture



Chalmers Street
Apartments
20 Chalmers Street
Wanaka


L1 Electrical Plan

Scale @ A1 1:100
File No. R19015
Date 9/06/2021
Revision A

Sheet No. **213**

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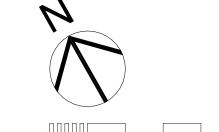


L2 Electrical Plan

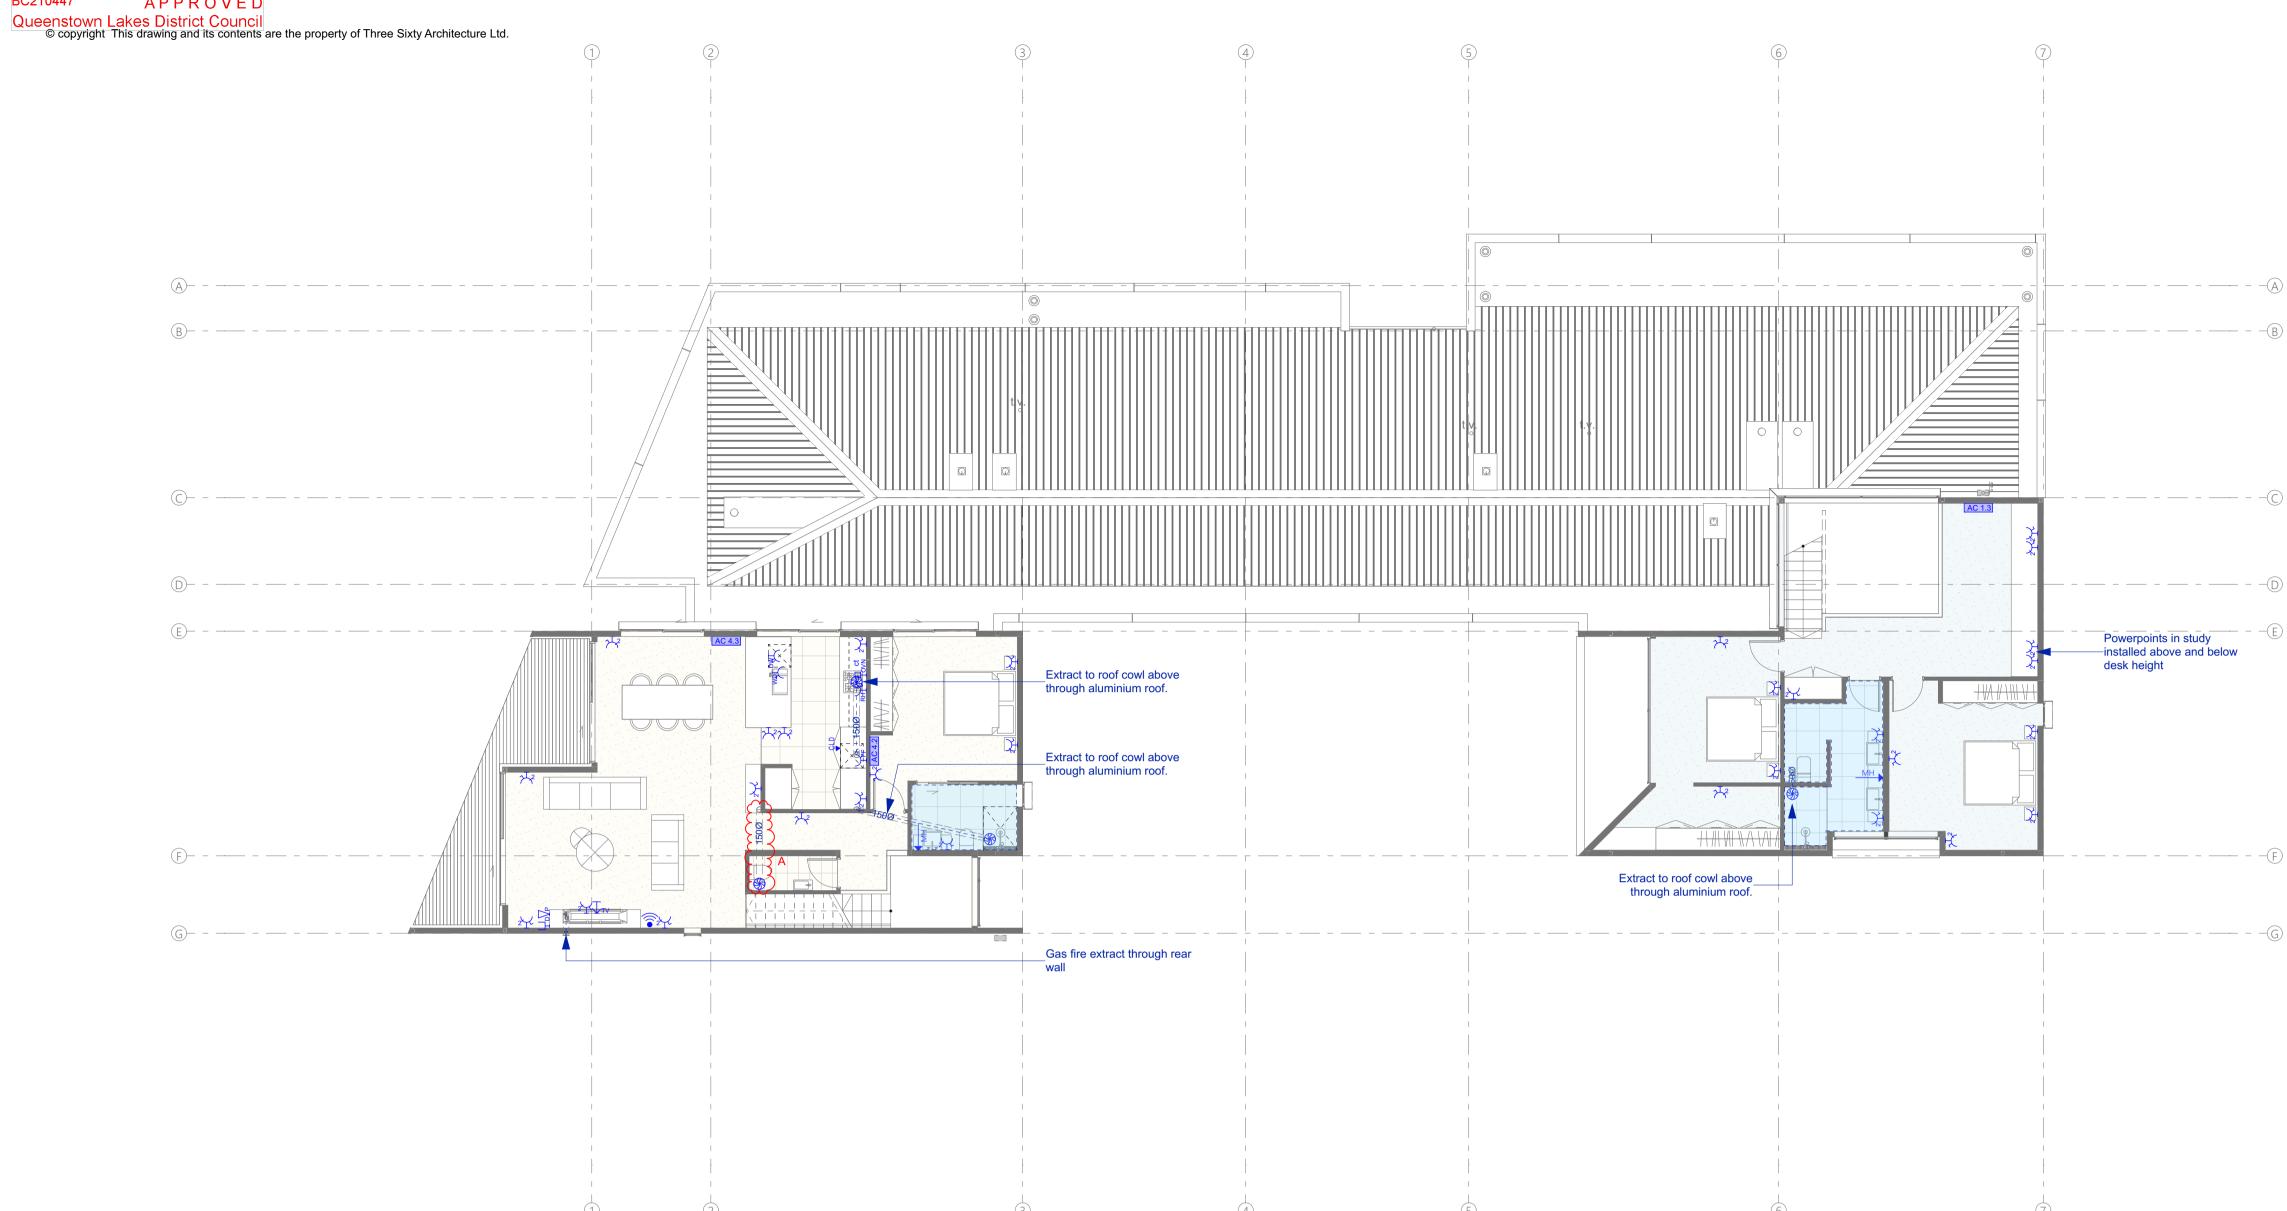

All dimensions shall be verified on site by the contractor before starting any work or ordering any materials.
All work must comply with NZS 3604 2011 and the New Zealand Building Code.

Issue:
Building Consent Issue
Council RFI



Electrical legend

Automatic garage door opener (switched off nearest light panel)

Double switched outlet Waterproof external socket

Dedicated supply ct - Cook top hwc - Hot Water Cylinder

> Dedicated switched outlet RH - Range hood WM - Multifunction Microwave DW - Dishwasher WD - Waste disposal

FF - Fridge freezer HT - Heated towel rail

Phone connection (Run to DB board) TV Aerial socket

CAT 6E Data socket (Run to DB Board)

WIFI / Fibre Termination Point (Owner to supply Wireless unit.)

Main switch board Data demarcation board + phone patch panel

Meterboard with remote metering

Wall mounted AC unit Outdoor Heat Pump

Mirror anti-mist heater Bathroom Heater (switch on light panel)

Extract fan (switch on light panel)

Under tile heating zones

Flexiduct path to exterior outlet

Door bell / chime Bell Button

Satellite dish

Misc.. water supply (Fridge freezer)

Irrigation timer panel Security legend:

Keypad Security control panel Exterior siren

Electrical Notes

Installation of all fan extracts must provide at least 25 l/s extract vent

Limit water temperature at 55deg tempering valve must be supplied where sanitary fittings are used for personal hygiene

Security system as separate contract to be arranged by owner. allow to co-ordinate as necessary during construction.

Entertainment systems as separate contract to be arranged by owner. allow to co-ordinate as necessary during construction.

Allow to coordinate TV aerial and satellite dish on site. to be descreatly positioned on roof away from view.

Three **Sixty Architecture**



Chalmers Street Apartments 20 Chalmers Street Wanaka

L2 Electrical Plan

Scale @ A1 1:100 File No. R19015 Date 9/06/2021 Revision


Sheet No.

214

Thee Sixty Architects Limited Level 1, The Yard 173 St Asaph Street Christchurch 8140

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BUILDING ENVELOPE RISK MATRIX		
North Elevation		
Risk Factor	Risk Severity	Risk Score
Wind zone (per NZS 3604)	Medium risk	0
Number of storeys	Very high risk	4
Roof/wall intersection design	High risk	3
Eaves width	Very high risk	5
Envelope complexity	High risk	3
Deck design	Medium risk	2
Total Risk Score:		17

East Elevation Scale 1:100	A B 4,410	C D E 1,240	5,940	2,050
				3.3.2
3.3.1	(3.2.2)—(3.1.7)—			
3.1.5				3.2.3 +311,400 First Floor
3.1.7 3.1.7				3.1.1
3.2.3 (3.1.8) (3.1.3)				+308,700 Ground Floor
(3.2.1) (3.1.5) (2.2.3)				
3.2.3				+306,000 Basement

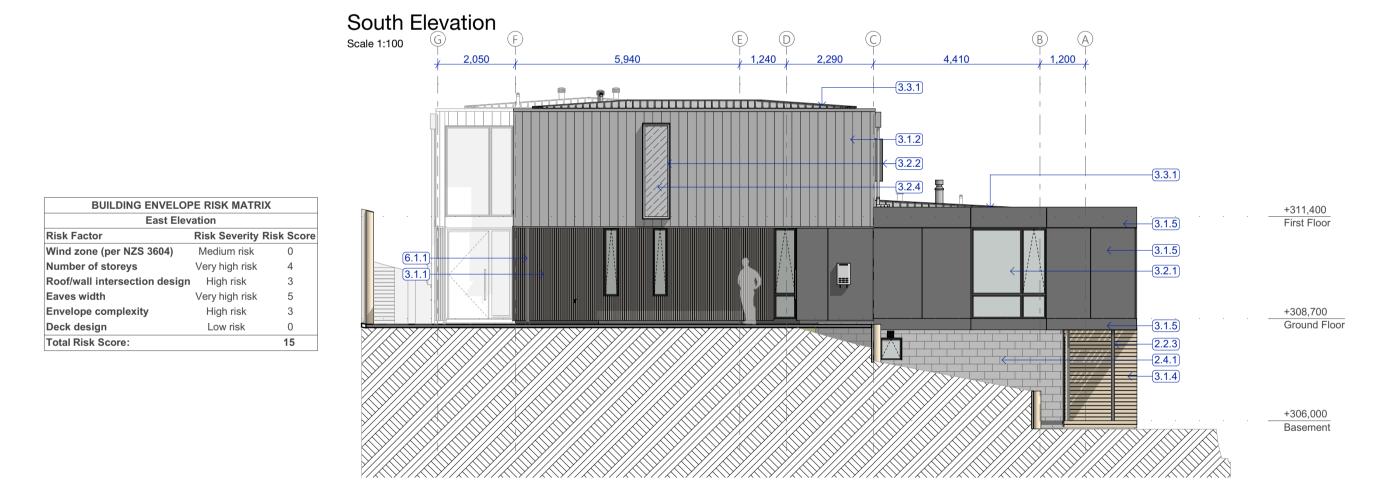West Elevation Scale 1:100

Building Consent

All dimensions shall be verified on site by the contractor before starting any work or ordering any materials.
All work must comply with NZS 3604 2011 and the New Zealand Building Code.

Issue:
Building Consent Issue
Council RFI

packing proposed. 20 Series Concrete Block Exterior 2.4.1 20 Series concrete block. Refer to Structural Engineer's documentation. Allow for sealer/render coat and paint finish to exposed faces. 3.1.1 Vert. Shiplap wall cladding
Rosenfeld Kidson RK58 vertical shiplap timber cladding over 45mm structural cavity

89x6 SHS. Refer to Structural Engineer's

documentation. Refer to Specification for

paint finish where steelwork is exposed. Ensure separation layer to timber where

2.2.3 SHS 89x89

battens. Finish with selected Drydens oil. Installed as per the manufacturers documentation. (studs @ 600crs, Dwangs 3.1.2 Flashclad Euro-line Vertically fixed Euro-line powdercoated aluminium cladding. Installed as per the

manufacturers documentation, by
Flashclad nationwide distribution network.
(studs @ 600crs, Dwangs @ 800crs)
Vertical Cedar Batten Vertical 40x40 cedar batten rainscreen @ 100crs over 45mm H3.2 cavity battens (painted out black) over Titan Facade panel cladding system on 70x19mm CLD structural cavity batten. Finish with selected Drydens oil. 3.1.4 Horizontal Cedar Batten

Horizontal 60x20 cedar batten over 45mm H3.2 cavity battens (painted out black) over Concrete block walls. Finish with selected Drydens oil.
3.1.5 Cudoclad Alpolic FR Cudoclad Alpolic FR composit aluminium

cladding system installed by qualified

installers in accordance with the maufacturers documents. 3.1.6 Colorsteel Garage Door Colorsteel Sarage Book
Colorsteel sectional insulated garage door
with low head room gear. Install with Ex.
280x30mm cedar reveals rebated for
linings and cladding finished with selected

Drydens Oil.
3.1.7 Louvre 140x10mm powdercoated steel flat screw fixed both sides of 90x45 timber LVL post. Post fixed at top and bottom. Refer to Structural Engineer's documentation.

3.1.8 Decorative Steel Plate

9mm zinc sprayed & powdercoated steel plate to external face FW to RHS. Refer to Structural Engineer's documentation. 3.2.1 Aluminium windows and doors Vantage Pacific Thermal System aluminium joinery. Double glazed IGUs with Argon gas and Low E coating. Powdercoat finish to

aluminium members.

3.2.2 Powdercoated Aluminium Window 6mm Powdercoated aluminium window frame with 5deg fall at head & sill. Shop drawing and installation by Flashclad nationwide distribution network. Allow to pack out cladding to ensure a min. 30mm cavity to entire face.
3.2.3 External Glass Balustrade

Metro 12mm Monolithic TEMPAFLOAT glass on Posiglaze PG120S Hardware System. Toughened with S25 interlinking capping rail to top. Refer to Metro glass details/PS1 for further information

+306,000

Window screen Perforated powdercoated aluminium screen fixed to window frame extrusion

Colorsteel roofing
Metalcraft Colorsteel T-Rib roofing over selected roofing underlay & wire mesh screw fixed to top of purlins. Prefinished Colorsteel Endura finish 3.3.2 Torch-on membrane

Viking Torch-on Lybra SBS Waterproofing membrane installed in accordance with the product manual. Over 17mm H3.2 CCA treated plywood supported at 400crs. 3.3.3 Parapet Flashing
0.55 BMT Parapet flashing with 5 degree fall to roof and 70mm cover to cladding. Provide concealed clip fixings to exterior

face. Colour as per schedule 6.1.1 Downpipe 80Ø Colorsteel DP with matching munzing ring standoff brackets at 1200mm crs.

Refer to finishes schedule for colour. 6.1.2 Folded Colorsteel Rainwater head with overflow outlet to discharge into Colorsteel RHW to be folded colorsteel to match wall cladding. Overflow opening 1.5 x cross sectional area of downpipe

External Gutter Architectural folded colorsteel external gutter 'profile A' with hidden clip fixings. Refer to roof plan for dimensions

Three Sixty Architecture



Chalmers Street Apartments 20 Chalmers Street Wanaka

Elevations

Scale @ A1 1:100 File No. R19015 Date 9/06/2021 Revision Sheet No.

301


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2 First Floor +311,400 1 Ground Floor +308,700 0 Basement +306,000



Building Consent

Notes :

2.1.1 Concrete slab on grade

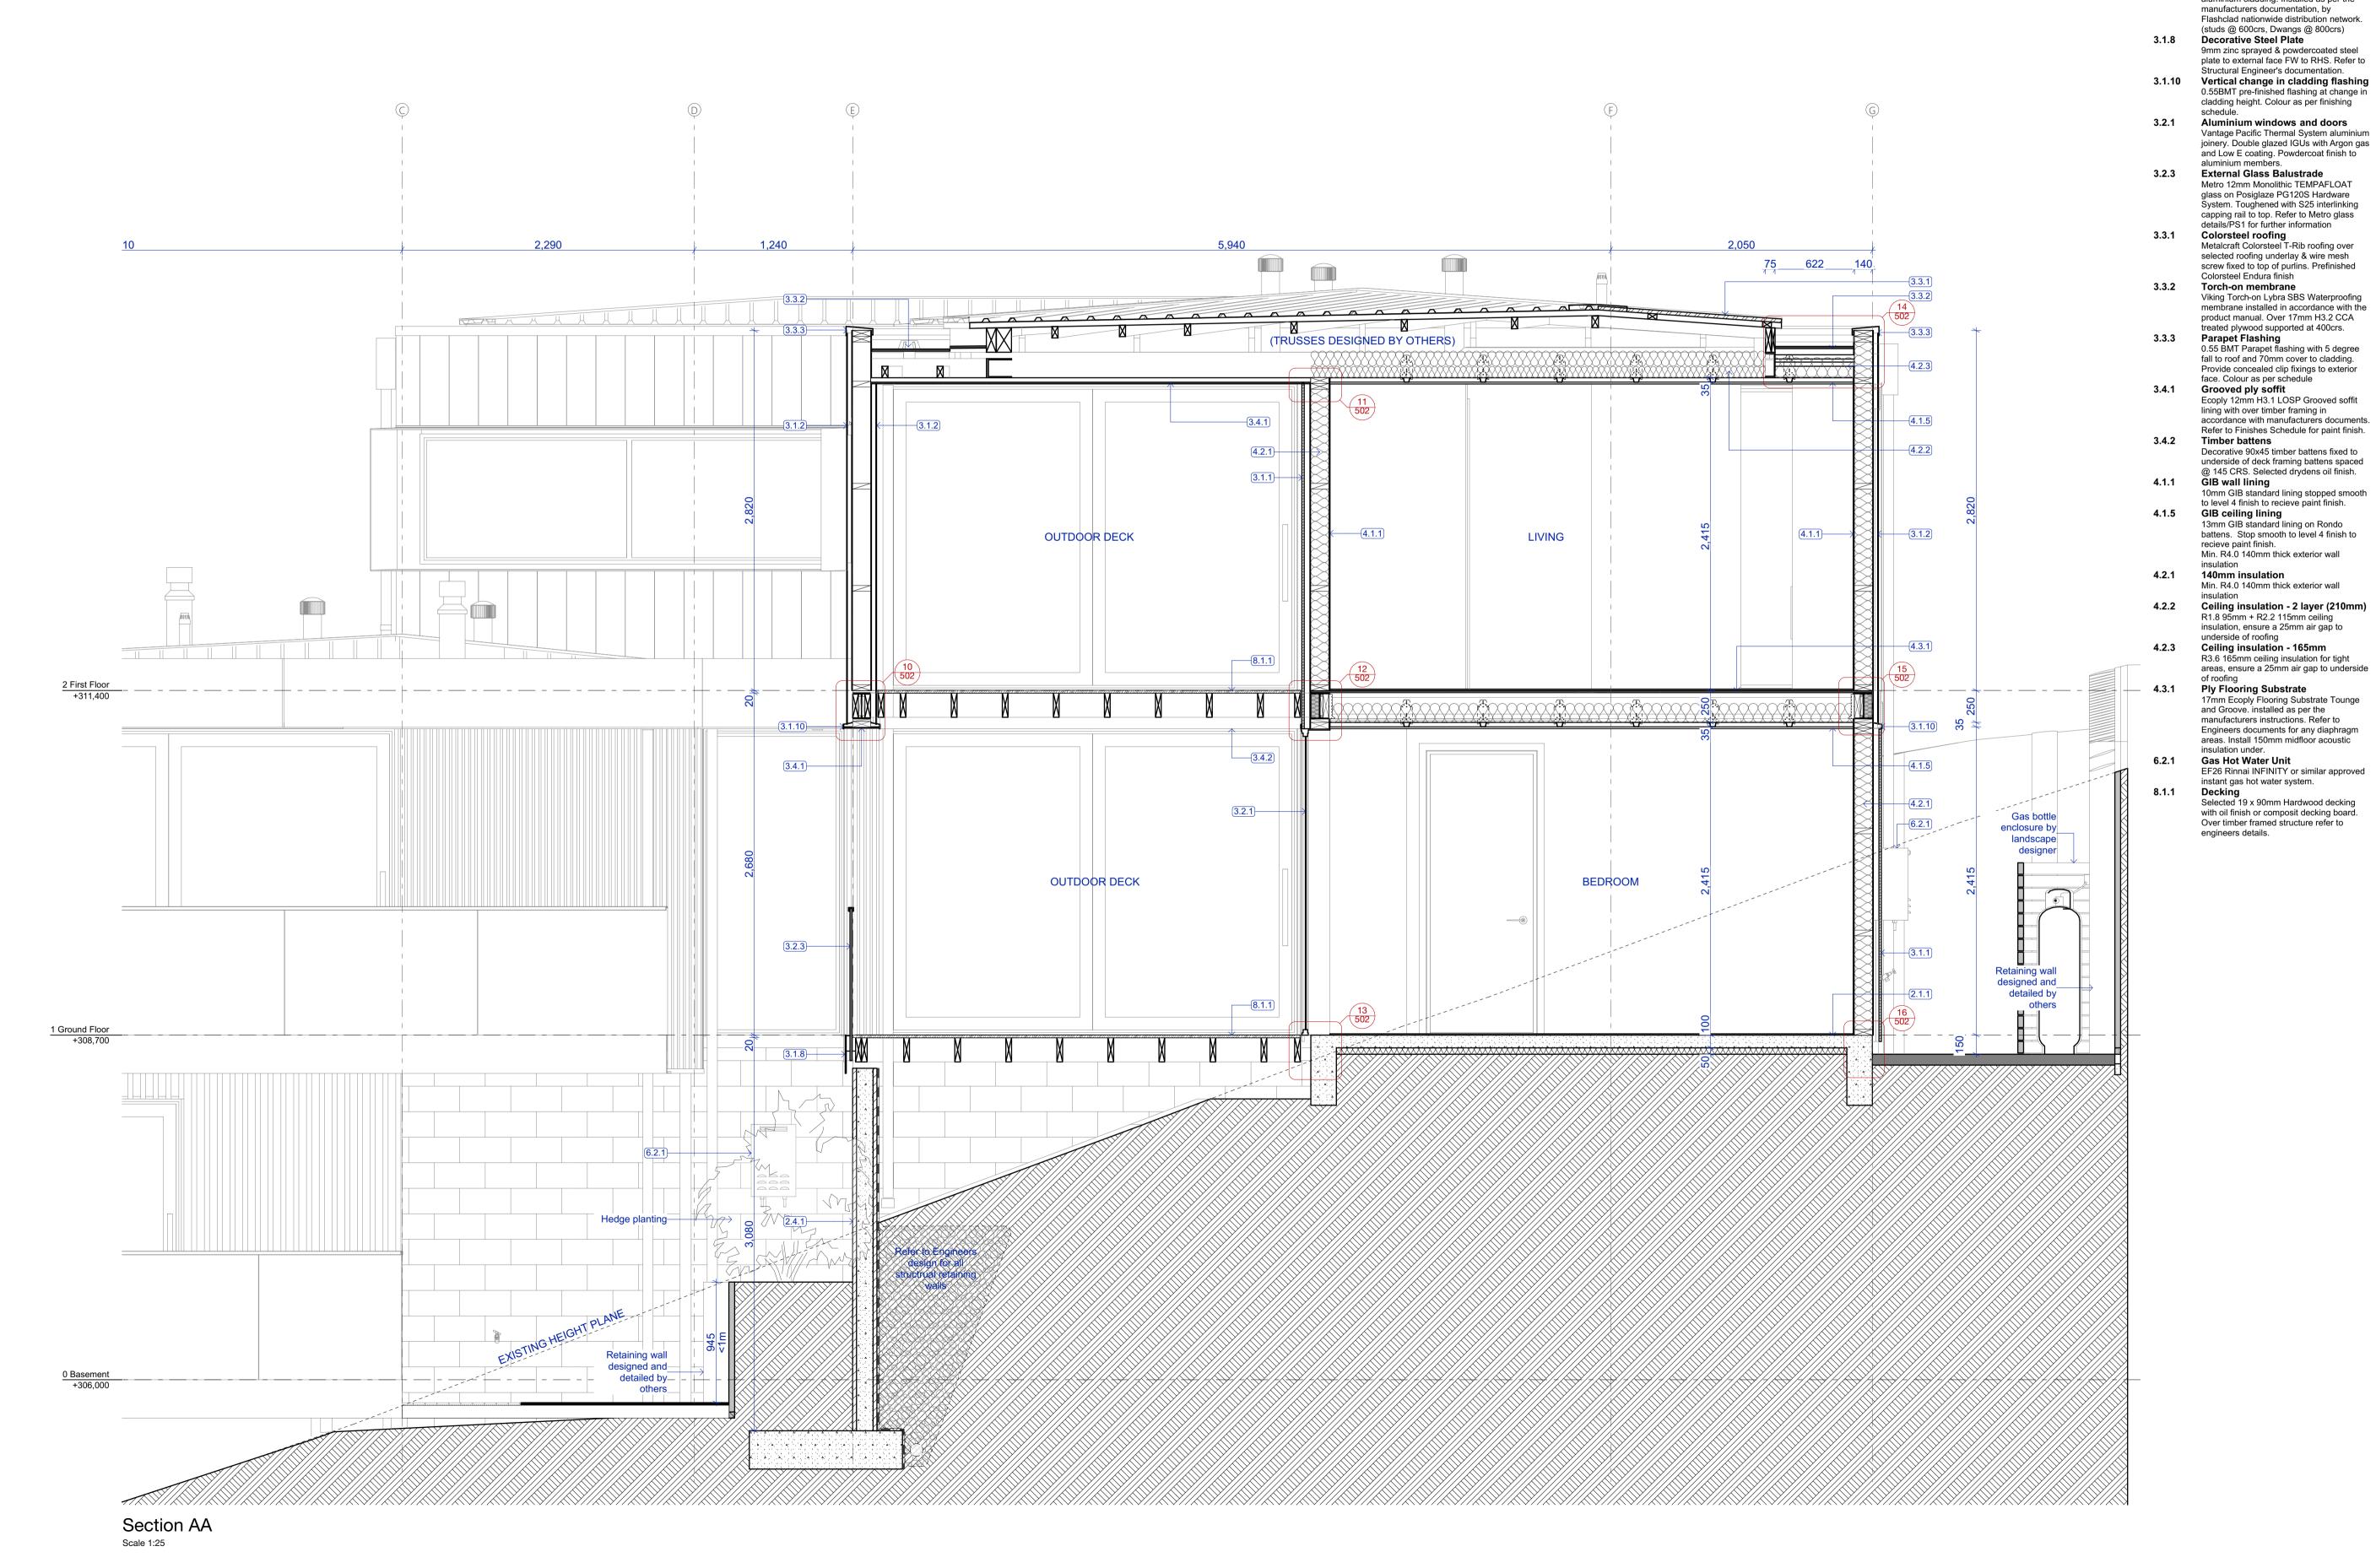exposed faces.

@ 800crs)
3.1.2 Flashclad Euro-line

3.1.1 Vert. Shiplap wall cladding
Rosenfeld Kidson RK58 vertical shiplap
timber cladding over 45mm structural cavity
battens. Finish selected brydens oil.

2.4.1

100mm concrete slab over 50mm XPS

polestyrene on DPM on grade. Refer

Structural Engineer's documentation.

20 Series Concrete Block Exterior Wall
20 Series concrete block. Refer to

Structural Engineer's documentation. Allow for sealer/render coat and paint finish to

Installed as per the manufacturers documentation. (studs @ 600crs, Dwangs

Vertically fixed Euro-line powdercoated aluminium cladding. Installed as per the

All dimensions shall be verified on site by the contractor before starting any work or ordering any materials.
All work must comply with NZS 3604 2011 and the New Zealand Building Code.

 Rev:
 Date:
 Issue:

 16/04/2021
 Building Consent Issue

Three Sixty Architecture



Chalmers Street
Apartments
20 Chalmers Street
Wanaka

Section A

 Scale @ A1
 1:25, 1:250

 File No.
 R19015

 Date
 9/06/2021

 Revision

401


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2 First Floor +311,400 1 Ground Floor +308,700 0 Basement +306,000



Building Consent

Notes :

2.1.1 Concrete slab on grade

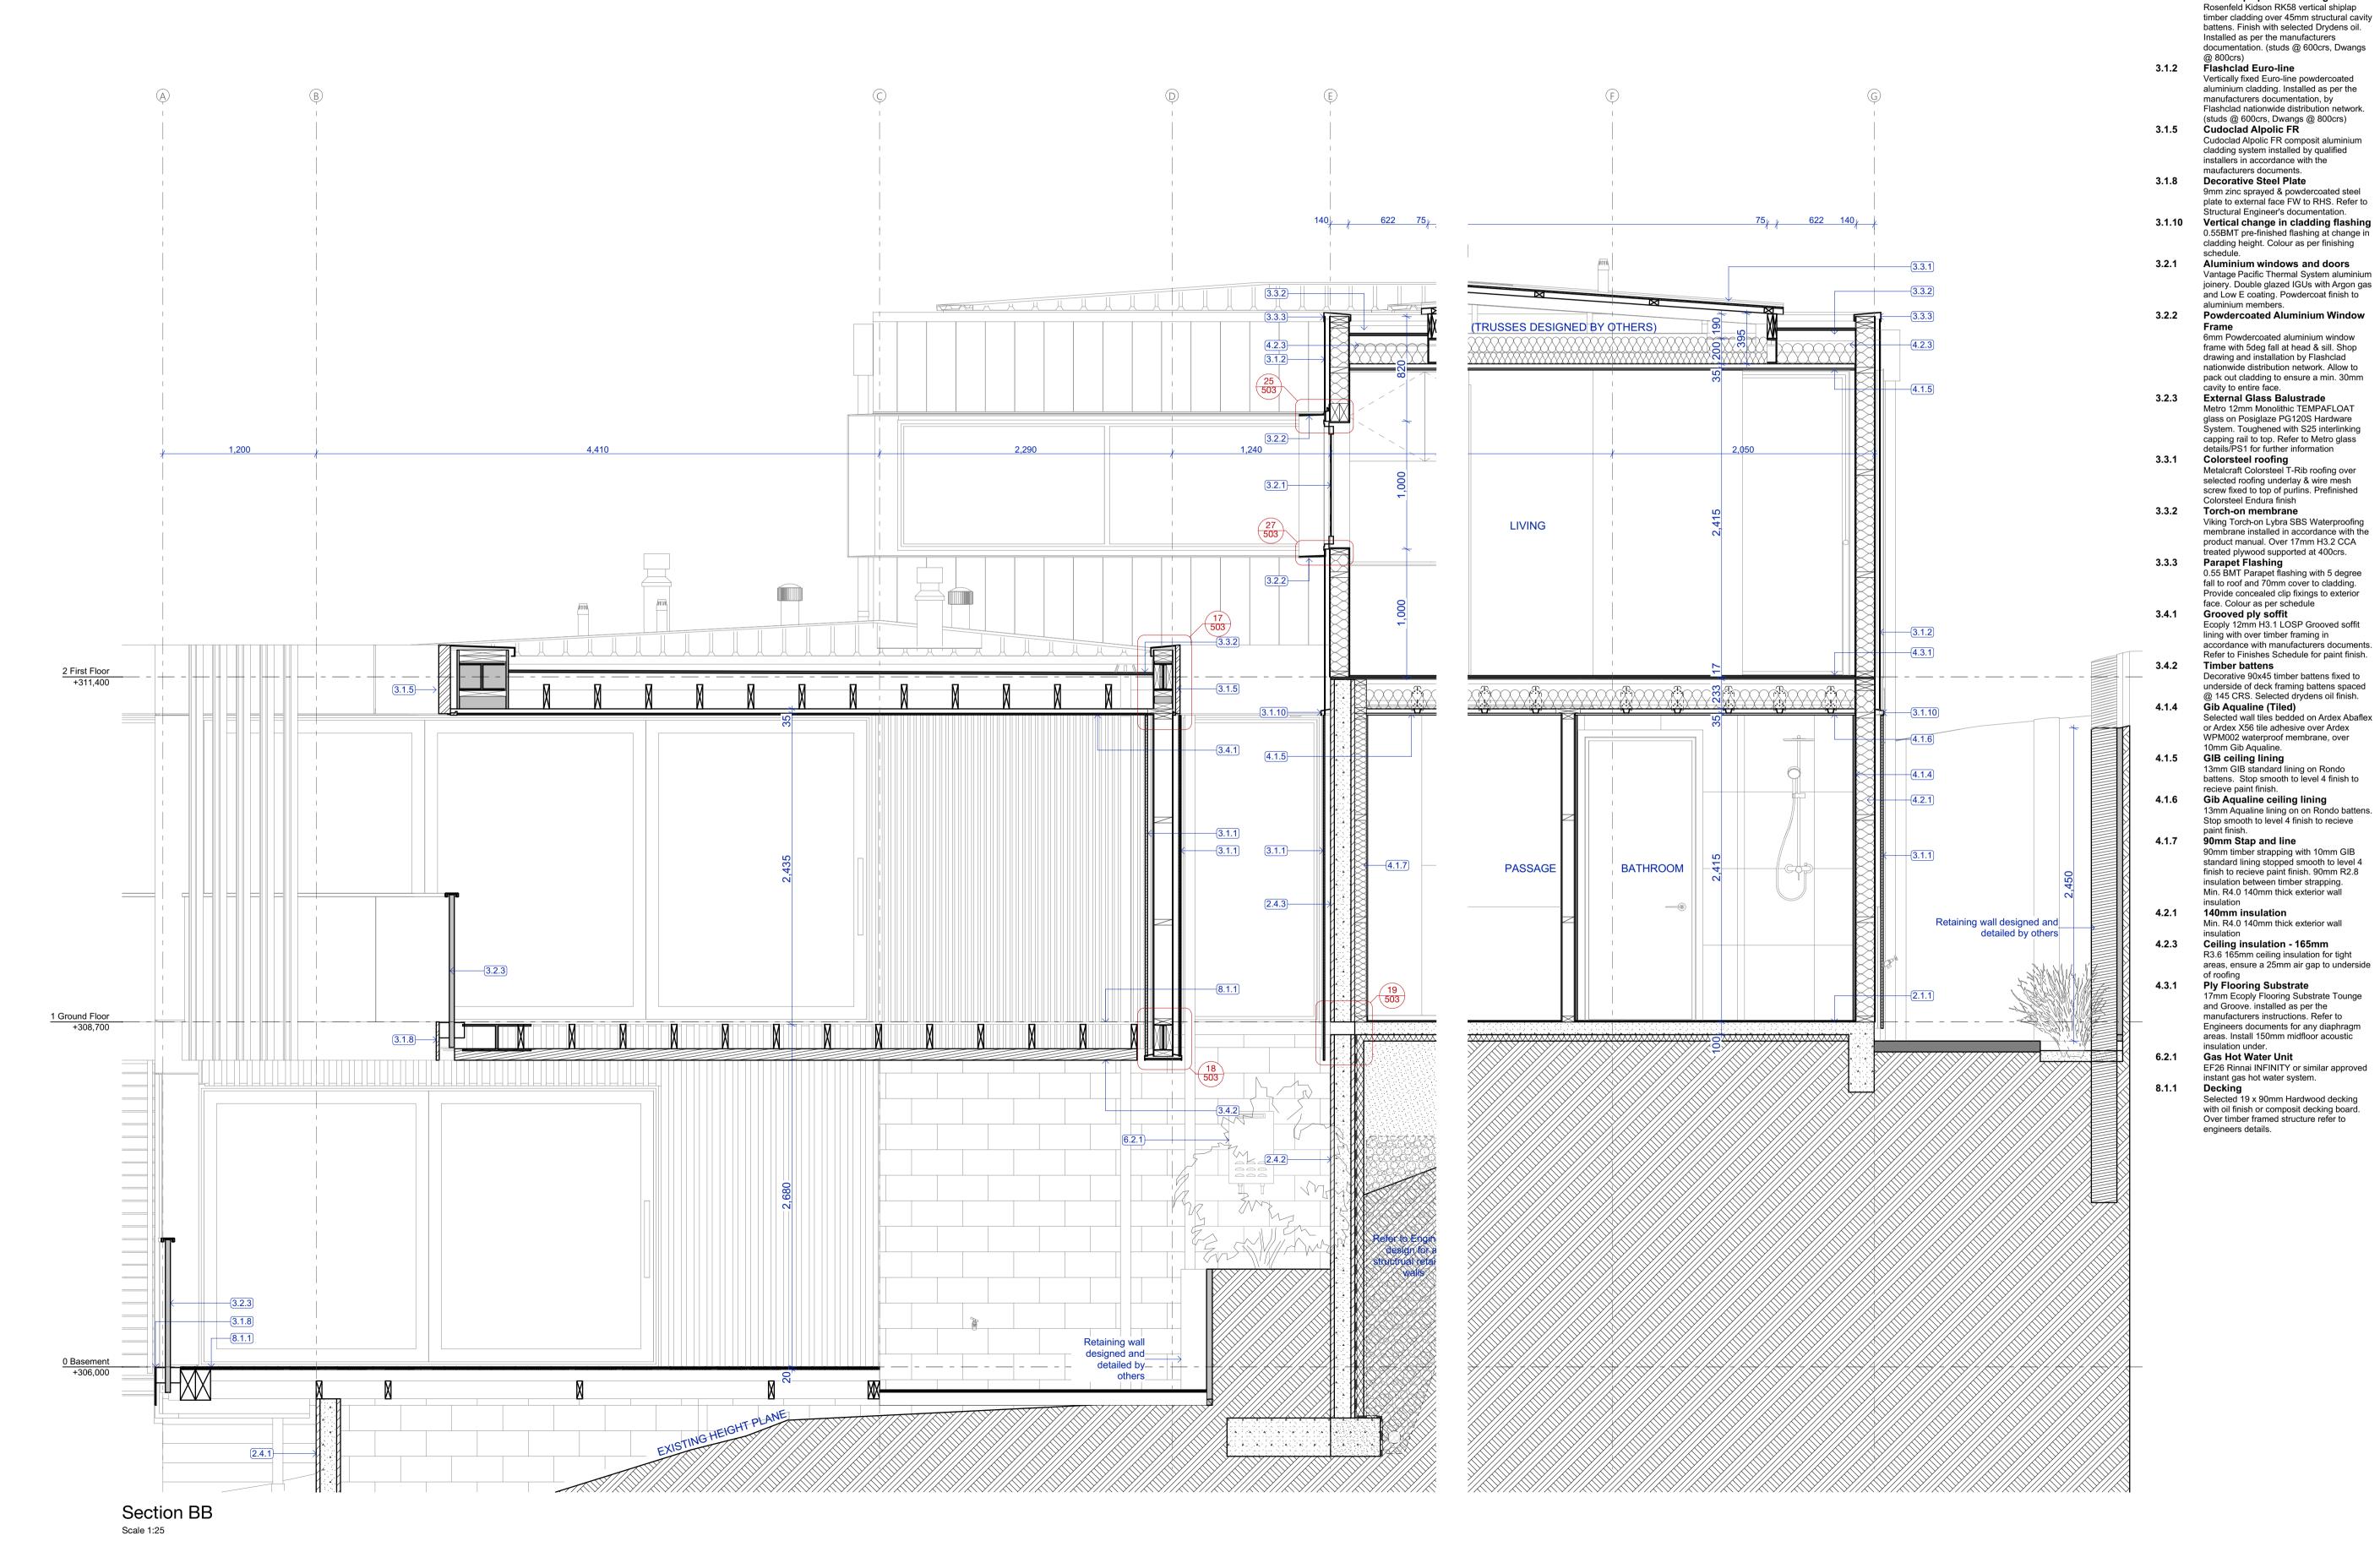exposed faces.

2.4.2 20 Series Concrete Block + Insulation

2.4.1

100mm concrete slab over 50mm XPS

polestyrene on DPM on grade. Refer

Structural Engineer's documentation.

20 Series concrete block. Refer to Structural Engineer's documentation. 70mm XPS insulation to external face intergral with the engineers retaining wall

20 Series concrete block. Refer to Structural Engineer's documentation.

2.4.3 20 Series Concrete Block Wall

3.1.1 Vert. Shiplap wall cladding

20 Series Concrete Block Exterior Wall
20 Series concrete block. Refer to

Structural Engineer's documentation. Allow for sealer/render coat and paint finish to

All dimensions shall be verified on site by the contractor before starting any work or ordering any materials.
All work must comply with NZS 3604 2011 and the New Zealand Building Code.

 Rev:
 Date:
 Issue:

 16/04/2021
 Building Consent Issue

Three Sixty Architecture



Chalmers Street
Apartments
20 Chalmers Street
Wanaka

Section B


Scale @ A1 1:25, 1:250
File No. R19015
Date 9/06/2021
Revision -


402

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Building Consent

All dimensions shall be verified on site by the contractor before starting any work or ordering any materials.
All work must comply with NZS 3604 2011 and the New Zealand Building Code.

Issue:
Building Consent Issue
Council RFI

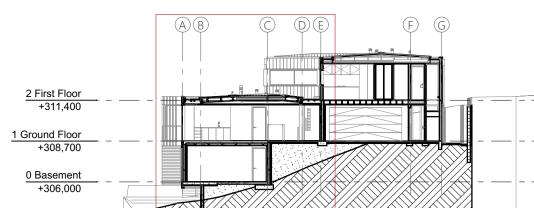Structural Engineer's documentation. 2.1.3 Stahlton floor Stahlton rib & infill with 125mm deep ribs and 100mm thick topping. Refer Structural Engineer's documentation 2.2.2 Steel HST purlins 200/15 DHS purlins @ 900mm crs. Refer to Structural Engineer's documentation.
2.4.1 20 Series Concrete Block Exterior

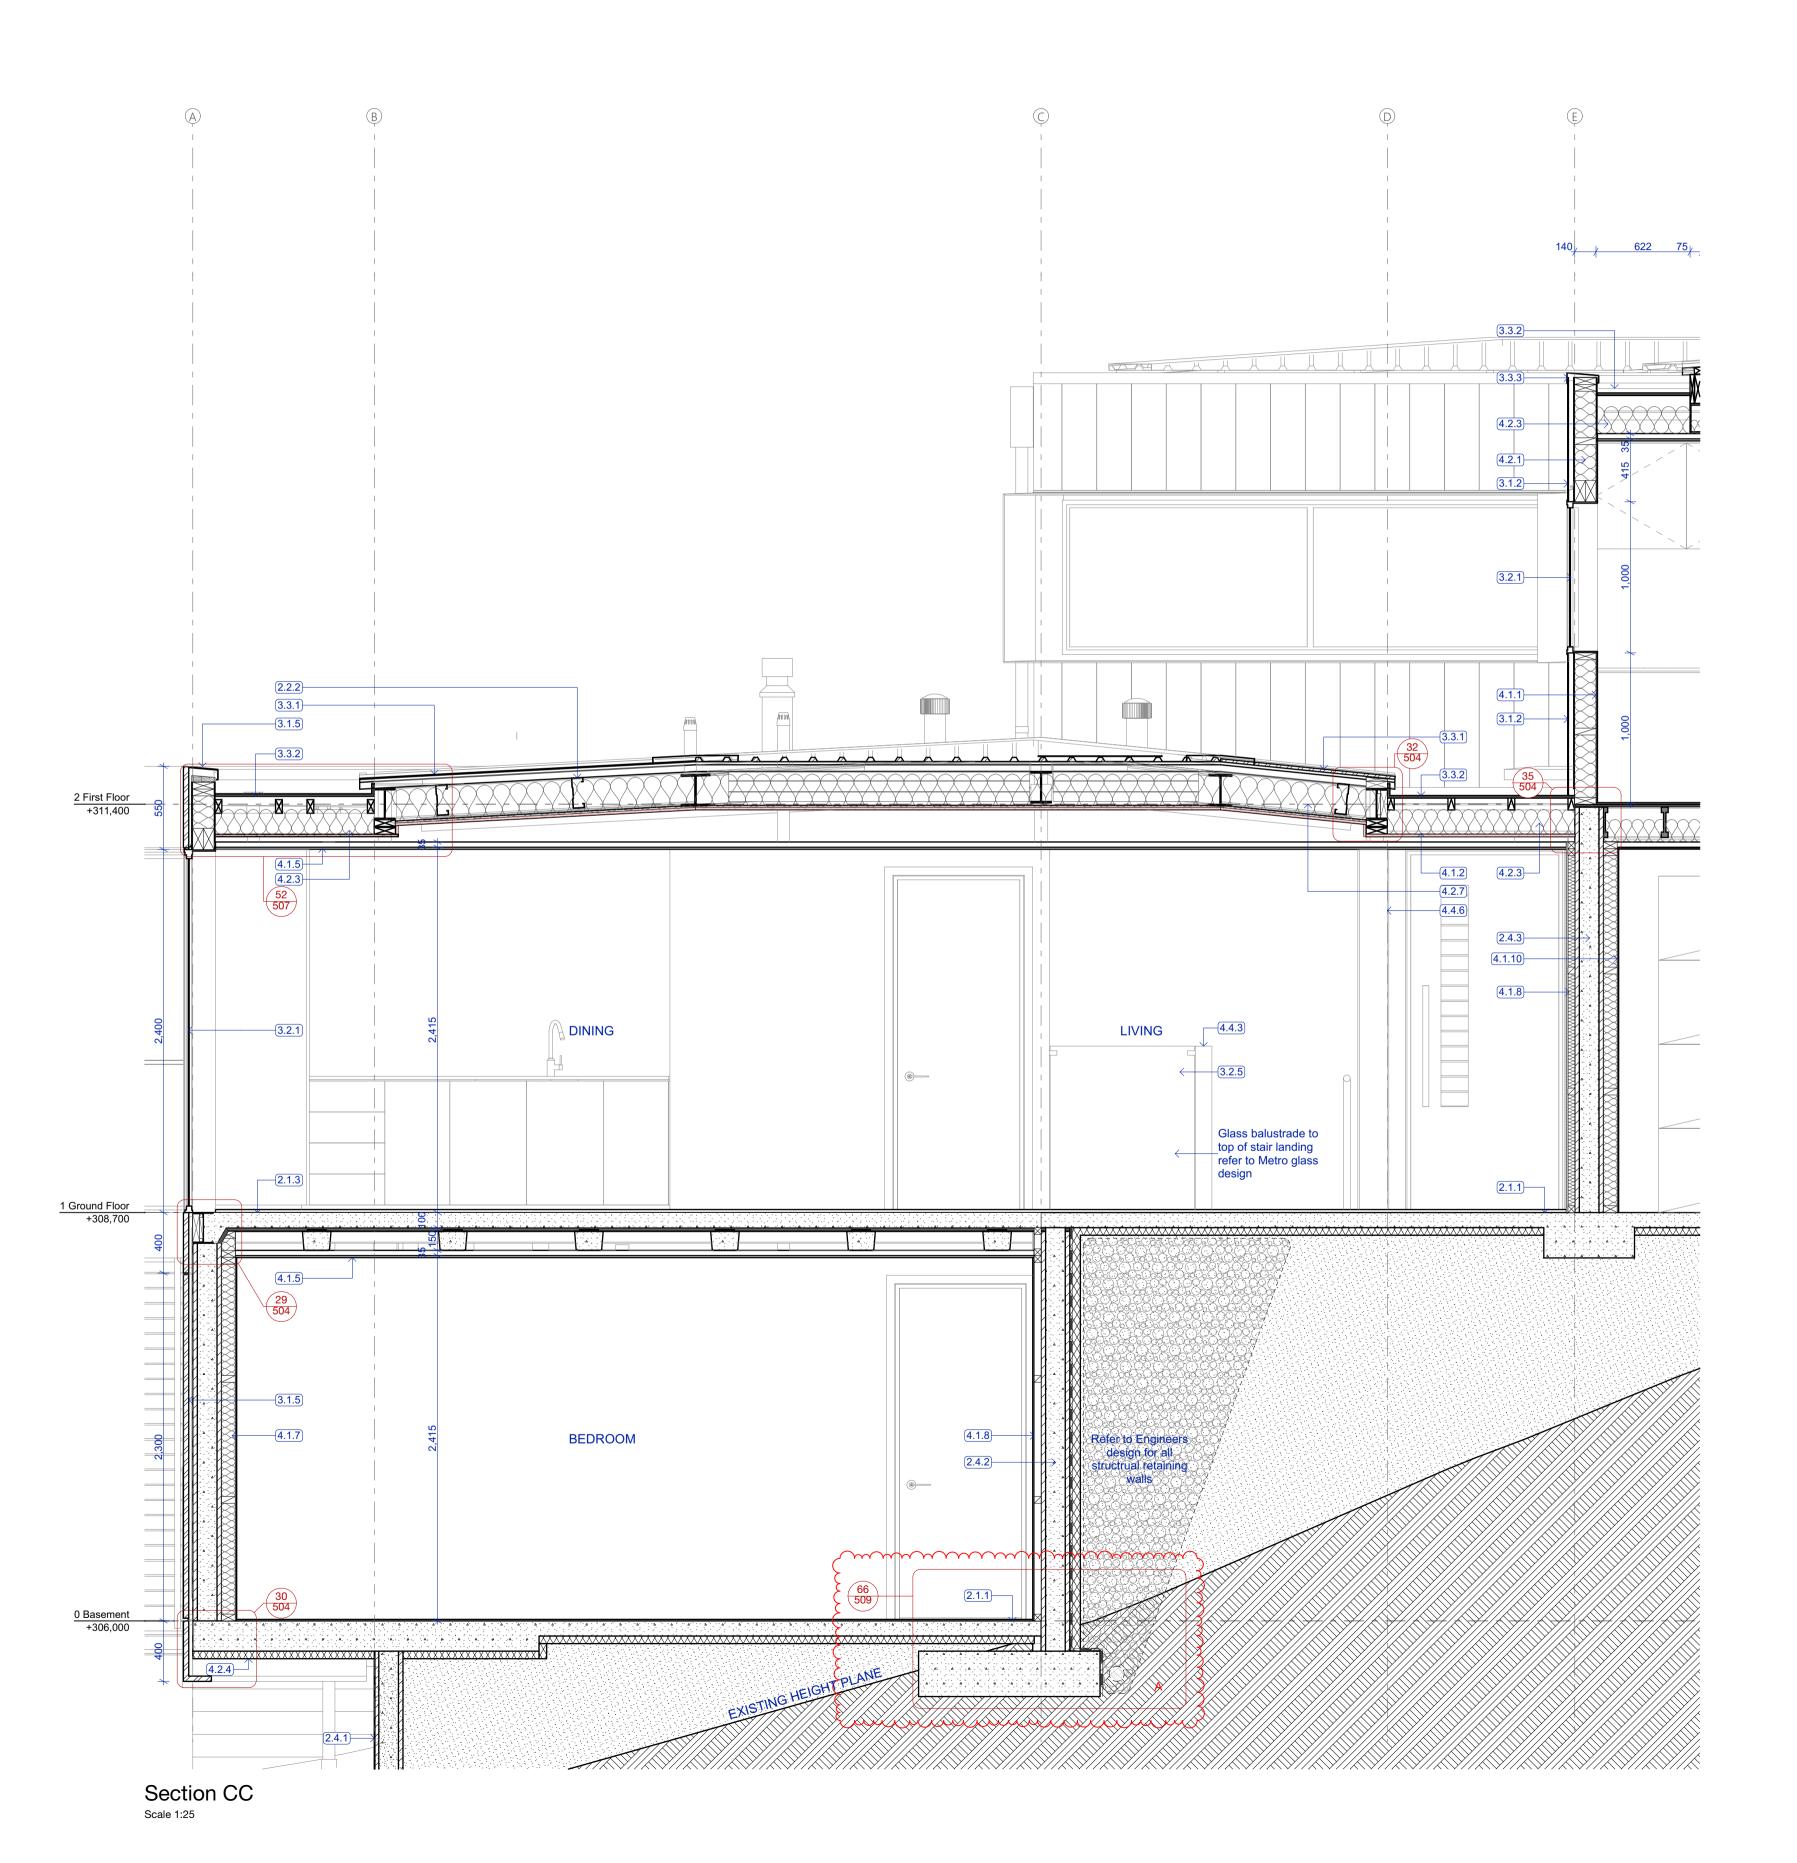Structural Engineer's documentation.
70mm XPS insulation to external face intergral with the engineers retaining wall 2.4.3 20 Series Concrete Block Wall 20 Series concrete block. Refer to

Structural Engineer's documentation. 3.1.2 Flashclad Euro-line Vertically fixed Euro-line powdercoated aluminium cladding. Installed as per the manufacturers documentation, by Flashclad nationwide distribution network. (studs @ 600crs, Dwangs @ 800crs)

2.1.1 Concrete slab on grade

exposed faces.
2.4.2 20 Series Concrete Block + Insulation

100mm concrete slab over 50mm XPS

polestyrene on DPM on grade. Refer

20 Series concrete block. Refer to Structural Engineer's documentation. Allow for sealer/render coat and paint finish to

20 Series concrete block. Refer to

3.1.5 Cudoclad Alpolic FR Cudoclad Alpolic FR composit aluminium cladding system installed by qualified installers in accordance with the maufacturers documents.

3.2.1 Aluminium windows and doors Vantage Pacific Thermal System aluminium joinery. Double glazed IGUs with Argon gas and Low E coating. Powdercoat finish to aluminium members.

3.2.5 Internal Glass Balustrade
13.52mm SAFELITE STF toughened
laminate glass balustrade with stiffener
bracket on Posiglaze PG120S Hardware
System. Refer to Metro glass details/PS1 for further information

3.3.1 Colorsteel roofing Metalcraft Colorsteel T-Rib roofing over selected roofing underlay & wire mesh screw fixed to top of purlins. Prefinished Colorsteel Endura finish

3.3.2 Torch-on membrane Viking Torch-on Lybra SBS Waterproofing membrane installed in accordance with the product manual. Over 17mm H3.2 CCA treated plywood supported at 400crs. 3.3.3 Parapet Flashing
0.55 BMT Parapet flashing with 5 degree

fall to roof and 70mm cover to cladding. Provide concealed clip fixings to exterior face. Colour as per schedule

4.1.1 GIB wall lining
10mm GIB standard lining stopped smooth
televel/4 finish to regieve paint finish.

4.1.2 GIB Fine line and lining stopped smooth 16mm GIB Fyreline ceiling lining installed in accordance with GIB Fire Rated Systems Manual GBUC 30. Over Rondo 308 metal batten or direct fixed to timber gutter framing. All fixings as per structural

diaphragm requirements.
4.1.5 GiB ceiling lining 13mm GIB standard lining on Rondo battens. Stop smooth to level 4 finish to recieve paint finish.

90mm Stap and line 90mm timber strapping with 10mm GIB standard lining stopped smooth to level 4 finish to recieve paint finish. 90mm R2.8 insulation between timber strapping. 4.1.8 45mm Stap and line

45mm timber strapping with 10mm GIB standard lining stopped smooth to level 4 finish to recieve paint finish. Insulate with R1.2 50mm Masonry batts between strapping.

9mm ply wall lining adhesive and brad fixed with selected oil finish. Min. R4.0 140mm thick exterior wall 140mm insulation 4.2.1

Min. R4.0 140mm thick exterior wall Ceiling insulation - 165mm R3.6 165mm ceiling insulation for tight

areas, ensure a 25mm air gap to underside of roofing
4.2.4 K10 G2 Soffit Board

50mm R2.5 Kingspan Kooltherm K10 G2 Soffit board installed to underside of exposed slab areas to complete thermal Ceiling insulation - 220mm R5 220mm ceiling insulation, ensure a

25mm air gap to underside of roofing **Gib Linned Balustrade** 4.4.3 Timber framed wall to extend 1m above floor level and pitch of stair to form solid balustrade. Line all sides with 10mm GIB ready for paint finish. Refer to engineers details for structural support.

Internal Cedar Fins 50mm thick internal cedar fins at 150crs (width to match wall thickness) adhesive fixed to rails top and bottom. Finish with selected Drydens oil.

Three **Architecture**



Chalmers Street Apartments 20 Chalmers Street Wanaka

Section C

Sheet No.

1:25, 1:250 Scale @ A1 File No. R19015 9/06/2021 Date Revision


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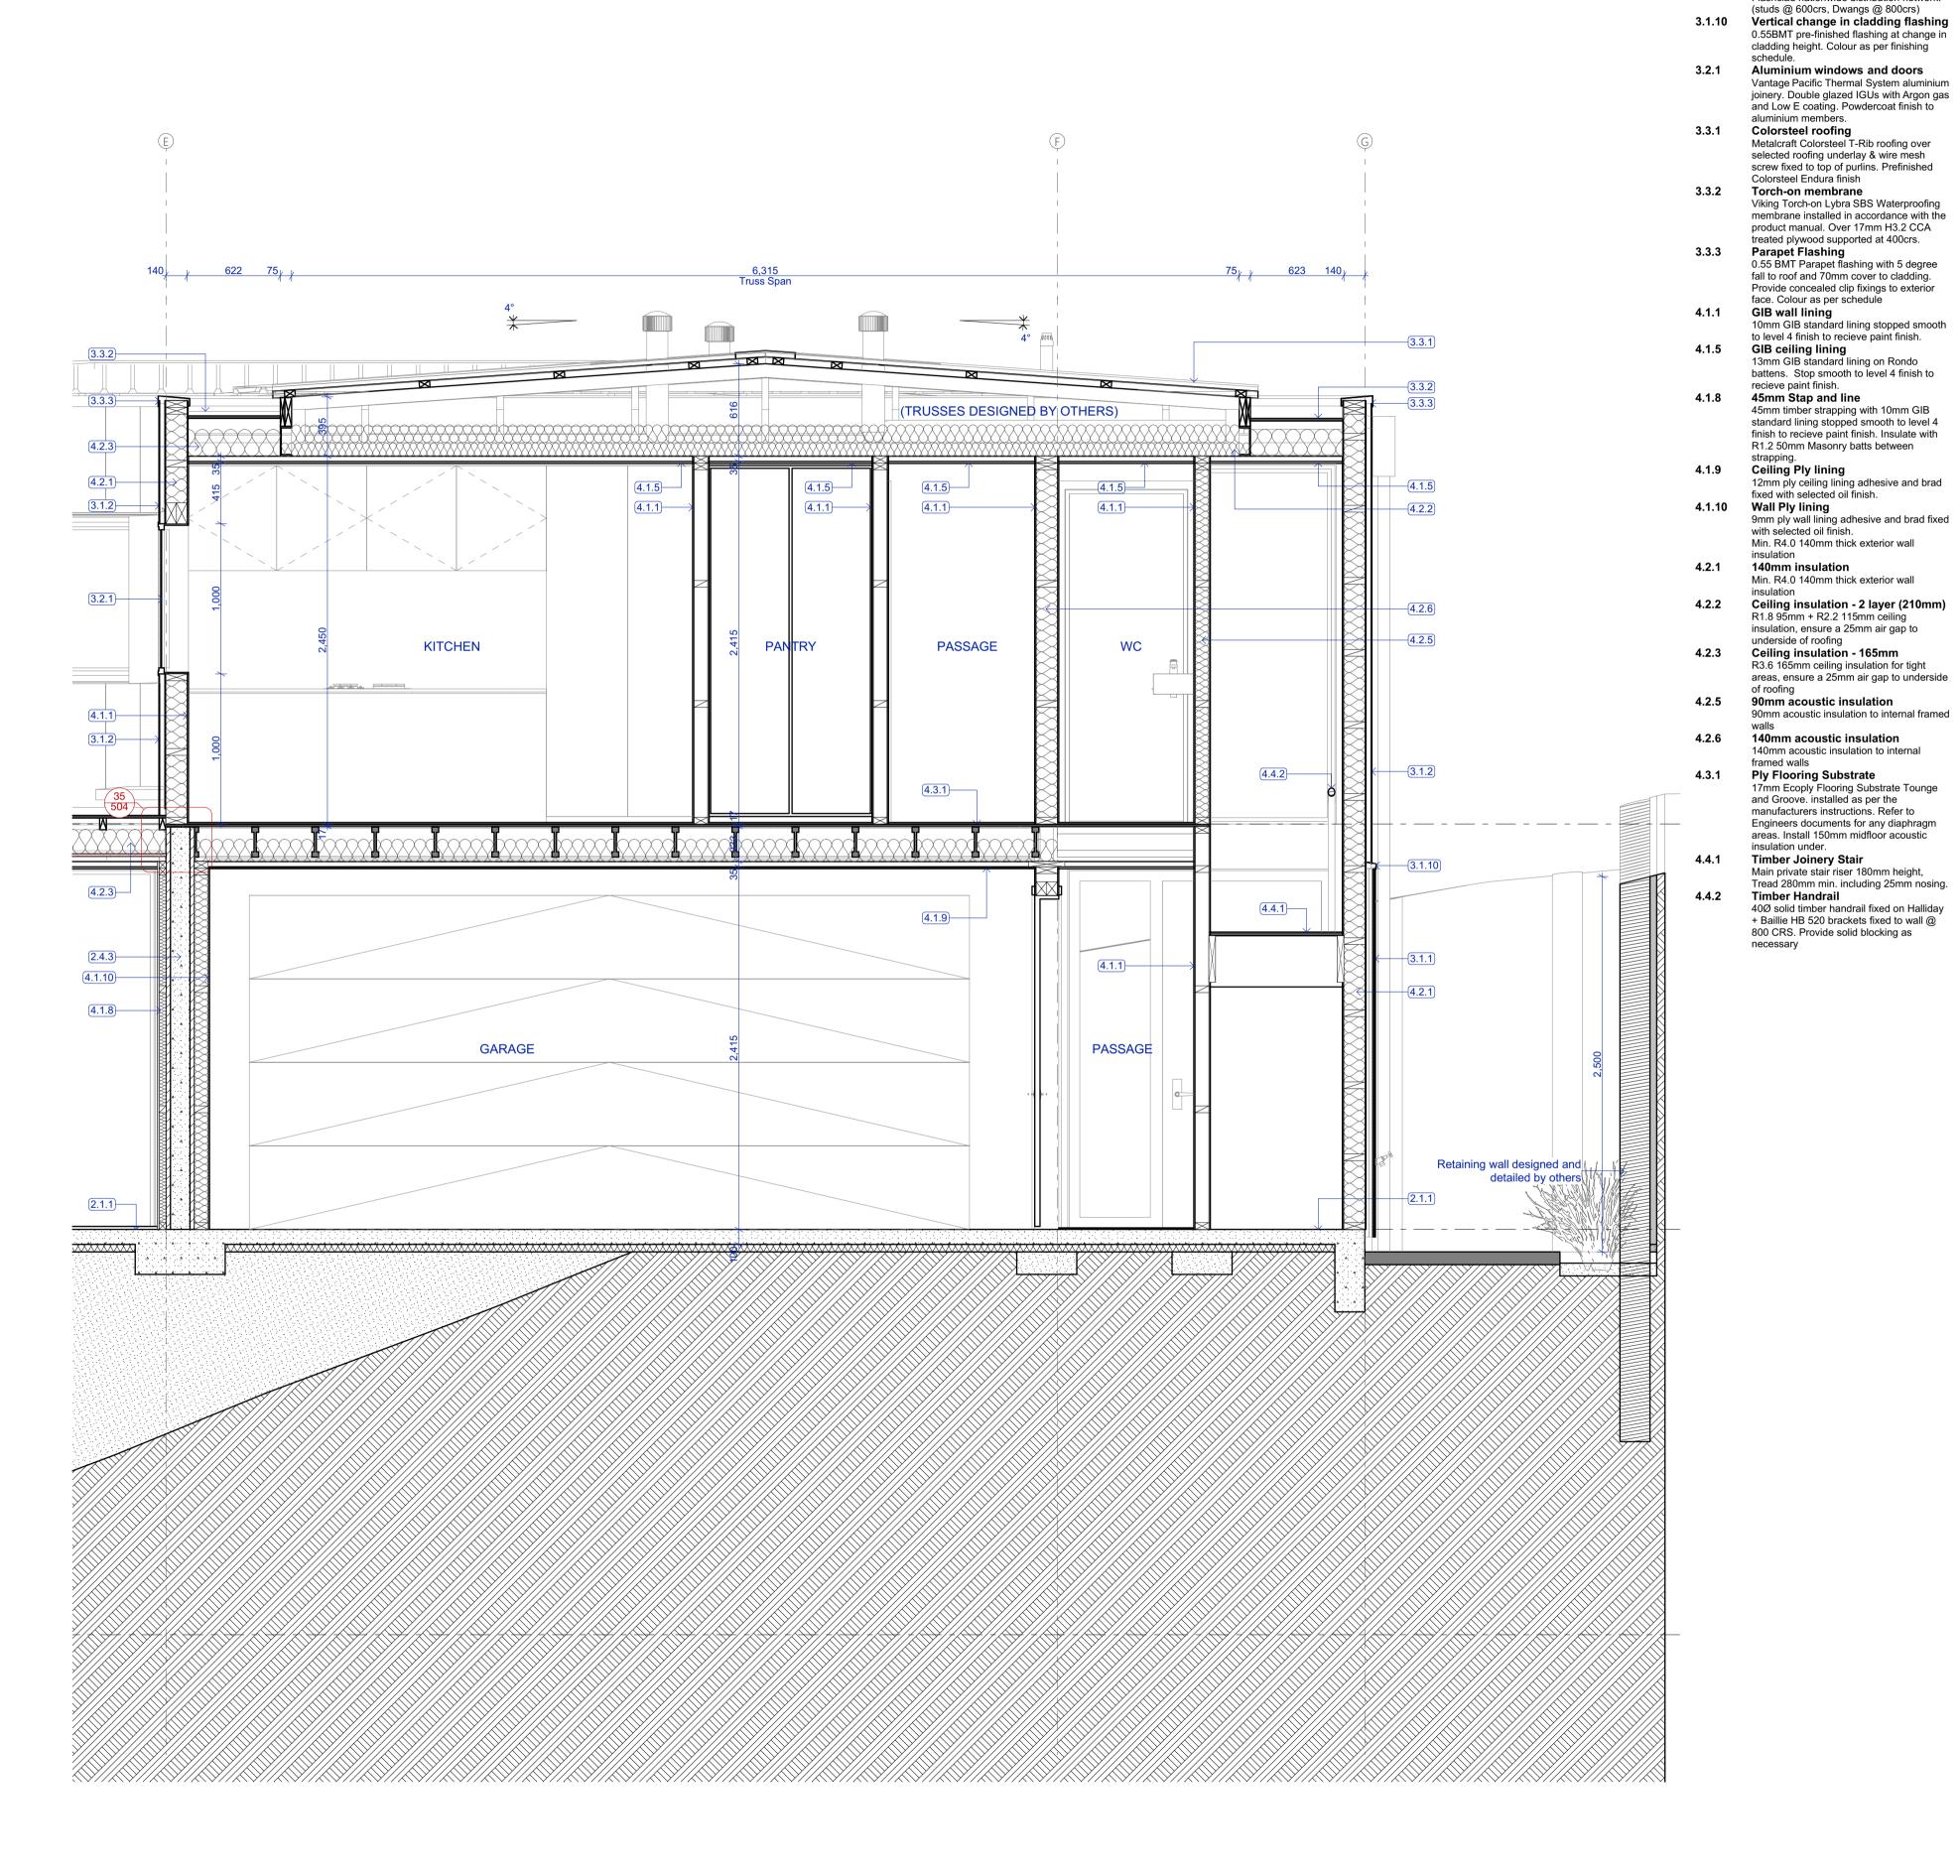
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Building Consent

Notes

2.1.1 Concrete slab on grade

2.4.3 20 Series Concrete Block Wall

@ 800crs)

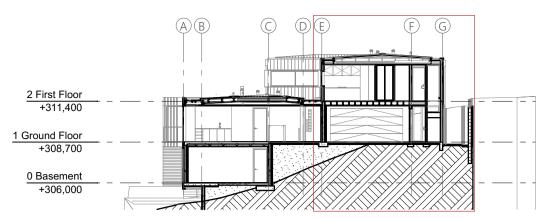3.1.2 Flashclad Euro-line
Vertically fixed Euro-line powdercoated

3.1.1 Vert. Shiplap wall cladding

100mm concrete slab over 50mm XPS

polestyrene on DPM on grade. Refer

Structural Engineer's documentation.

20 Series concrete block. Refer to Structural Engineer's documentation.

Rosenfeld Kidson RK58 vertical shiplap timber cladding over 45mm structural cavity battens. Finish with selected Drydens oil. Installed as per the manufacturers documentation. (studs @ 600crs, Dwangs

aluminium cladding. Installed as per the manufacturers documentation, by Flashclad nationwide distribution network.

All dimensions shall be verified on site by the contractor before starting any work or ordering any materials. All work must comply with NZS 3604 2011 and the New Zealand Building Code.

 Rev:
 Date:
 Issue:

 16/04/2021
 Building Consent Issue

Three Sixty Architecture



Chalmers Street
Apartments
20 Chalmers Street
Wanaka

Section C Continued

Scale @ A1 1:250

File No. R19015

Date 9/06/2021


Revision -


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Building Consent

2.1.1 Concrete slab on grade

Stahlton floor

exposed faces. 2.4.2 20 Series Concrete Block + Insulation

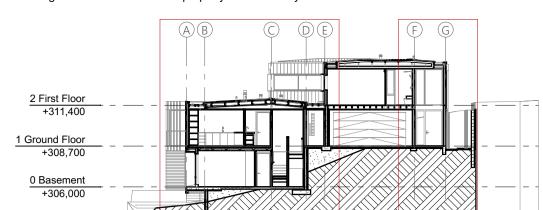Engineer's documentation

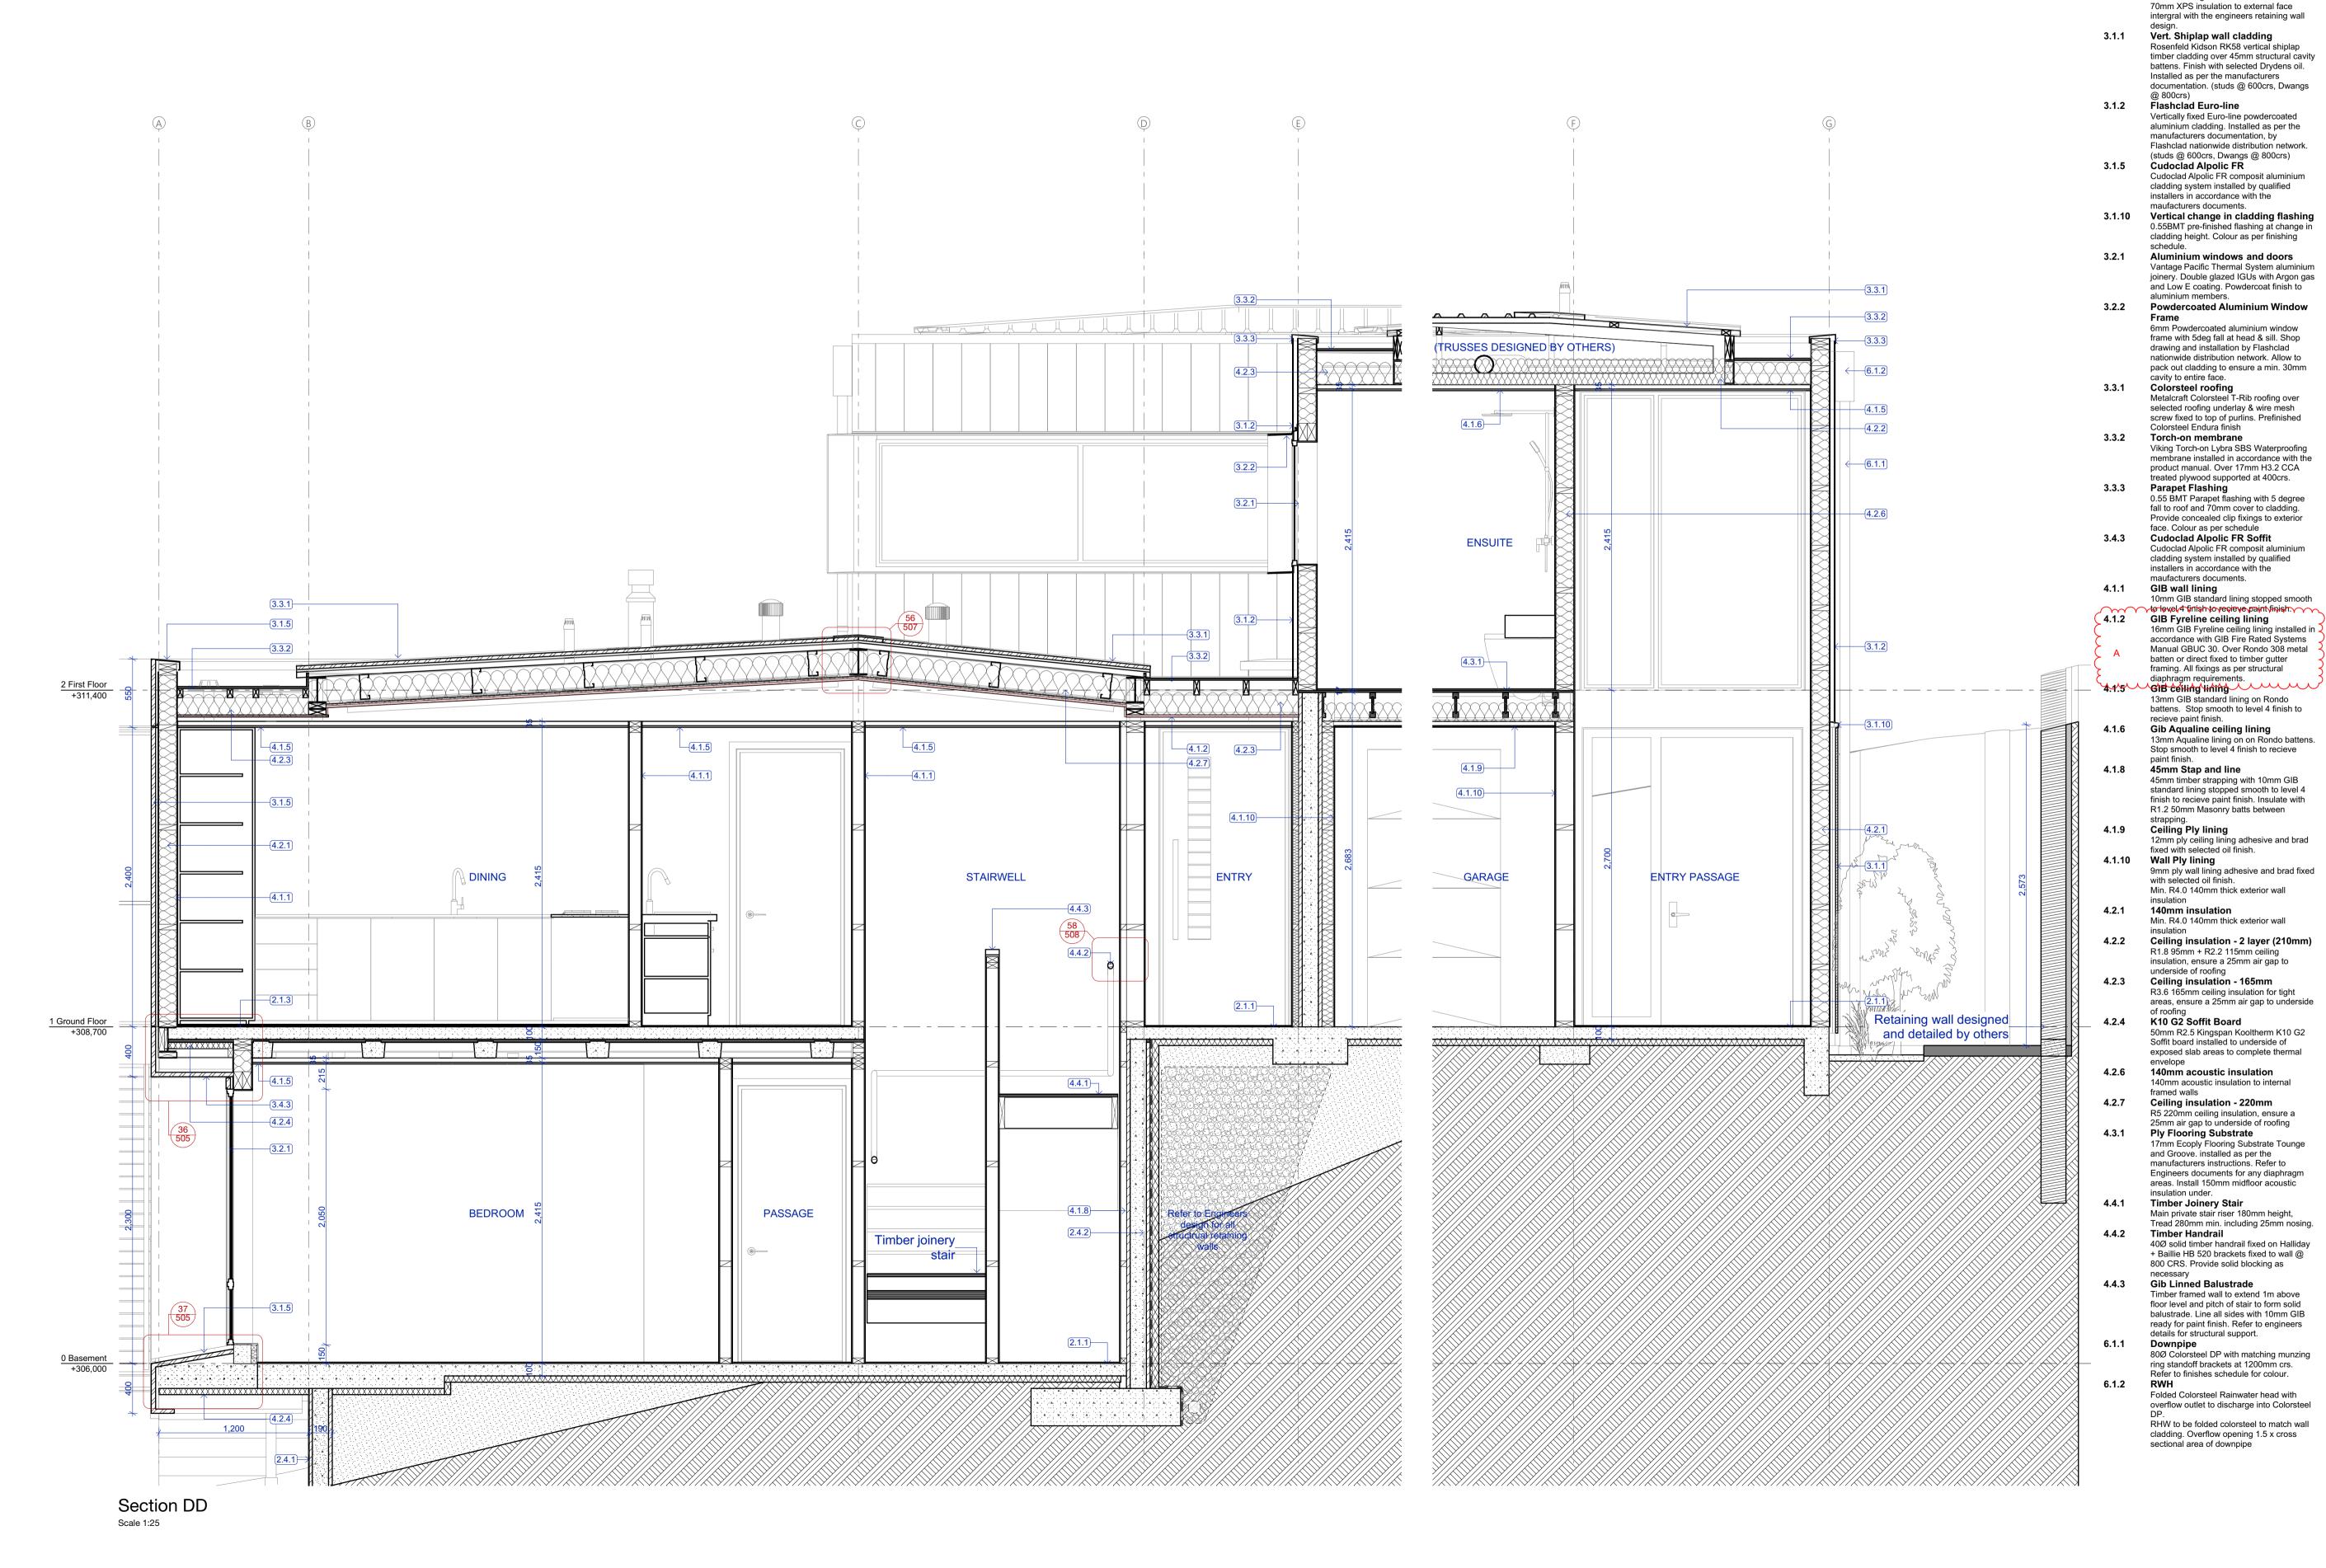2.1.3

100mm concrete slab over 50mm XPS

polestyrene on DPM on grade. Refer

Structural Engineer's documentation.

Stahlton rib & infill with 125mm deep ribs and 100mm thick topping. Refer Structural

20 Series Concrete Block Exterior

20 Series concrete block. Refer to Structural Engineer's documentation.

20 Series concrete block. Refer to Structural Engineer's documentation. Allow for sealer/render coat and paint finish to

All dimensions shall be verified on site by the contractor before starting any work or ordering any materials.
All work must comply with NZS 3604 2011 and the New Zealand Building Code.

Building Consent Issue

Three Sixty **Architecture**



Chalmers Street Apartments 20 Chalmers Street Wanaka


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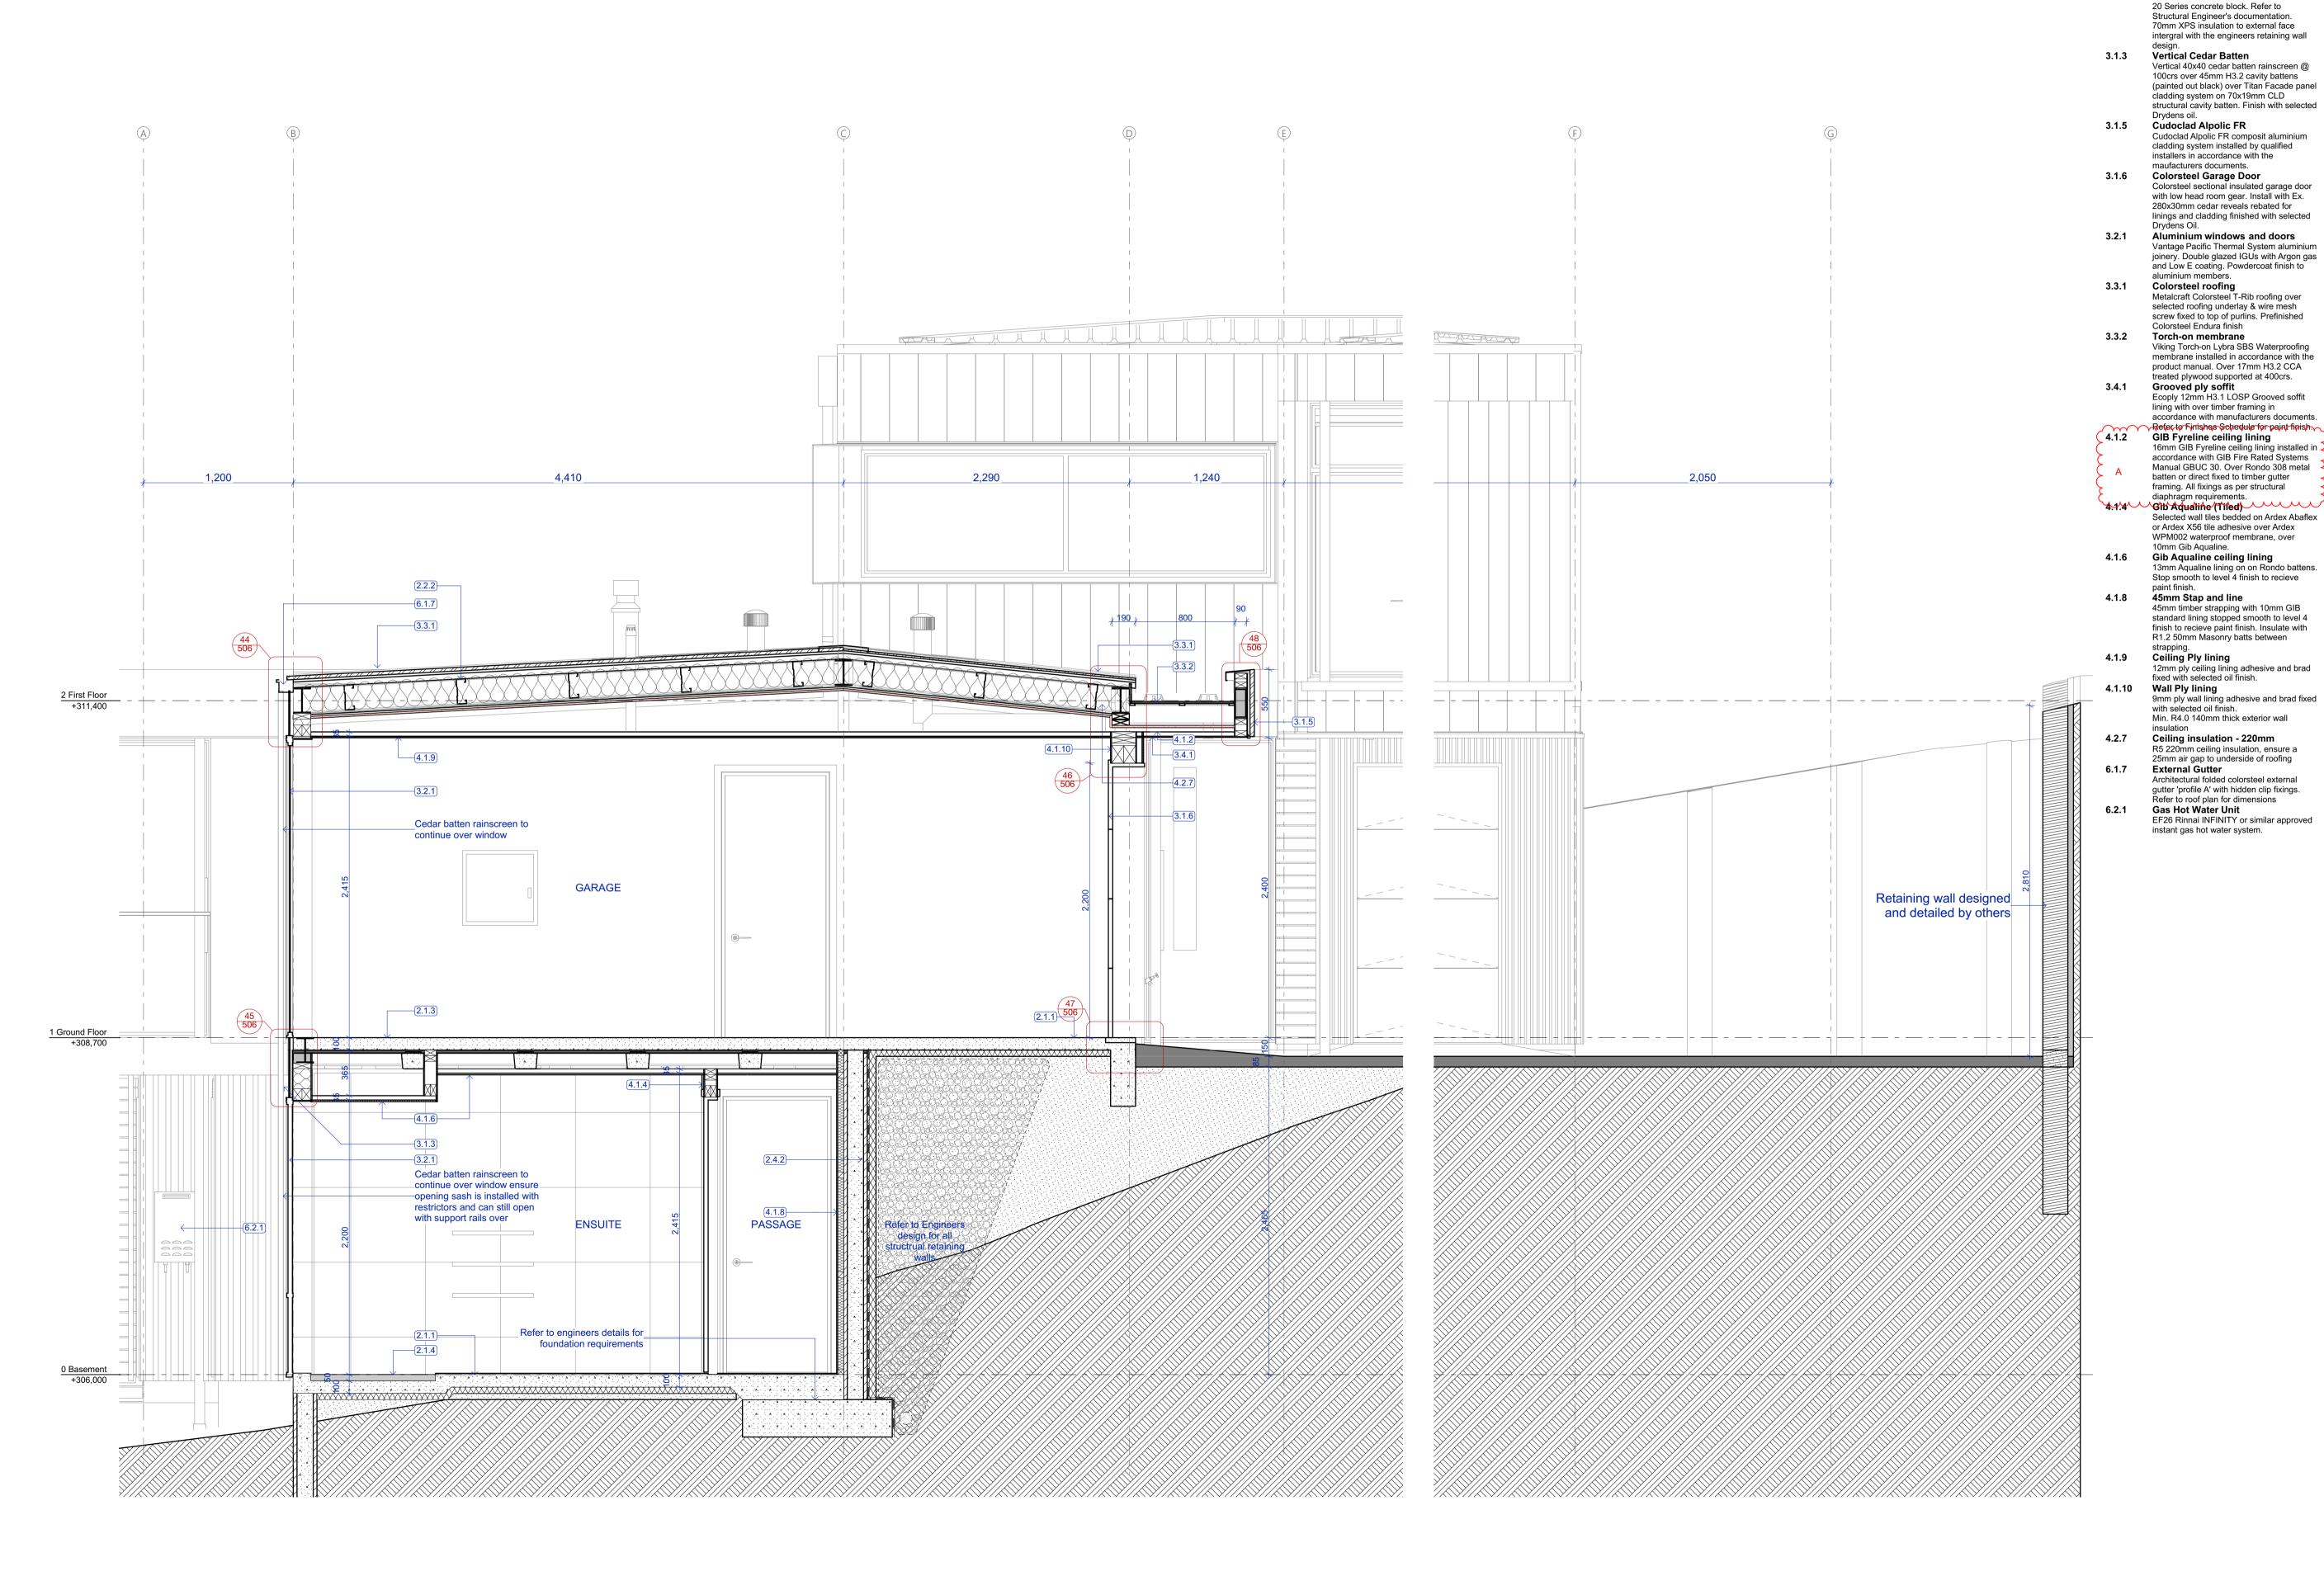
1:25, 1:250 Scale @ A1 File No. R19015 9/06/2021 Date Revision

405

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Building Consent

2.1.1 Concrete slab on grade

documentation.

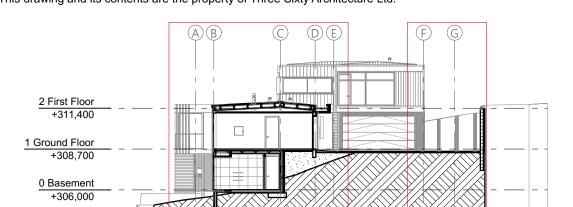Insulation

2.1.3 Stahlton floor

2.1.4 Shower rebate

100mm concrete slab over 50mm XPS

Stahlton rib & infill with 125mm deep ribs and 100mm thick topping. Refer Structural

50mm shower rebate - Tile falls to channel drain. Refer Structural Engineer's

polestyrene on DPM on grade. Refer

Structural Engineer's documentation.

Engineer's documentation.

2.2.2 Steel HST purlins
200/15 DHS purlins @ 900mm crs. Refer to

Structural Engineer's documentation.

2.4.2 20 Series Concrete Block +

All dimensions shall be verified on site by the contractor before starting any work or ordering any materials.
All work must comply with NZS 3604 2011 and the New Zealand Building Code.

Issue:
Building Consent Issue
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Three Sixty Architecture



Chalmers Street Apartments 20 Chalmers Street Wanaka

Section E

1:25, 1:250 Scale @ A1 File No. R19015 9/06/2021 Date Revision


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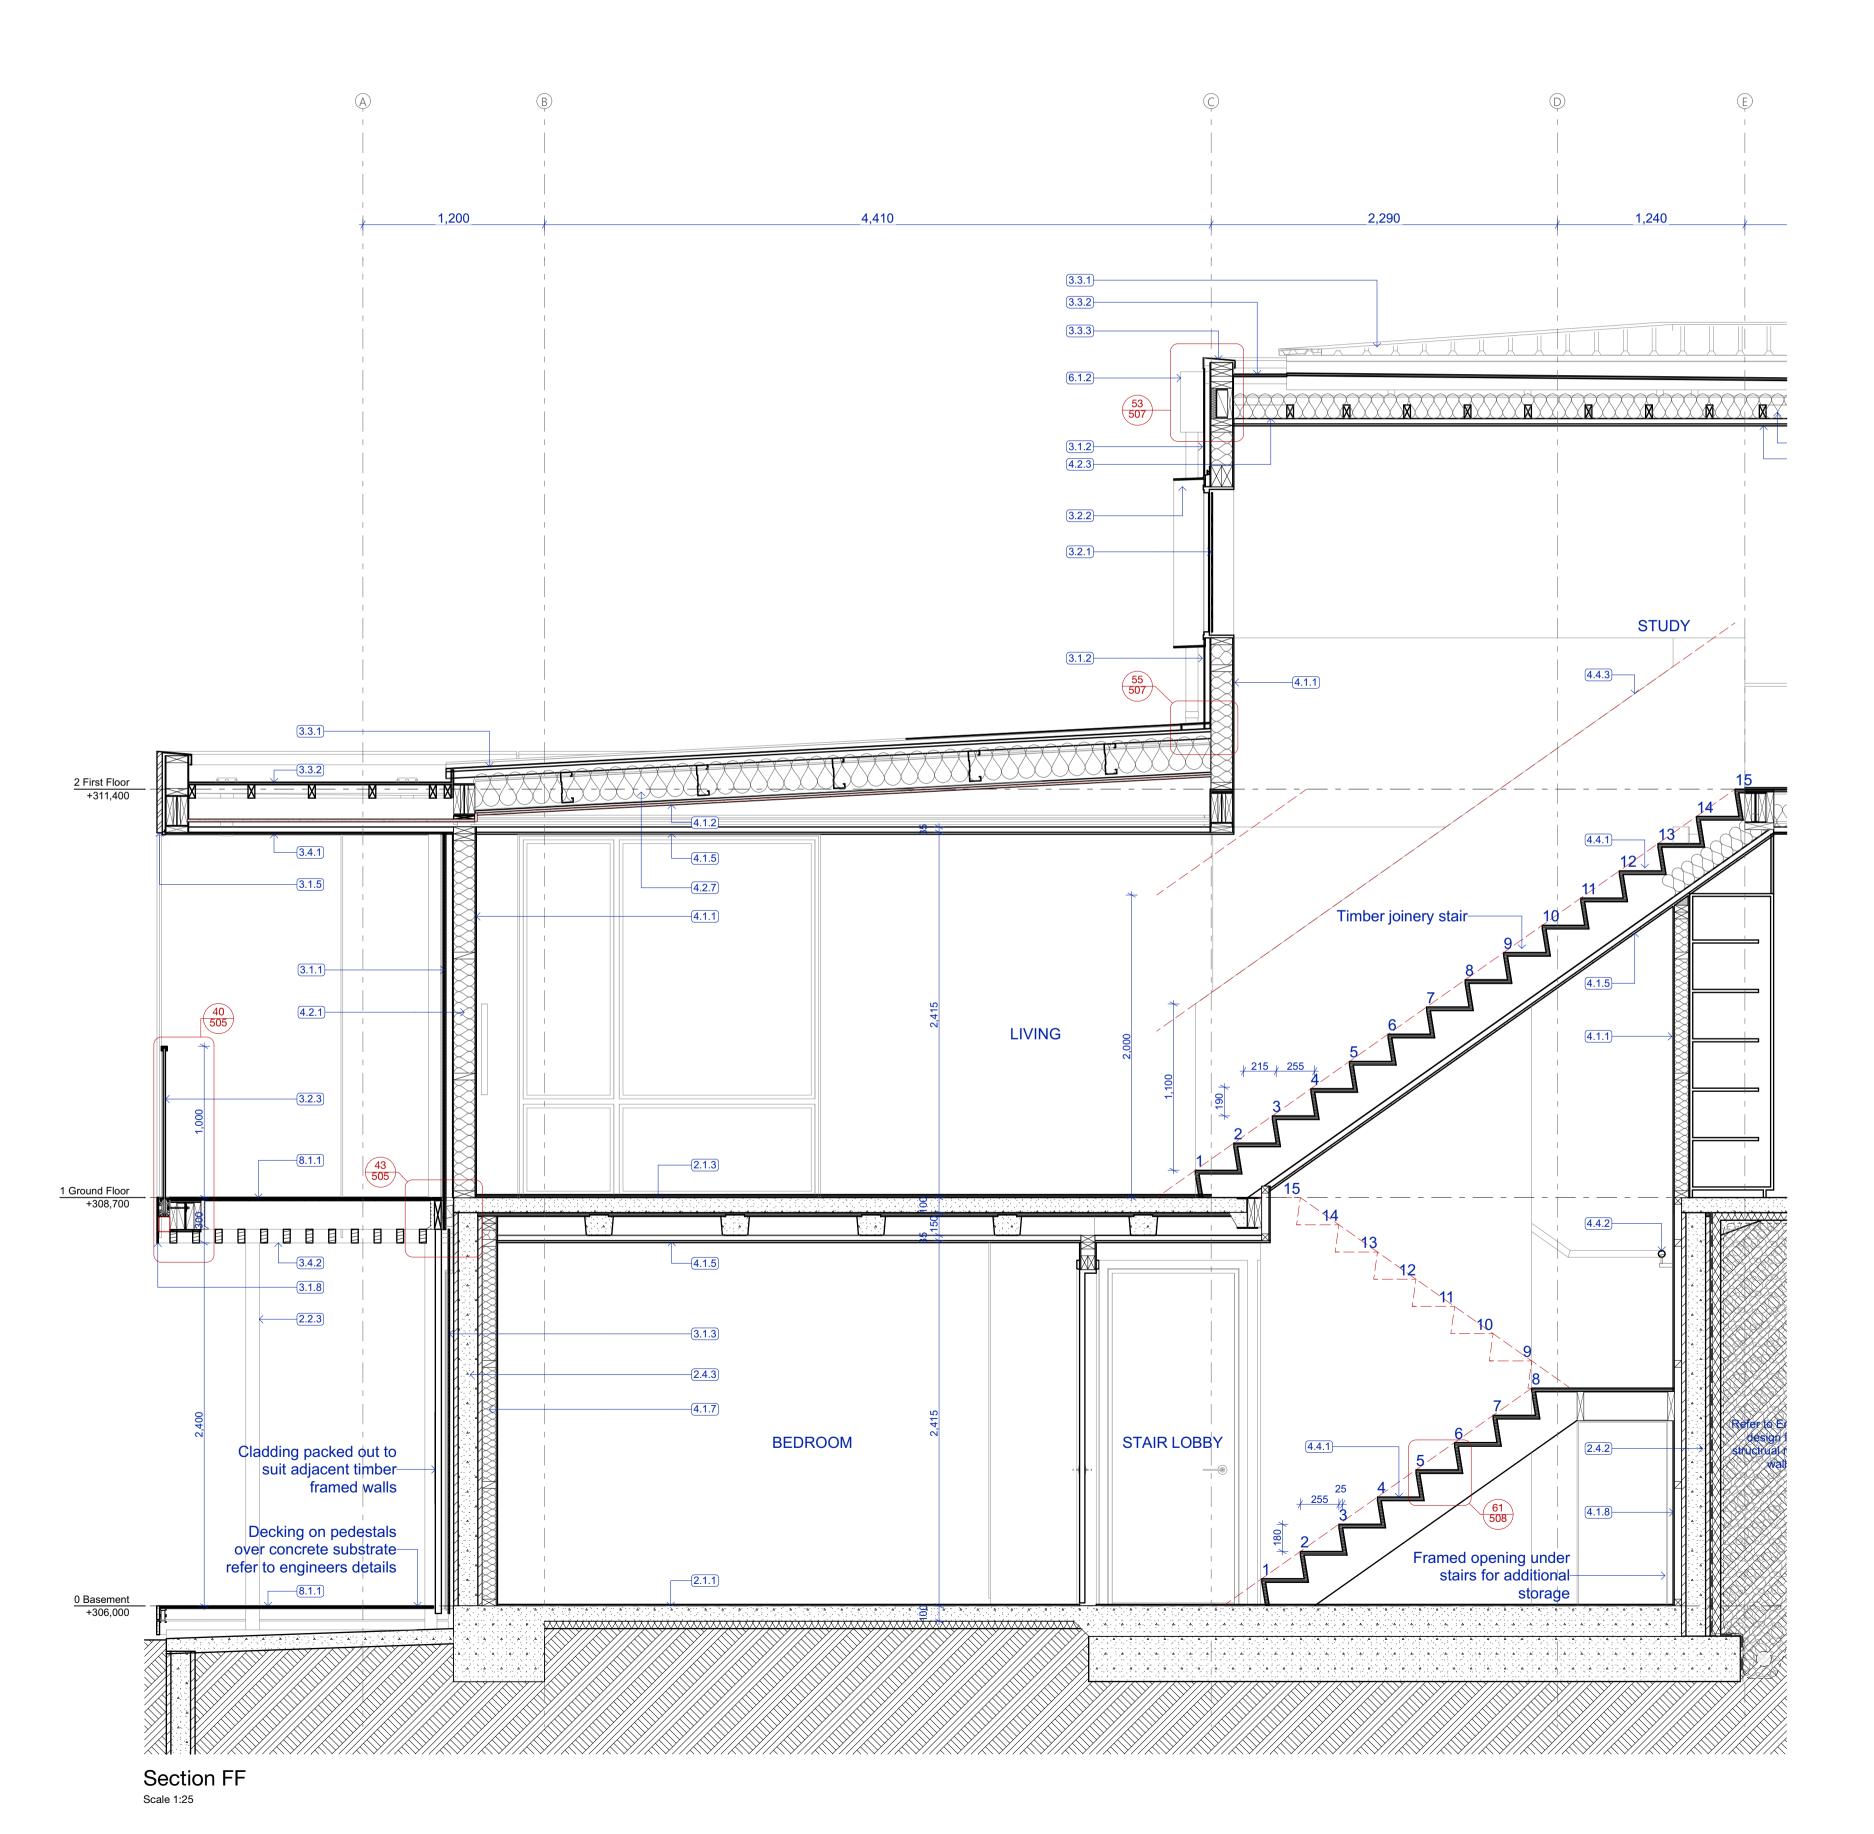
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Building Consent

Notes :

All dimensions shall be verified on site by the contractor before starting any work or ordering any materials. All work must comply with NZS 3604 2011 and the New Zealand Building Code.

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 Date:
 Issue:

 16/04/2021
 Building Consent Issue

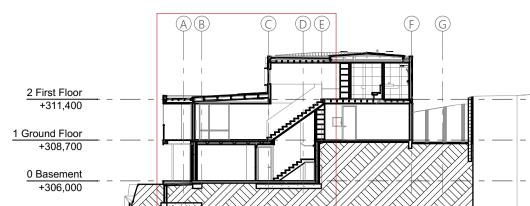 A
 9/06/2021
 Council RFI

2.1.1 Concrete slab on grade

 100mm concrete slab over 50mm XPS
 polestyrene on DPM on grade. Refer
 Structural Engineer's documentation.

 2.1.3 Stahlton floor

 Stahlton rib & infill with 125mm deep ribs

and 100mm thick topping. Refer Structural Engineer's documentation.

2.2.3 SHS 89x89
89x6 SHS. Refer to Structural Engineer's documentation. Refer to Specification for paint finish where steelwork is exposed. Ensure separation layer to timber where

packing proposed.

2.4.2 20 Series Concrete Block +
Insulation
20 Series concrete block. Refer to
Structural Engineer's documentation
70mm XPS insulation to external fac

Structural Engineer's documentation.
70mm XPS insulation to external face intergral with the engineers retaining wall design.

2.4.3
20 Series Concrete Block Wall
20 Series concrete block. Refer to

Structural Engineer's documentation.

Vert. Shiplap wall cladding
Rosenfeld Kidson RK58 vertical shiplap
timber cladding over 45mm structural cavity
battens. Finish with selected Drydens oil.
Installed as per the manufacturers
documentation. (studs @ 600crs, Dwangs
@ 800crs)

1.1.2 Flashclad Euro-line

Vertically fixed Euro-line powdercoated aluminium cladding. Installed as per the manufacturers documentation, by Flashclad nationwide distribution network. (studs @ 600crs, Dwangs @ 800crs)

3.1.3 Vertical Cedar Batten
Vertical 40x40 cedar batten rainscreen @ 100crs over 45mm H3 2 cavity battens

100crs over 45mm H3.2 cavity battens
(painted out black) over Titan Facade panel
cladding system on 70x19mm CLD
structural cavity batten. Finish with selected
Drydens oil.

3.1.5 Cudoclad Alpolic FR
Cudoclad Alpolic FR composit aluminium
cladding system installed by qualified

cladding system installed by qualified installers in accordance with the maufacturers documents.

3.1.8 Decorative Steel Plate
9mm zinc sprayed & powdercoated steel plate to external face FW to RHS. Refer to

Structural Engineer's documentation.

3.2.1 Aluminium windows and doors
Vantage Pacific Thermal System aluminium
joinery. Double glazed IGUs with Argon gas
and Low E coating. Powdercoat finish to
aluminium members.

3.2.2 Powdercoated Aluminium Window

6mm Powdercoated aluminium window frame with 5deg fall at head & sill. Shop drawing and installation by Flashclad nationwide distribution network. Allow to pack out cladding to ensure a min. 30mm cavity to entire face.

3.2.3 External Glass Balustrade

Frame

Metro 12mm Monolithic TEMPAFLOAT glass on Posiglaze PG120S Hardware System. Toughened with S25 interlinking capping rail to top. Refer to Metro glass details/PS1 for further information

Colorsteel roofing
Metalcraft Colorsteel T-Rib roofing over

screw fixed to top of purlins. Prefinished
Colorsteel Endura finish

3.3.2 Torch-on membrane
Viking Torch-on Lybra SBS Waterproofing
membrane installed in accordance with the
product manual. Over 17mm H3.2 CCA
treated plywood supported at 400crs.

selected roofing underlay & wire mesh

3.3.3 Parapet Flashing
0.55 BMT Parapet flashing with 5 degree fall to roof and 70mm cover to cladding.
Provide concealed clip fixings to exterior face. Colour as per schedule

3.4.1 Grooved ply soffit

Ecoply 12mm H3.1 LOSP Grooved soffit
lining with over timber framing in
accordance with manufacturers documents.
Refer to Finishes Schedule for paint finish.

3.4.2 Timber battens

Decorative 90x45 timber battens fixed to underside of deck framing battens spaced @ 145 CRS. Selected drydens oil finish.

GIB wall lining

10mm GIB standard lining stopped smooth

10mm GIB standard lining stopped smooth
to level.4 finish to recieve paint finish.

4.1.2 GIB Fyreline ceiling lining
16mm GIB Fyreline ceiling lining installed in
accordance with GIB Fire Rated Systems
Manual GBUC 30. Over Rondo 308 metal
batten or direct fixed to timber gutter
framing. All fixings as per structural
diaphragm requirements.

diaphragm requirements.

4.1.5 GIB ceiling lining

13mm GIB standard lining on Rondo
battens. Stop smooth to level 4 finish to
recieve paint finish.

4.1.7 90mm Stap and line
90mm timber strapping with 10mm GIB

standard lining stopped smooth to level 4 finish to recieve paint finish. 90mm R2.8 insulation between timber strapping.

45mm Stap and line
45mm timber strapping with 10mm GIB standard lining stopped smooth to level 4 finish to recieve paint finish. Insulate with R1.2 50mm Masonry batts between

strapping.
Min. R4.0 140mm thick exterior wall

R3.6 165mm ceiling insulation for tight

4.2.1 140mm insulation
Min. R4.0 140mm thick exterior wall insulation
4.2.3 Ceiling insulation - 165mm

areas, ensure a 25mm air gap to underside of roofing

4.2.7 Ceiling insulation - 220mm
R5 220mm ceiling insulation, ensure a 25mm air gap to underside of roofing

4.4.1 Timber Joinery Stair

Main private stair riser 180mm height,
Tread 280mm min. including 25mm nosing.

4.4.2 Timber Handrail
40Ø solid timber handrail fixed on Halliday
+ Baillie HB 520 brackets fixed to wall @
800 CRS. Provide solid blocking as

4.4.3 Gib Linned Balustrade
Timber framed wall to extend 1m above floor level and pitch of stair to form solid balustrade. Line all sides with 10mm GIB ready for paint finish. Refer to engineers details for structural support.

Folded Colorsteel Rainwater head with overflow outlet to discharge into Colorsteel DP.

RHW to be folded colorsteel to match wall cladding. Overflow opening 1.5 x cross sectional area of downpipe

Decking
Selected 19 x 90mm Hardwood decking
with oil finish or composit decking board.
Over timber framed structure refer to
engineers details.

Three Sixty Architecture



Chalmers Street
Apartments
20 Chalmers Street
Wanaka

Section F

Scale @ A1 1:25, 1:250
File No. R19015
Date 9/06/2021
Revision A


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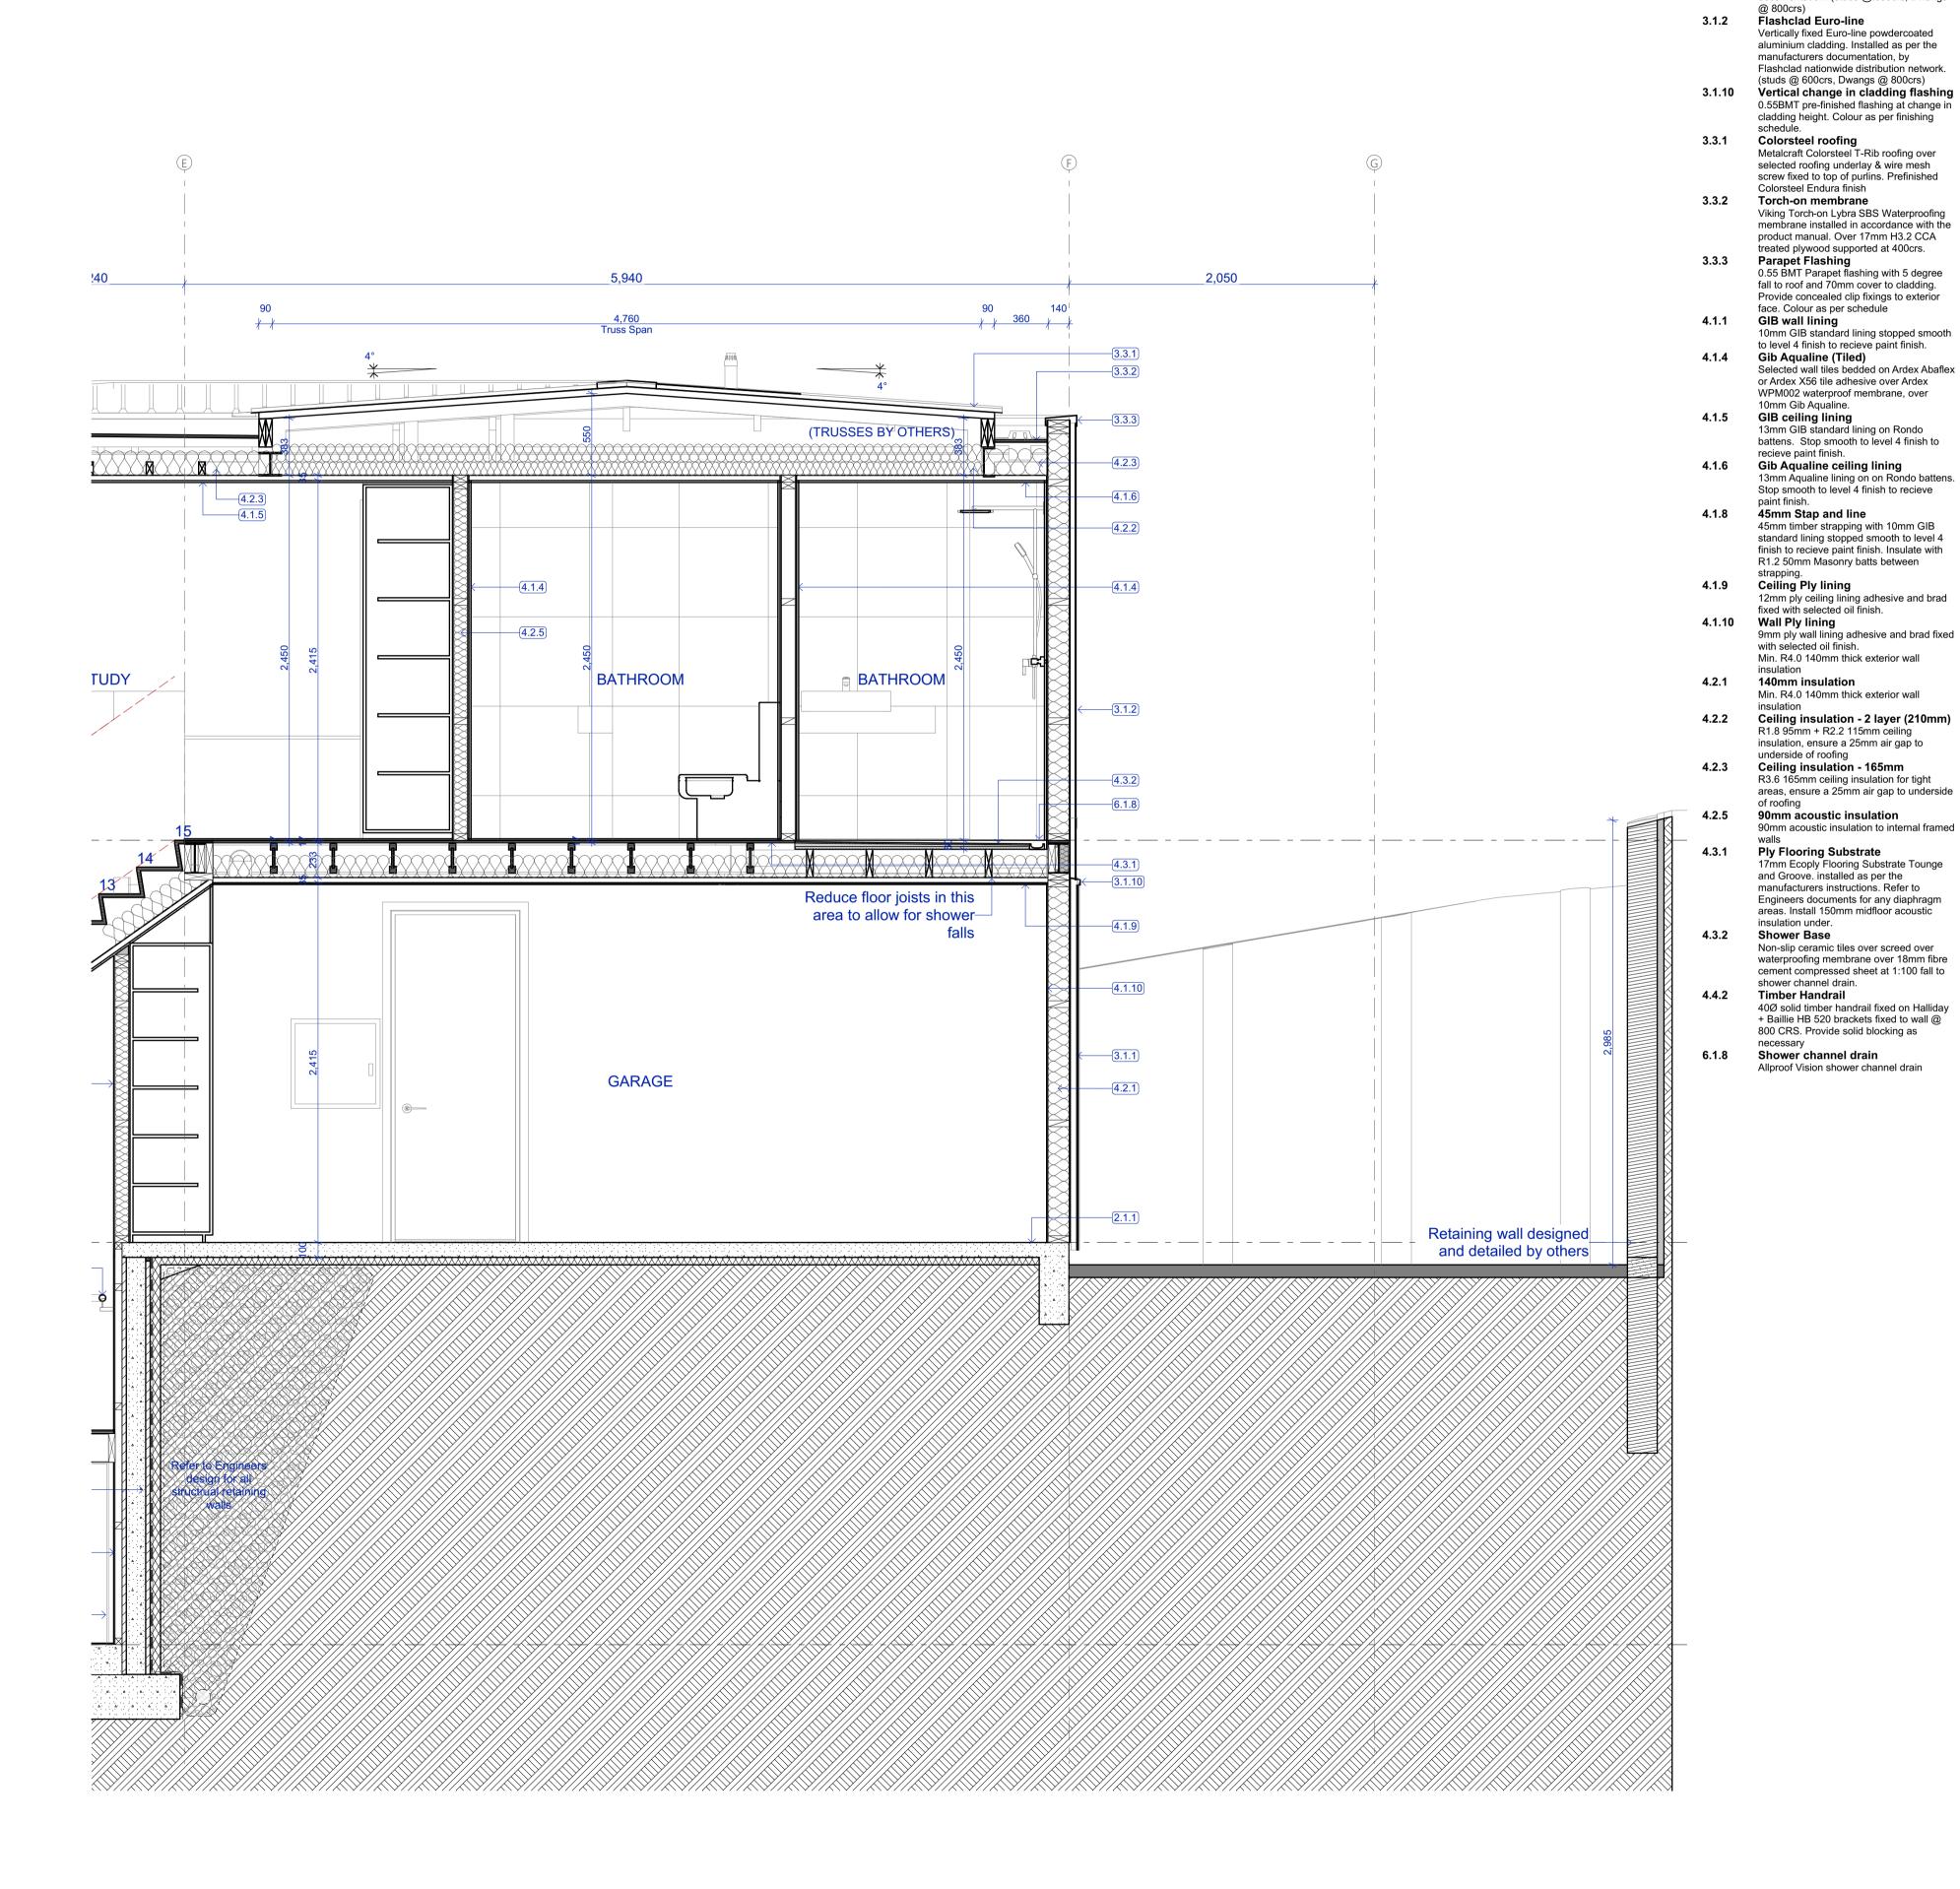
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Building Consent

Notes :

2.1.1 Concrete slab on grade

Insulation

2.4.2 20 Series Concrete Block +

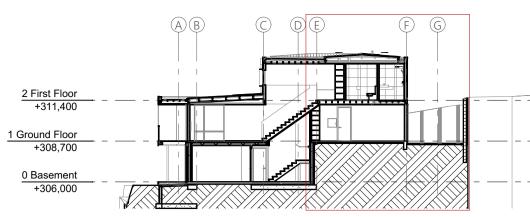100mm concrete slab over 50mm XPS

polestyrene on DPM on grade. Refer

Structural Engineer's documentation.

20 Series concrete block. Refer to

3.1.1 Vert. Shiplap wall cladding
Rosenfeld Kidson RK58 vertical shiplap

Structural Engineer's documentation.
70mm XPS insulation to external face

intergral with the engineers retaining wall

timber cladding over 45mm structural cavity battens. Finish with selected Drydens oil. Installed as per the manufacturers documentation. (studs @ 600crs, Dwangs All dimensions shall be verified on site by the contractor before starting any work or ordering any materials. All work must comply with NZS 3604 2011 and the New Zealand Building Code.

 Rev:
 Date:
 Issue:

 16/04/2021
 Building Consent Issue

Three Sixty Architecture



Chalmers Street
Apartments
20 Chalmers Street
Wanaka

Section F Continued


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File No. R19015
Date 9/06/2021
Revision -


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Building Consent

2.1.1 Concrete slab on grade

documentation.

@ 800crs)
3.1.2 Flashclad Euro-line

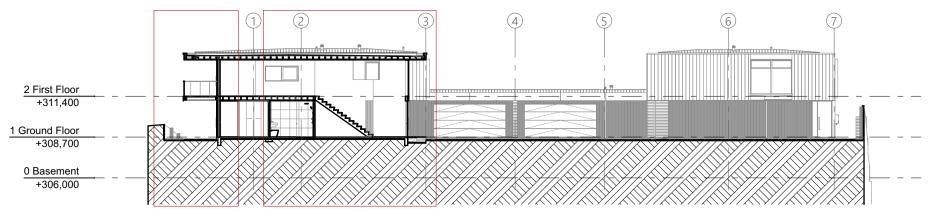3.1.5 Cudoclad Alpolic FR

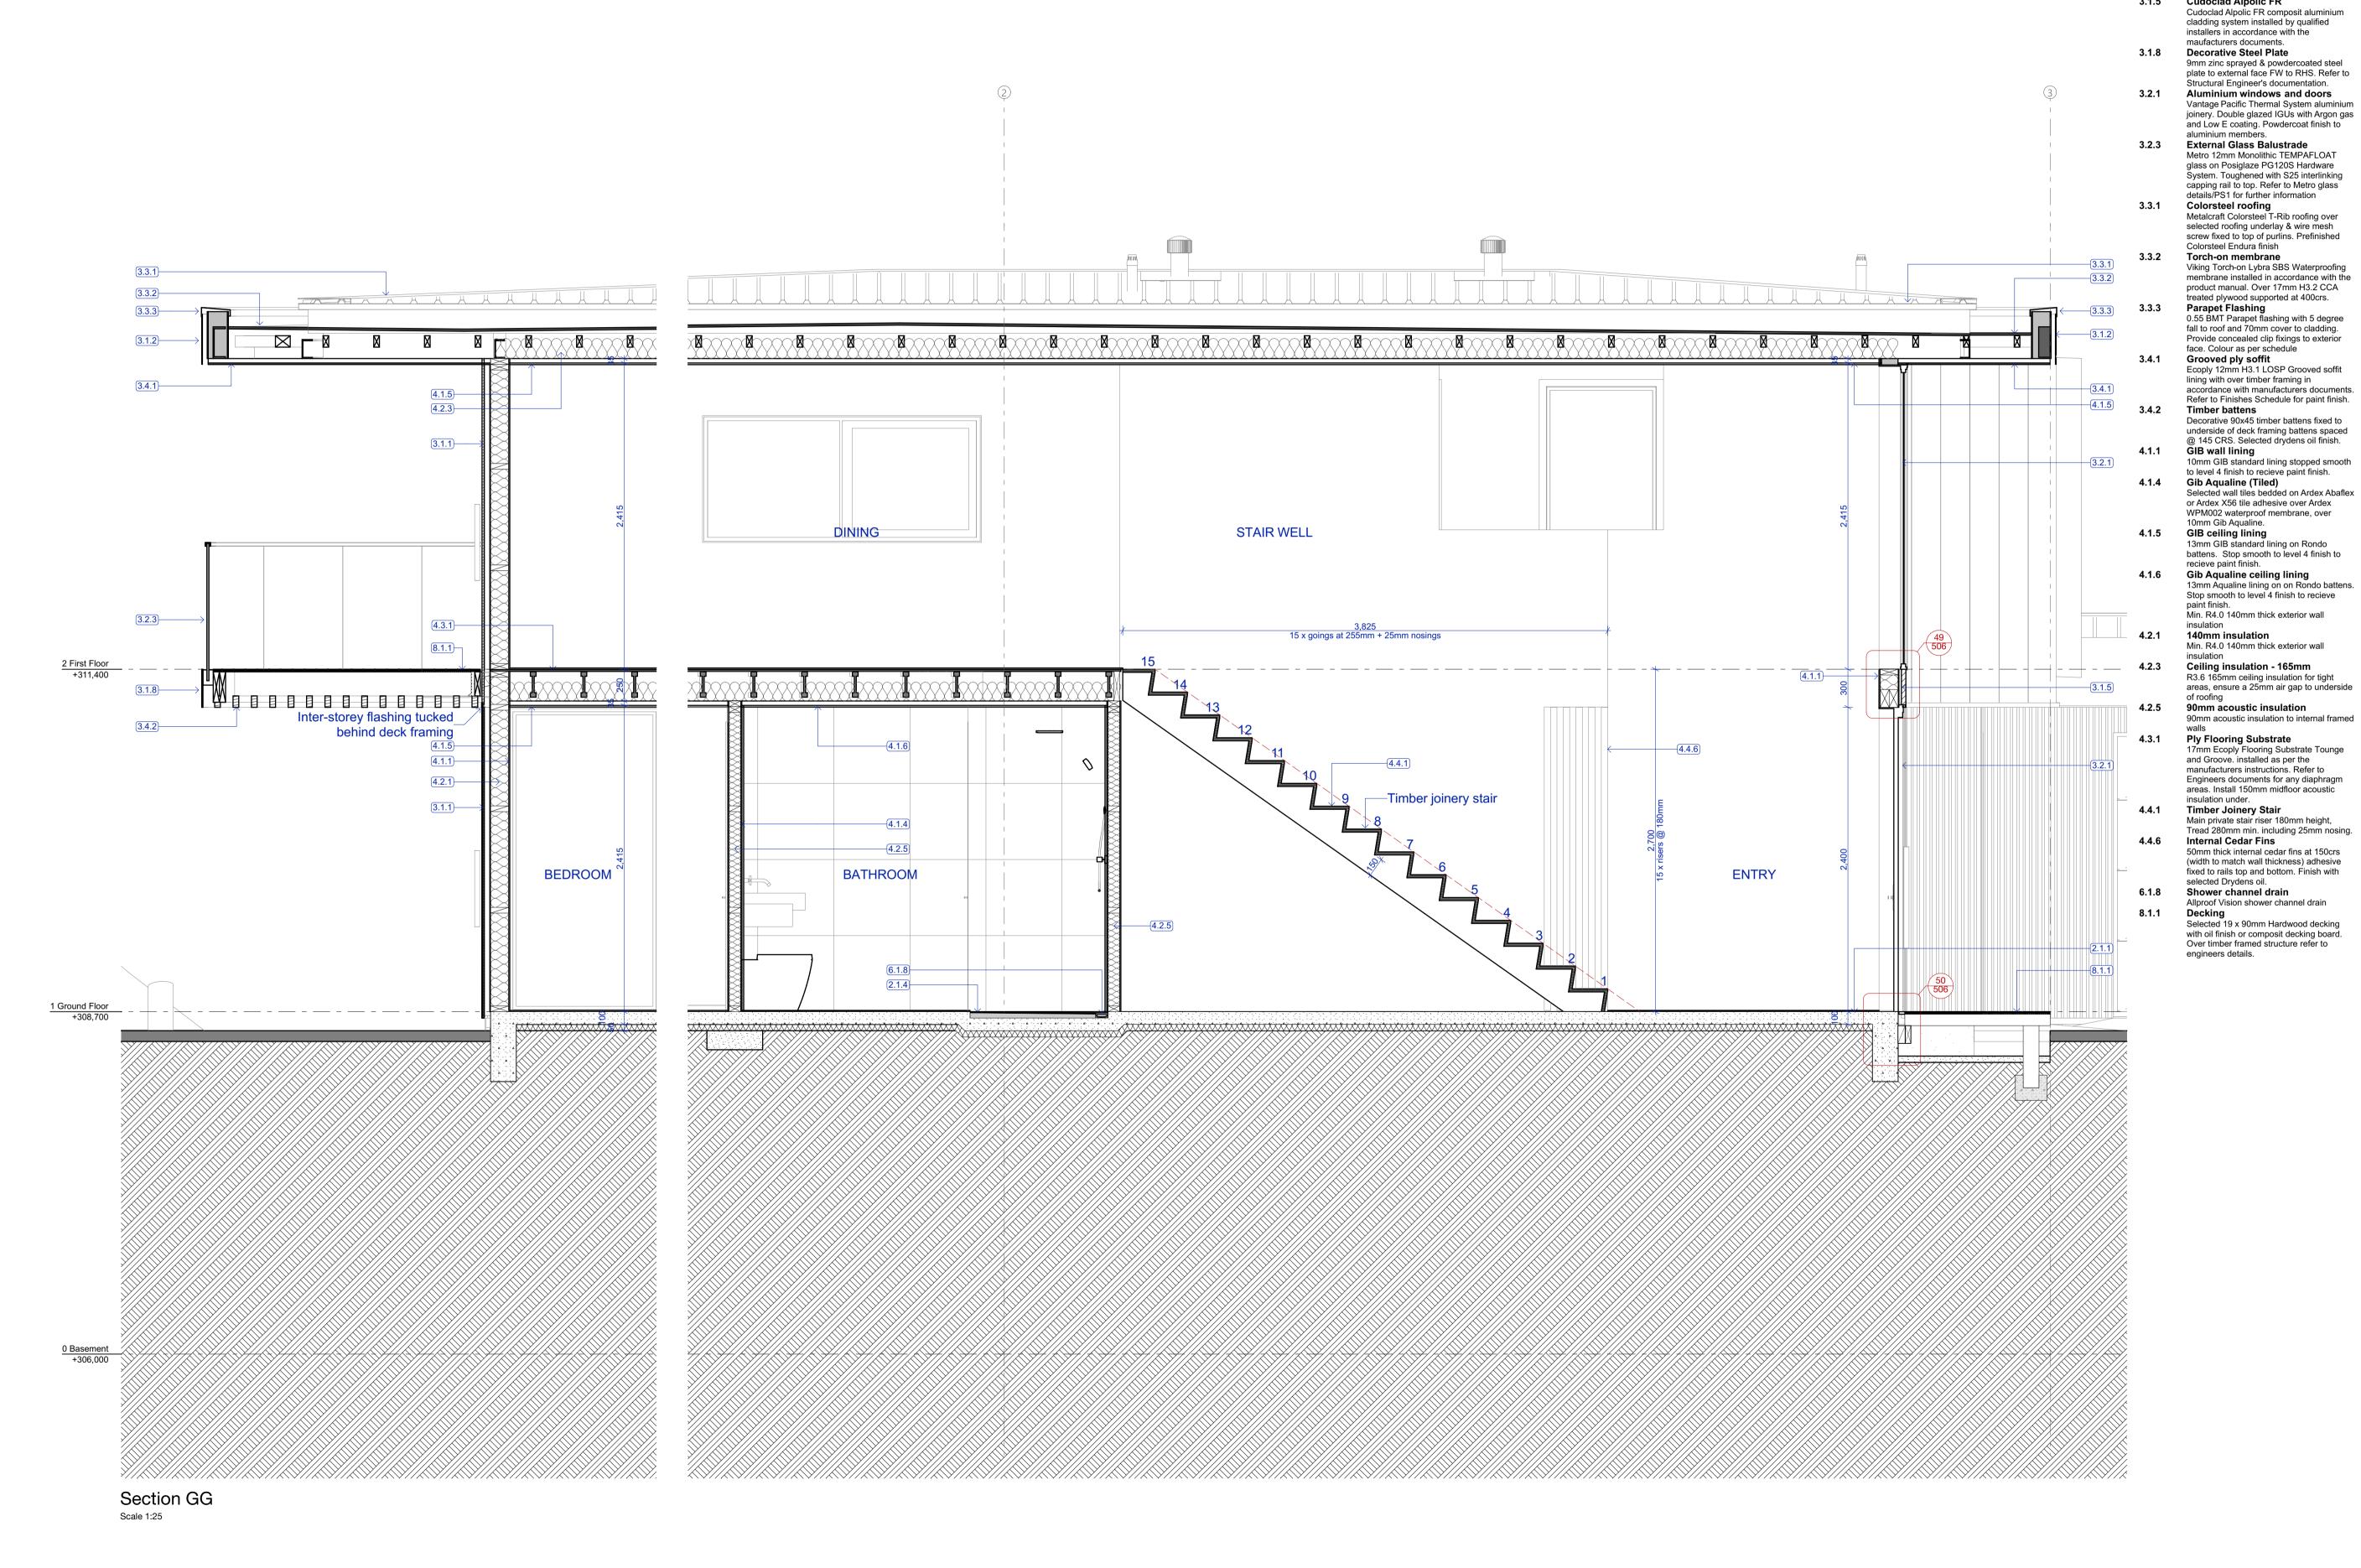3.1.1 Vert. Shiplap wall cladding

2.1.4 Shower rebate

100mm concrete slab over 50mm XPS

polestyrene on DPM on grade. Refer

Structural Engineer's documentation.

50mm shower rebate - Tile falls to channel drain. Refer Structural Engineer's

Rosenfeld Kidson RK58 vertical shiplap timber cladding over 45mm structural cavity

battens. Finish with selected Drydens oil. Installed as per the manufacturers documentation. (studs @ 600crs, Dwangs

Vertically fixed Euro-line powdercoated aluminium cladding. Installed as per the manufacturers documentation, by Flashclad nationwide distribution network. (studs @ 600crs, Dwangs @ 800crs)

All dimensions shall be verified on site by the contractor before starting any work or ordering any materials.
All work must comply with NZS 3604 2011 and the New Zealand Building Code.

Building Consent Issue

Three Sixty Architecture



Chalmers Street Apartments 20 Chalmers Street Wanaka

Section G

1:25, 1:250 Scale @ A1 File No. R19015 Date 9/06/2021 Revision

409


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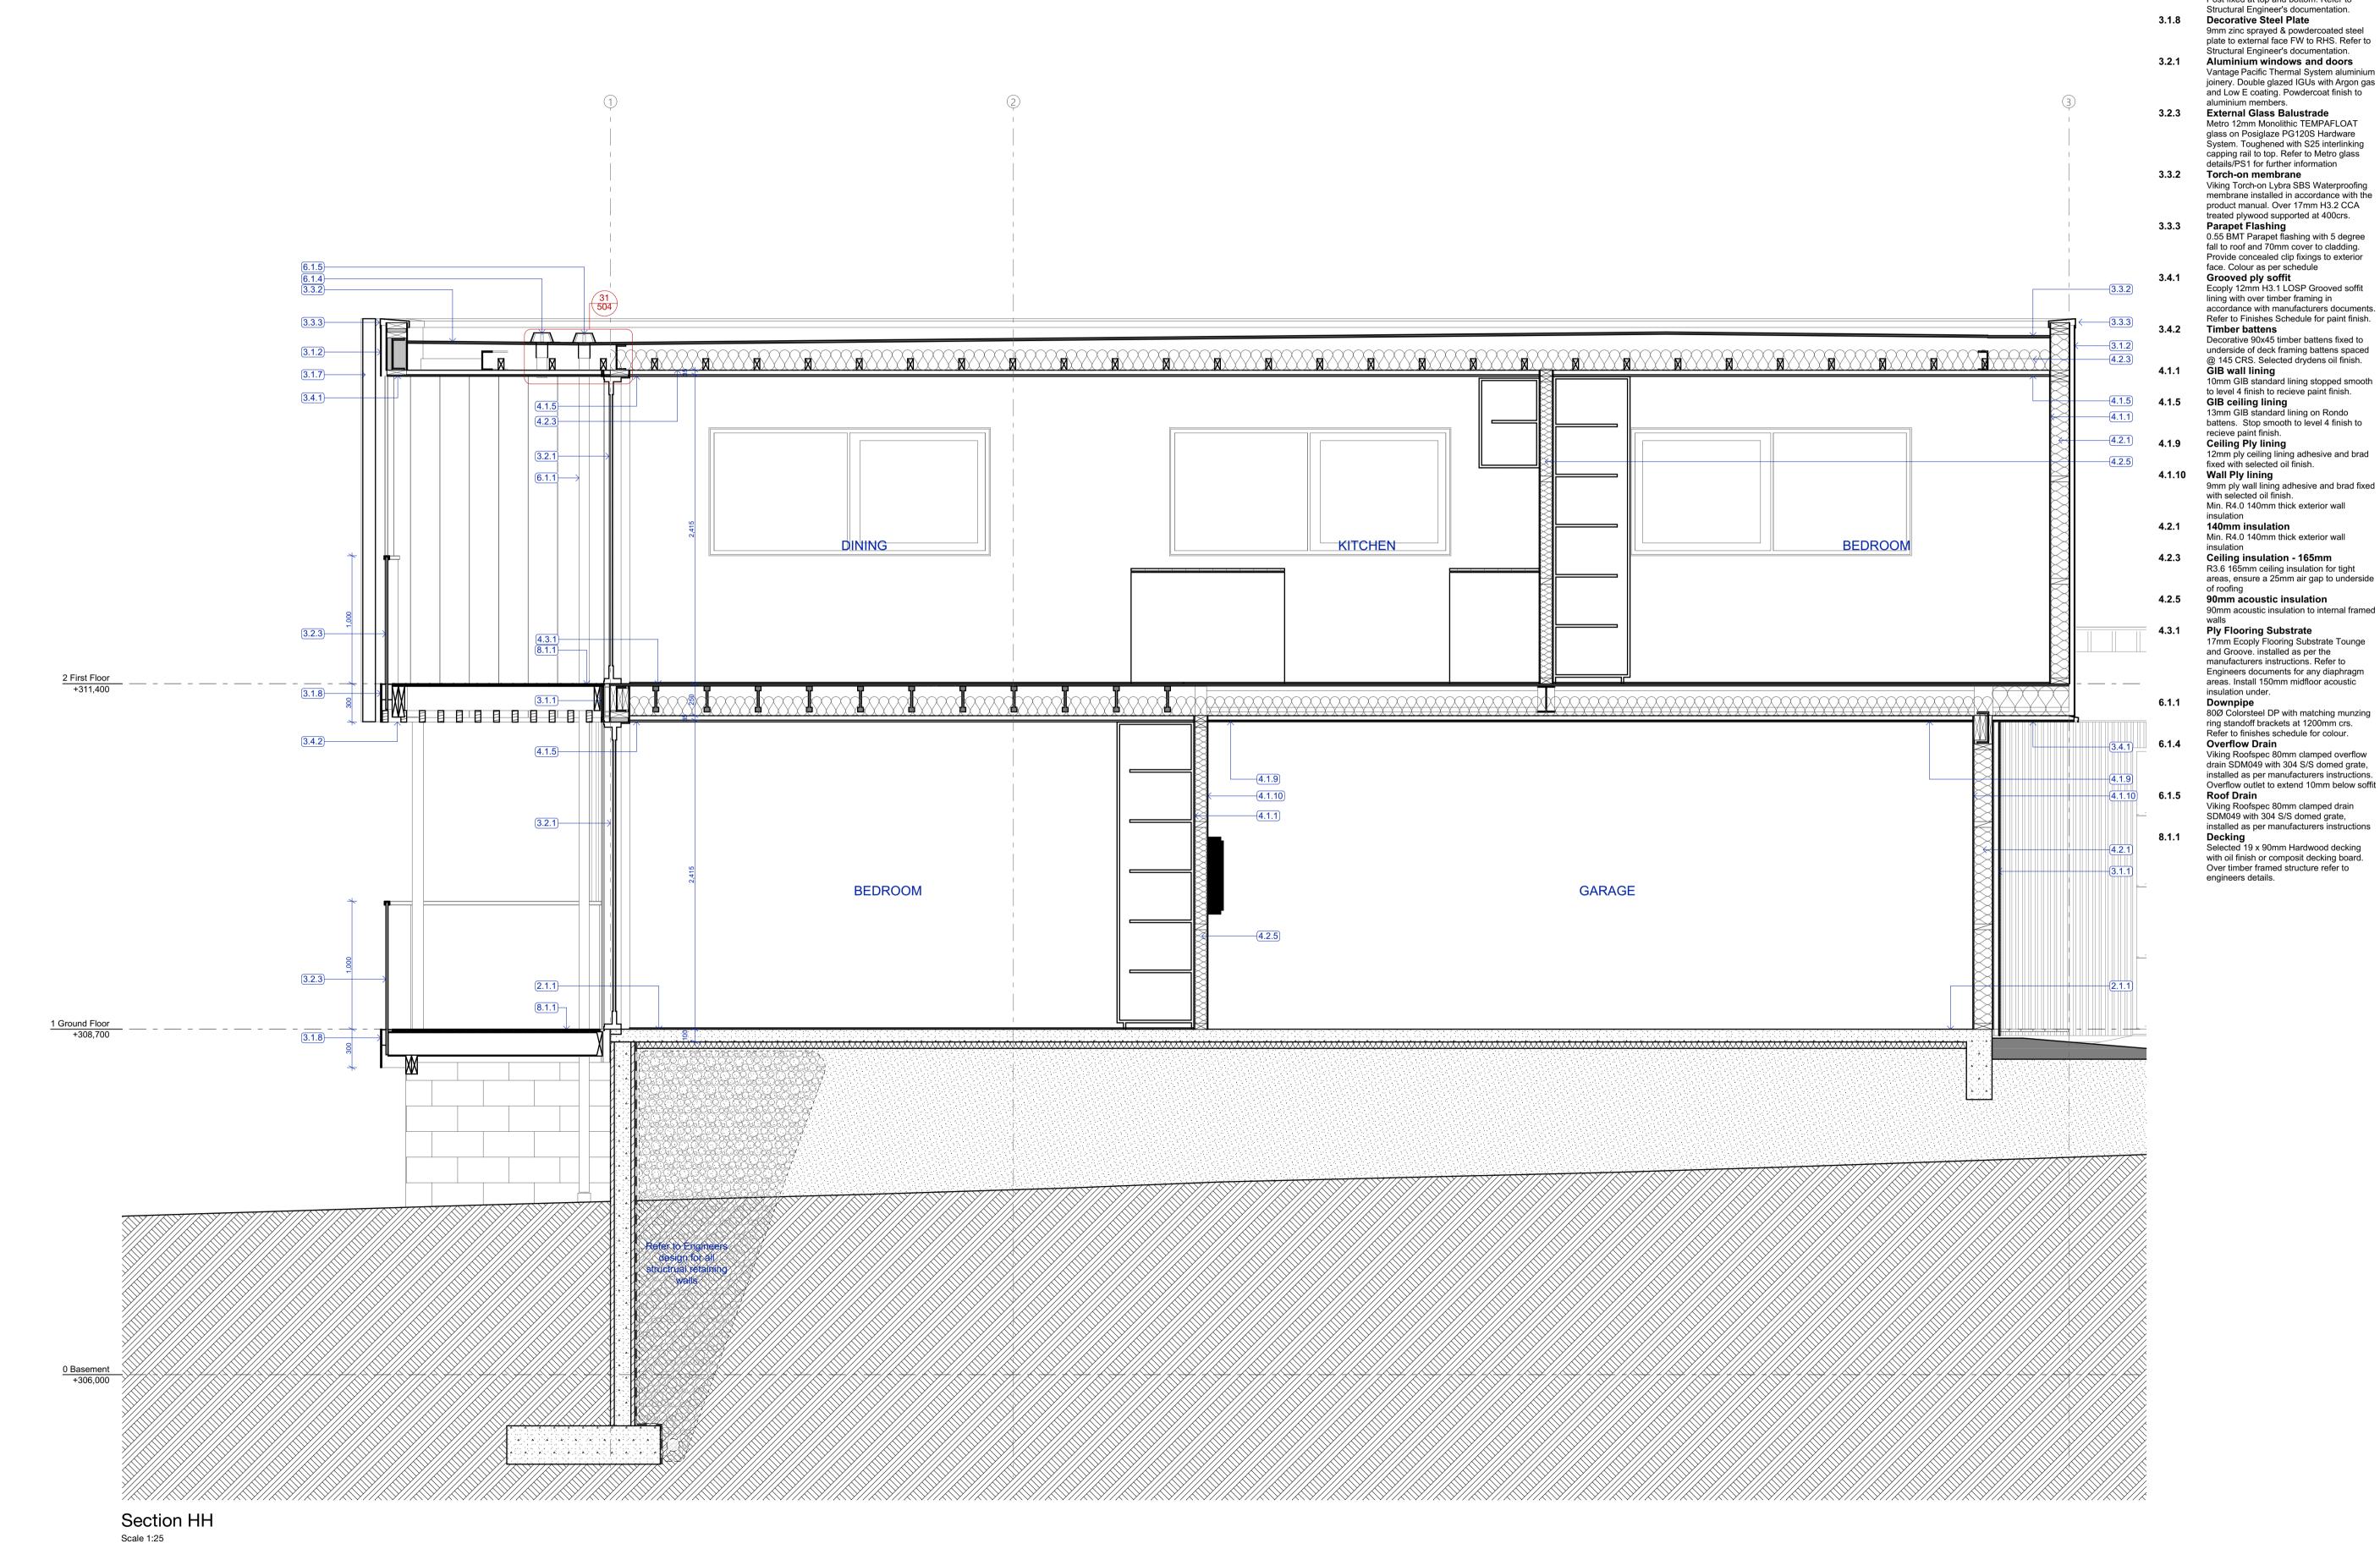
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Building Consent

Notes

2.1.1 Concrete slab on grade

3.1.1 Vert. Shiplap wall cladding

3.1.2 Flashclad Euro-line

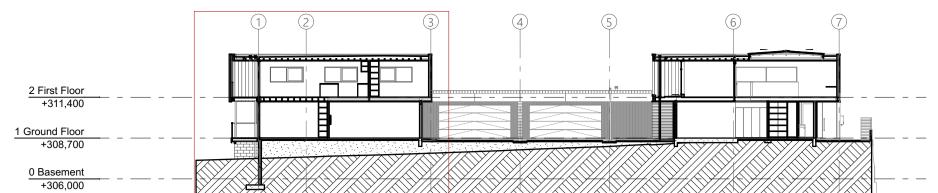Louvre

100mm concrete slab over 50mm XPS

Rosenfeld Kidson RK58 vertical shiplap timber cladding over 45mm structural cavity

battens. Finish with selected Drydens oil.

Vertically fixed Euro-line powdercoated aluminium cladding. Installed as per the manufacturers documentation, by Flashclad nationwide distribution network. (studs @ 600crs, Dwangs @ 800crs)

140x10mm powdercoated steel flat screw fixed both sides of 90x45 timber LVL post. Post fixed at top and bottom. Refer to

Installed as per the manufacturers documentation. (studs @ 600crs, Dwangs

polestyrene on DPM on grade. Refer

Structural Engineer's documentation.

All dimensions shall be verified on site by the contractor before starting any work or ordering any materials. All work must comply with NZS 3604 2011 and the New Zealand Building Code.

 Rev:
 Date:
 Issue:

 16/04/2021
 Building Consent Issue

Three Sixty Architecture



Chalmers Street
Apartments
20 Chalmers Street
Wanaka

Section H

 Scale @ A1
 1:25, 1:250

 File No.
 R19015

 Date
 9/06/2021

 Revision

410

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4.2.5

BEDROOM

GARAGE

2 First Floor +311,400 1 Ground Floor +308,700 0 Basement +306,000

3.3.2

6.1.5

3.3.3

3.1.2

3.4.1

3.2.1

3.3.2

6.1.6

3.3.3

3.1.2

4.1.9

4.2.1

4.1.10

6.1.1

3.1.4

3.2.1 Aluminium windows and doors

Vantage Pacific Thermal System aluminium joinery. Double glazed IGUs with Argon gas and Low E coating. Powdercoat finish to aluminium members. 3.3.1 Colorsteel roofing
Metalcraft Colorsteel T-Rib roofing over selected roofing underlay & wire mesh screw fixed to top of purlins. Prefinished Colorsteel Endura finish 3.3.2 Torch-on membrane Viking Torch-on Lybra SBS Waterproofing membrane installed in accordance with the product manual. Over 17mm H3.2 CCA treated plywood supported at 400crs. 3.3.3 Parapet Flashing 0.55 BMT Parapet flashing with 5 degree fall to roof and 70mm cover to cladding. Provide concealed clip fixings to exterior face. Colour as per schedule 3.4.1 Grooved ply soffit

Ecoply 12mm H3.1 LOSP Grooved soffit

lining with over timber framing in accordance with manufacturers documents.
Refer to Finishes Schedule for paint finish. 4.1.1 GIB wall lining 10mm GIB standard lining stopped smooth to level 4 finish to recieve paint finish. GIB ceiling lining 13mm GIB standard lining on Rondo 4.1.5 battens. Stop smooth to level 4 finish to (TRUSSES DESIGNED BY OTHERS) recieve paint finish. Ceiling Ply lining
12mm ply ceiling lining adhesive and brad fixed with selected oil finish. 4.1.10 Wall Ply lining 9mm ply wall lining adhesive and brad fixed 4.1.5 with selected oil finish.
Min. R4.0 140mm thick exterior wall insulation
140mm insulation 4.2.1 Min. R4.0 140mm thick exterior wall Ceiling insulation - 2 layer (210mm) R1.8 95mm + R2.2 115mm ceiling insulation, ensure a 25mm air gap to underside of roofing
Ceiling insulation - 165mm 4.1.1 R3.6 165mm ceiling insulation for tight areas, ensure a 25mm air gap to underside 4.2.1 STAIR STUDY 90mm acoustic insulation
90mm acoustic insulation to internal framed Ply Flooring Substrate
17mm Ecoply Flooring Substrate Tounge and Groove. installed as per the manufacturers instructions. Refer to Engineers documents for any diaphragm areas. Install 150mm midfloor acoustic insulation under. 6.1.1 **Downpipe** 80Ø Colorsteel DP with matching munzing ring standoff brackets at 1200mm crs. Refer to finishes schedule for colour. 6.1.5 Roof Drain Viking Roofspec 80mm clamped drain SDM049 with 304 S/S domed grate, installed as per manufacturers instructions installed as per manufacturers instructions

6.1.6 Althrough Drain

Viking Roofspac 80mm ALLThrough
balcony drain SDM057 installed as per
manufacturers instructions

6.2.1 Gas Hot Water Unit

EF26 Rinnai INFINITY or similar approved
instant gas hot water system instant gas hot water system. Gas bottle enclosure by landscape

KITCHEN

6.2.1

Building Consent

2.1.1 Concrete slab on grade

3.1.1 Vert. Shiplap wall cladding

@ 800crs)
3.1.2 Flashclad Euro-line

3.1.4 Horizontal Cedar Batten

Drydens oil.

100mm concrete slab over 50mm XPS

Rosenfeld Kidson RK58 vertical shiplap timber cladding over 45mm structural cavity

battens. Finish with selected Drydens oil.

Vertically fixed Euro-line powdercoated aluminium cladding. Installed as per the manufacturers documentation, by Flashclad nationwide distribution network. (studs @ 600crs, Dwangs @ 800crs)

Horizontal 60x20 cedar batten over 45mm H3.2 cavity battens (painted out black) over Concrete block walls. Finish with selected

polestyrene on DPM on grade. Refer

Structural Engineer's documentation.

Installed as per the manufacturers documentation. (studs @ 600crs, Dwangs

All dimensions shall be verified on site by the contractor before starting any work or ordering any materials.
All work must comply with NZS 3604 2011 and the New Zealand Building Code.

Building Consent Issue

Three Sixty Architecture



Chalmers Street Apartments 20 Chalmers Street Wanaka

Section H Continued

1:25, 1:250 Scale @ A1 File No. R19015 9/06/2021 Date


411

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Scale 1:25



Building Consent

100mm concrete slab over 50mm XPS

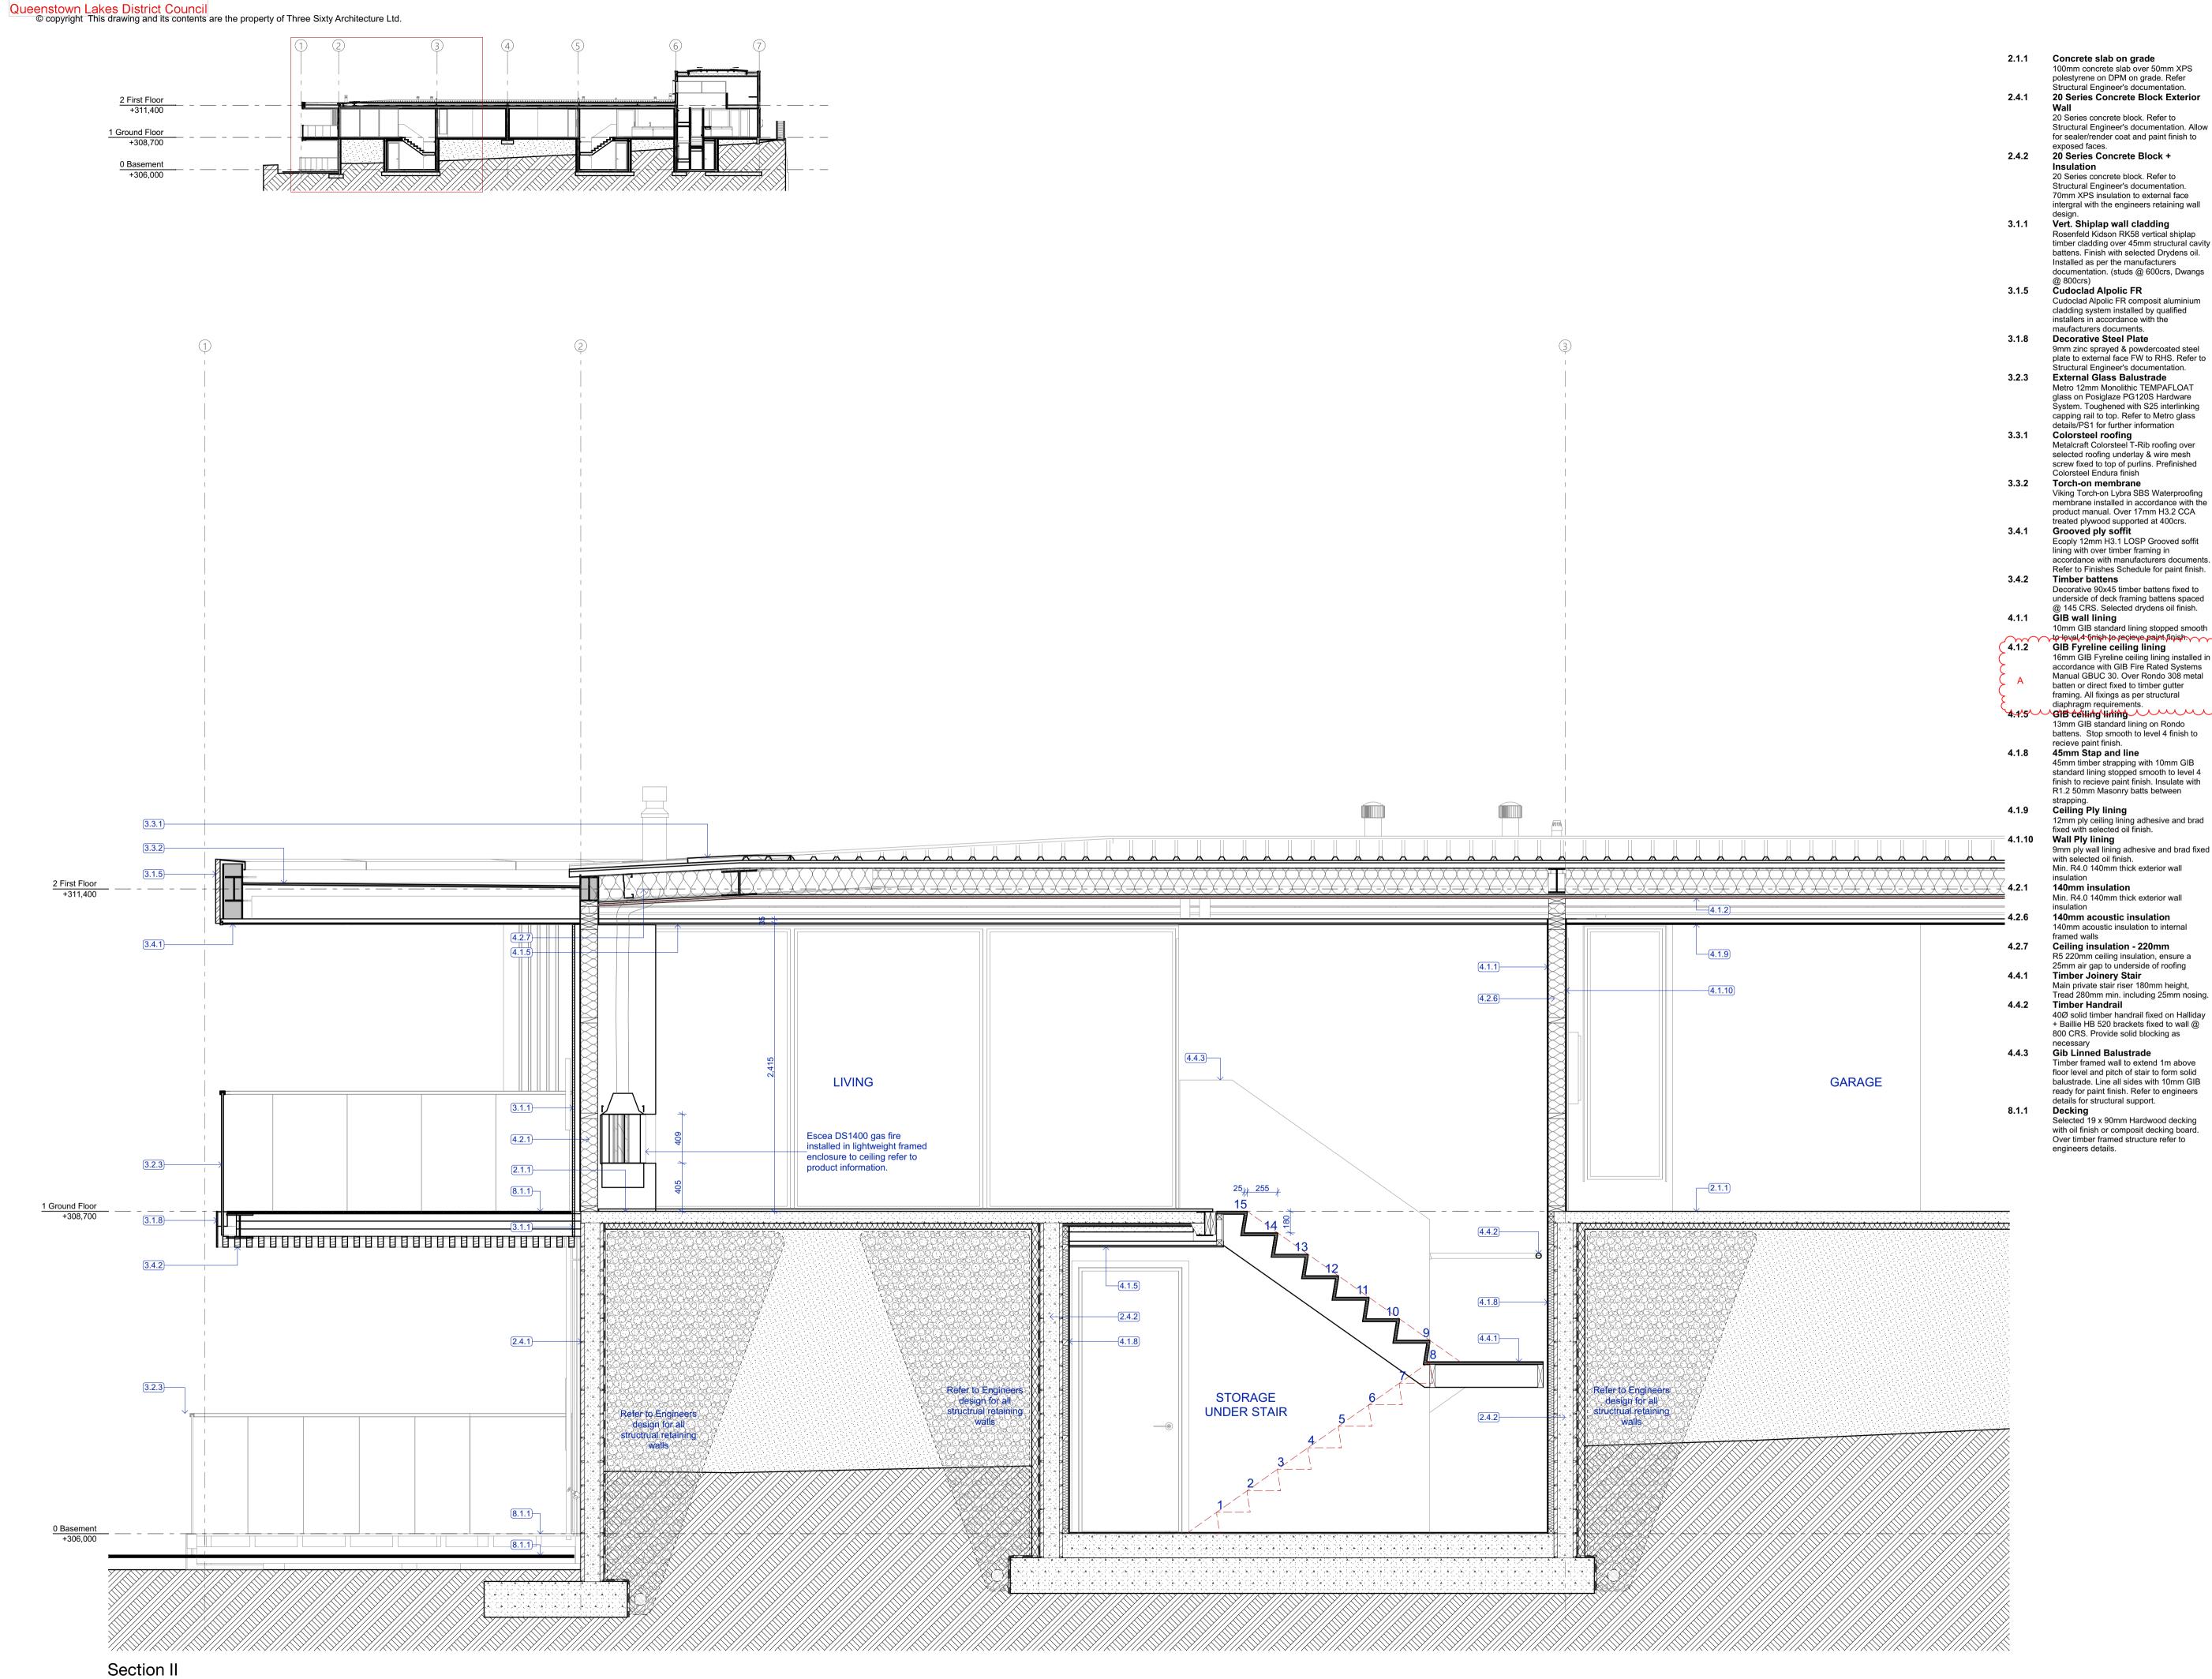polestyrene on DPM on grade. Refer

Structural Engineer's documentation.

20 Series Concrete Block Exterior 20 Series concrete block. Refer to

Structural Engineer's documentation. Allow

for sealer/render coat and paint finish to

20 Series concrete block. Refer to Structural Engineer's documentation. 70mm XPS insulation to external face intergral with the engineers retaining wall

Rosenfeld Kidson RK58 vertical shiplap timber cladding over 45mm structural cavity battens. Finish with selected Drydens oil. Installed as per the manufacturers documentation. (studs @ 600crs, Dwangs

Cudoclad Alpolic FR composit aluminium cladding system installed by qualified installers in accordance with the maufacturers documents.

9mm zinc sprayed & powdercoated steel plate to external face FW to RHS. Refer to

Metro 12mm Monolithic TEMPAFLOAT glass on Posiglaze PG120S Hardware System. Toughened with S25 interlinking capping rail to top. Refer to Metro glass details/PS1 for further information

selected roofing underlay & wire mesh screw fixed to top of purlins. Prefinished

Viking Torch-on Lybra SBS Waterproofing membrane installed in accordance with the product manual. Over 17mm H3.2 CCA treated plywood supported at 400crs.

lining with over timber framing in accordance with manufacturers documents. Refer to Finishes Schedule for paint finish.

Decorative 90x45 timber battens fixed to underside of deck framing battens spaced @ 145 CRS. Selected drydens oil finish.

10mm GIB standard lining stopped smooth to-level 4 finish to recieve paint finish.

16mm GIB Fyreline ceiling lining installed in accordance with GIB Fire Rated Systems Manual GBUC 30. Over Rondo 308 metal batten or direct fixed to timber gutter framing. All fixings as per structural

GIB Fyreline ceiling lining

13mm GIB standard lining on Rondo battens. Stop smooth to level 4 finish to

45mm timber strapping with 10mm GIB standard lining stopped smooth to level 4 finish to recieve paint finish. Insulate with R1.2 50mm Masonry batts between

12mm ply ceiling lining adhesive and brad

9mm ply wall lining adhesive and brad fixed

Min. R4.0 140mm thick exterior wall

Min. R4.0 140mm thick exterior wall

R5 220mm ceiling insulation, ensure a

Main private stair riser 180mm height, Tread 280mm min. including 25mm nosing.

40Ø solid timber handrail fixed on Halliday + Baillie HB 520 brackets fixed to wall @ 800 CRS. Provide solid blocking as

25mm air gap to underside of roofing

140mm acoustic insulation 140mm acoustic insulation to internal

Ceiling insulation - 220mm

details for structural support.

Selected 19 x 90mm Hardwood decking with oil finish or composit decking board. Over timber framed structure refer to

Decking

engineers details.

Timber Joinery Stair

Colorsteel Endura finish Torch-on membrane

GIB wall lining

recieve paint finish.

Ceiling Ply lining

Wall Ply lining

fixed with selected oil finish.

with selected oil finish.

140mm insulation

insulation

framed walls

exposed faces.

Insulation

All dimensions shall be verified on site by the contractor before starting any work or ordering any materials.
All work must comply with NZS 3604 2011 and the New Zealand Building Code.

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Three Sixty Architecture




Chalmers Street Apartments 20 Chalmers Street Wanaka

Section I

1:25, 1:250 Scale @ A1 File No. R19015 9/06/2021 Revision

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Building Consent

Notes

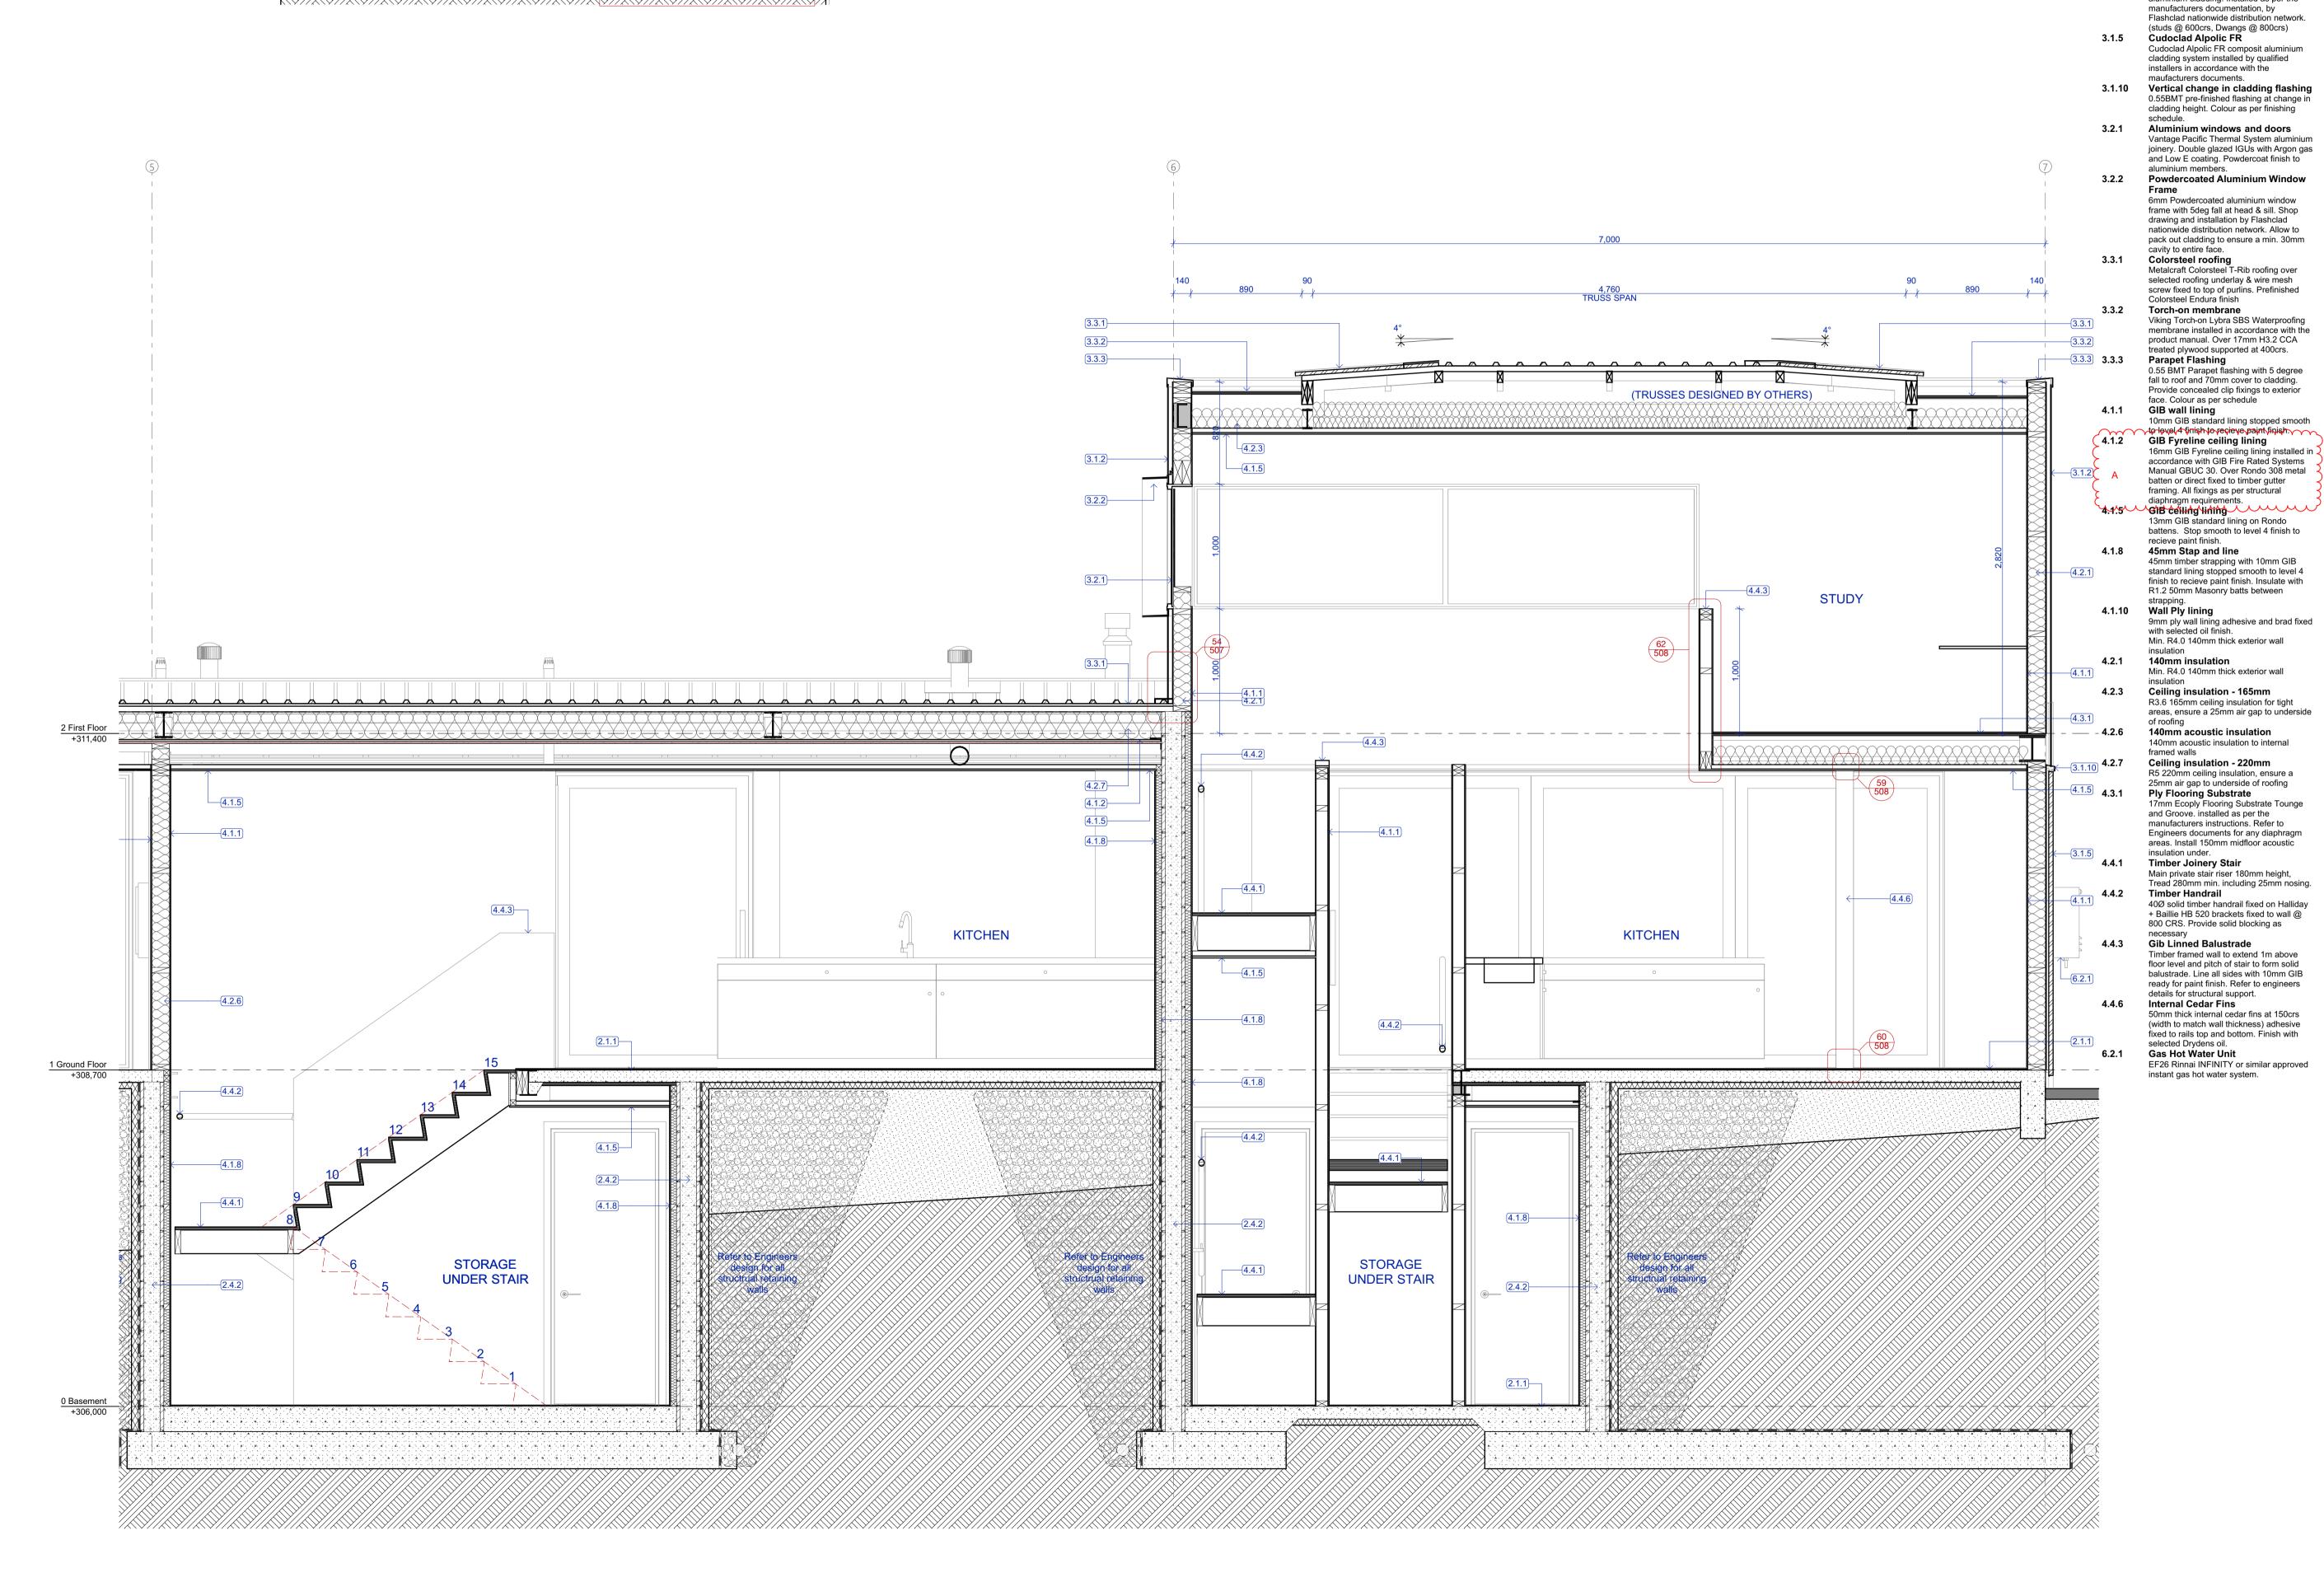2.1.1 Concrete slab on grade

2.4.2 20 Series Concrete Block +

100mm concrete slab over 50mm XPS

polestyrene on DPM on grade. Refer

Structural Engineer's documentation.

20 Series concrete block. Refer to Structural Engineer's documentation. 70mm XPS insulation to external face

3.1.2 Flashclad Euro-line

Vertically fixed Euro-line powdercoated aluminium claim. Installed as per the

intergral with the engineers retaining wall

All dimensions shall be verified on site by the contractor before starting any work or ordering any materials. All work must comply with NZS 3604 2011 and the New Zealand Building Code.

 Rev:
 Date:
 Issue:

 16/04/2021
 Building Consent Issue

Three Sixty Architecture



Chalmers Street
Apartments
20 Chalmers Street
Wanaka

Section I Continued

 Scale @ A1
 1:25, 1:250

 File No.
 R19015

 Date
 9/06/2021


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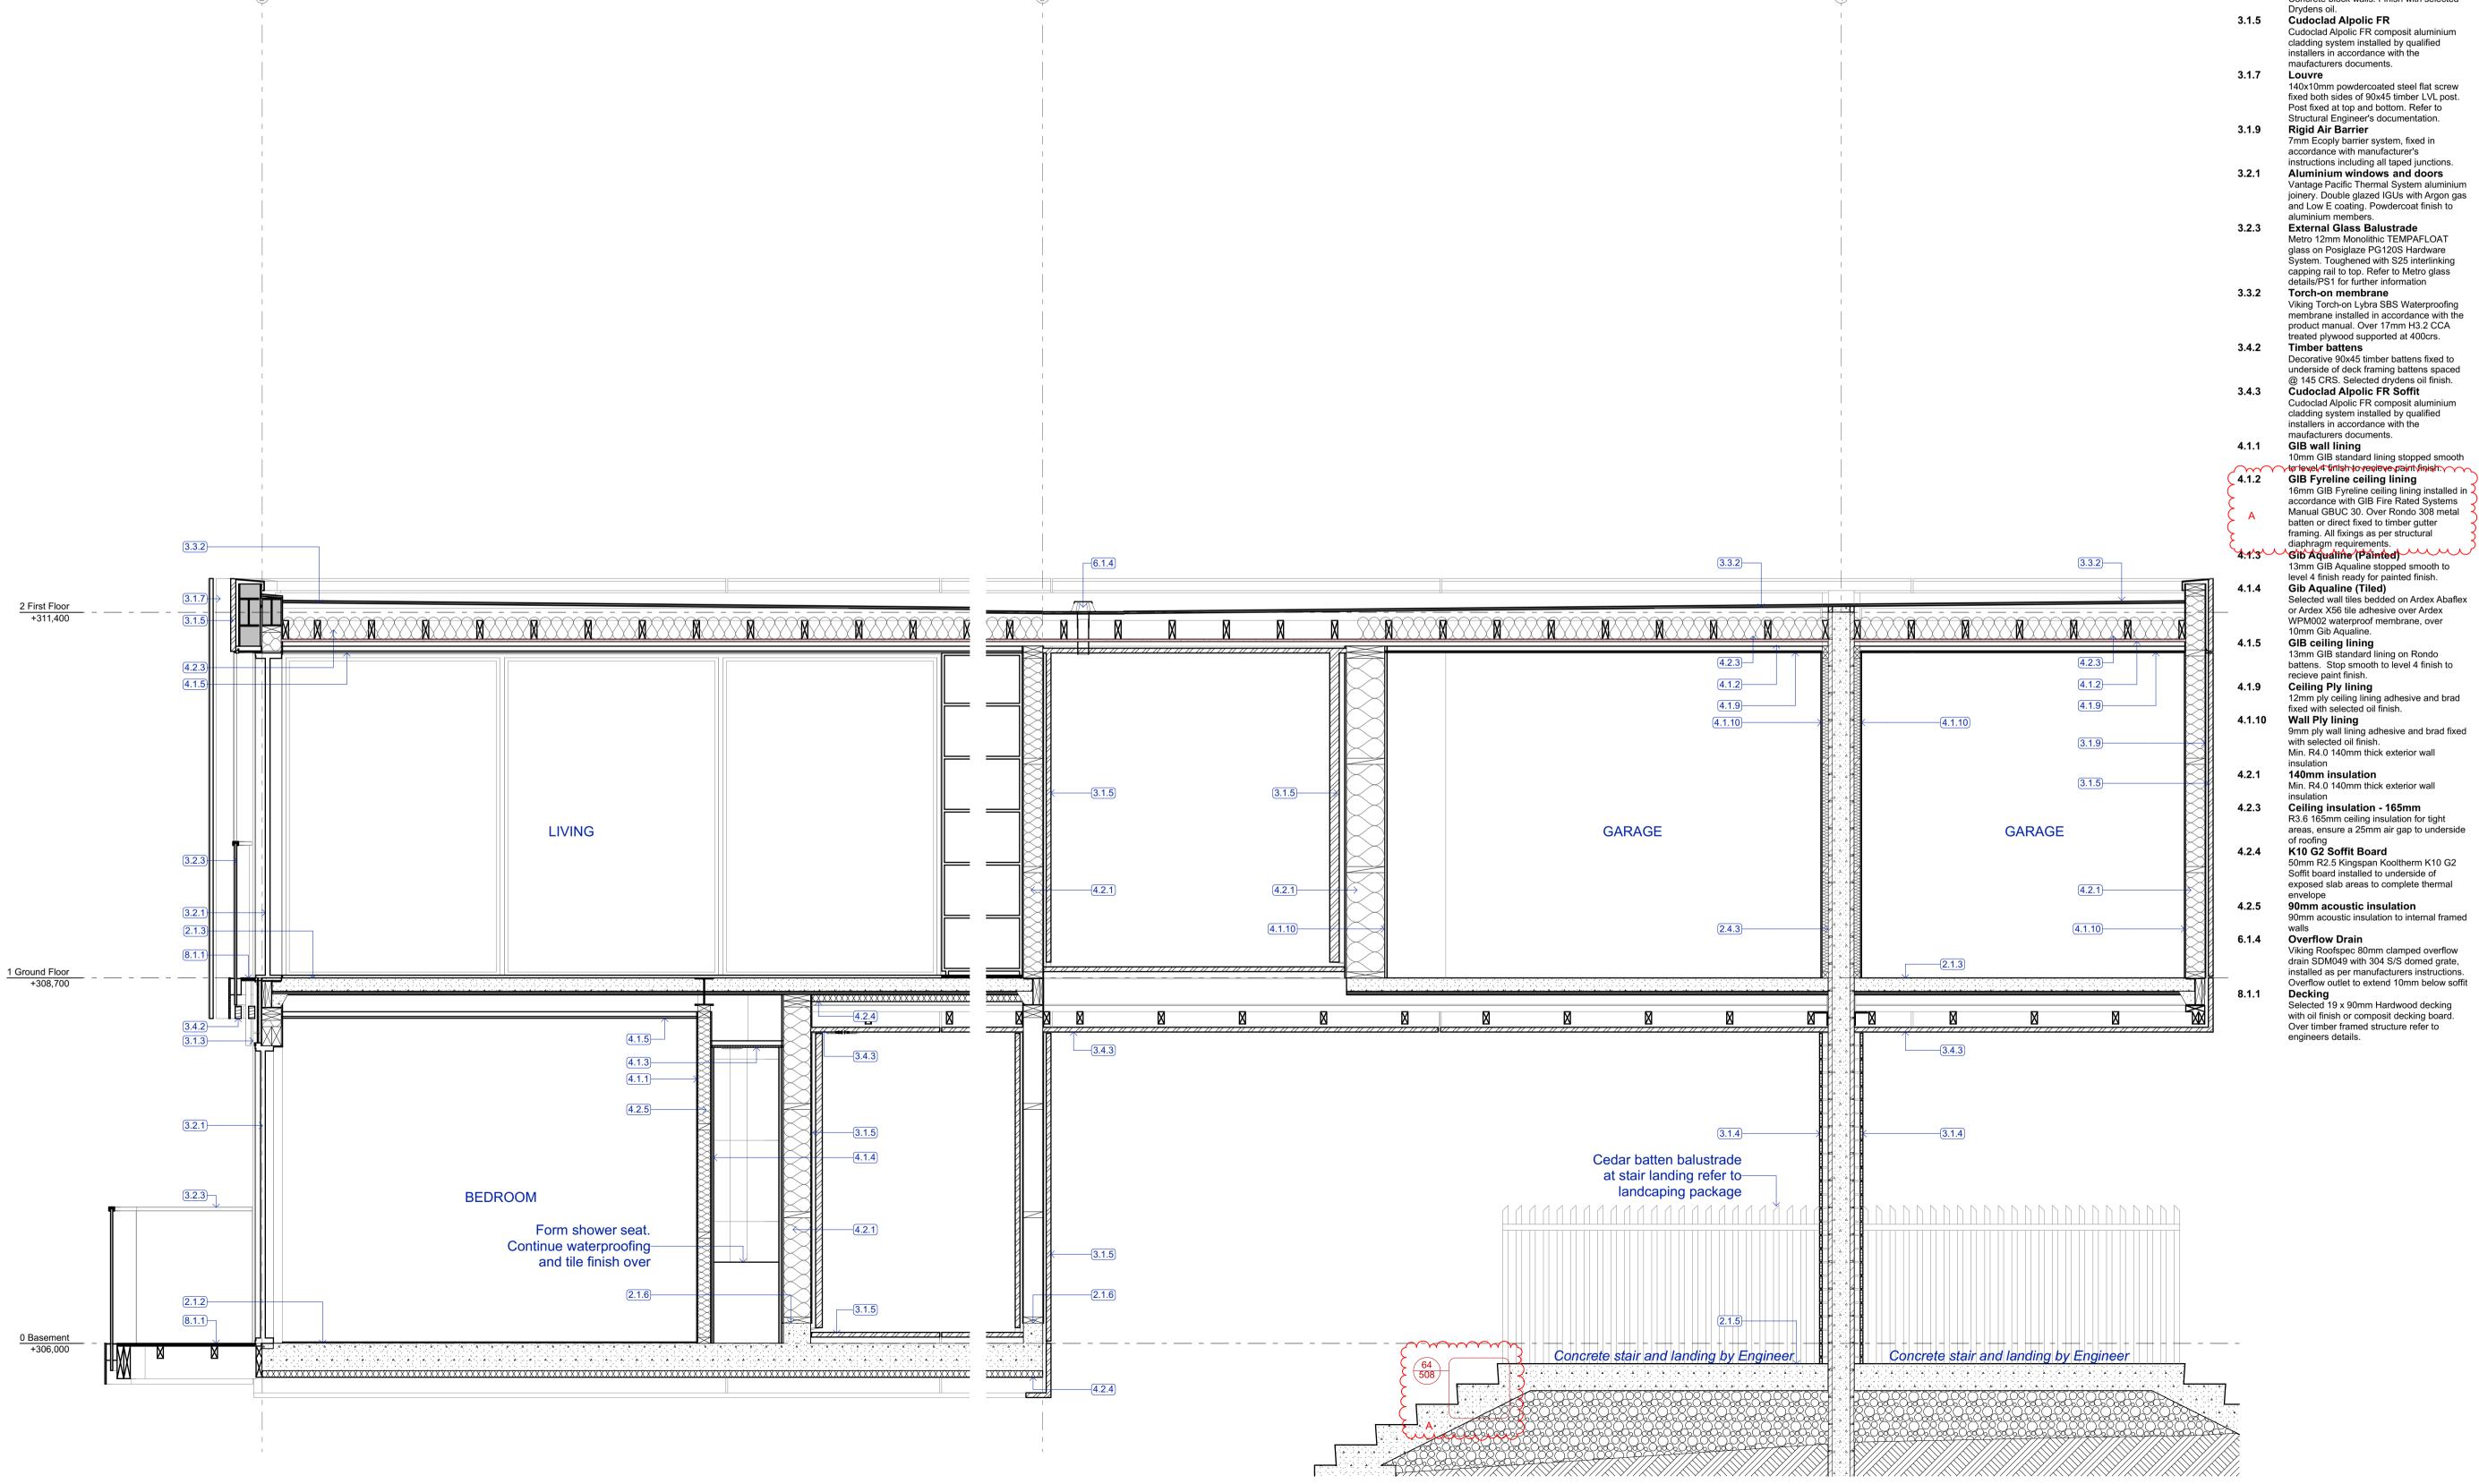
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Building Consent

2.1.2 Cantilevered slab

2.1.3 Stahlton floor

2.1.6 Concrete nib

3.1.3

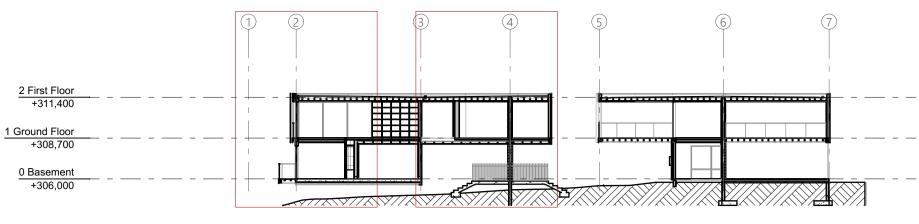documentation.

2.1.5 Precast concrete stair

Engineer's documentation

Engineer's documentation.

Engineer's documentation. 2.4.3 20 Series Concrete Block Wall

Vertical Cedar Batten

3.1.4 Horizontal Cedar Batten

Drydens oil.

Cantilevered 200mm concrete slab with

Soffit board installed to underside of exposed slab areas to complete thermal

envelope. Refer Structural Engineer's

Stahlton rib & infill with 125mm deep ribs and 100mm thick topping. Refer Structural

Precast concrete stair. Refer Structural

150mm Concrete nib. Refer Structural

Vertical 40x40 cedar batten rainscreen @ 100crs over 45mm H3.2 cavity battens (painted out black) over Titan Facade panel cladding system on 70x19mm CLD structural cavity batten. Finish with selected

Horizontal 60x20 cedar batten over 45mm H3.2 cavity battens (painted out black) over Concrete block walls. Finish with selected

Cudoclad Alpolic FR composit aluminium cladding system installed by qualified installers in accordance with the maufacturers documents.

140x10mm powdercoated steel flat screw fixed both sides of 90x45 timber LVL post. Post fixed at top and bottom. Refer to Structural Engineer's documentation.

Vantage Pacific Thermal System aluminium joinery. Double glazed IGUs with Argon gas and Low E coating. Powdercoat finish to

Metro 12mm Monolithic TEMPAFLOAT glass on Posiglaze PG120S Hardware System. Toughened with S25 interlinking capping rail to top. Refer to Metro glass details/PS1 for further information

Viking Torch-on Lybra SBS Waterproofing membrane installed in accordance with the product manual. Over 17mm H3.2 CCA treated plywood supported at 400crs.

Decorative 90x45 timber battens fixed to underside of deck framing battens spaced @ 145 CRS. Selected drydens oil finish.

Cudoclad Alpolic FR composit aluminium cladding system installed by qualified installers in accordance with the maufacturers documents.

10mm GIB standard lining stopped smooth

16mm GIB Fyreline ceiling lining installed in accordance with GIB Fire Rated Systems Manual GBUC 30. Over Rondo 308 metal batten or direct fixed to timber gutter framing. All fixings as per structural

13mm GIB Aqualine stopped smooth to level 4 finish ready for painted finish.

or Ardex X56 tile adhesive over Ardex WPM002 waterproof membrane, over

GIB ceiling lining 13mm GIB standard lining on Rondo

battens. Stop smooth to level 4 finish to

12mm ply ceiling lining adhesive and brad fixed with selected oil finish.

9mm ply wall lining adhesive and brad fixed

areas, ensure a 25mm air gap to underside

50mm R2.5 Kingspan Kooltherm K10 G2 Soffit board installed to underside of exposed slab areas to complete thermal

90mm acoustic insulation to internal framed

Viking Roofspec 80mm clamped overflow drain SDM049 with 304 S/S domed grate,

installed as per manufacturers instructions. Overflow outlet to extend 10mm below soffit

Selected 19 x 90mm Hardwood decking with oil finish or composit decking board.

Over timber framed structure refer to

Min. R4.0 140mm thick exterior wall

Min. R4.0 140mm thick exterior wall

Ceiling insulation - 165mm R3.6 165mm ceiling insulation for tight

90mm acoustic insulation

Overflow Drain

engineers details.

Decking

Selected wall tiles bedded on Ardex Abaflex

Gib Aqualine (Tiled)

10mm Gib Aqualine.

recieve paint finish.

Ceiling Ply lining

Wall Ply lining

with selected oil finish.

140mm insulation

7mm Ecoply barrier system, fixed in accordance with manufacturer's instructions including all taped junctions.

aluminium members.

20 Series concrete block. Refer to Structural Engineer's documentation.

50mm R2.5 Kingspan Kooltherm K10 G2

All dimensions shall be verified on site by the contractor before starting any work or ordering any materials.
All work must comply with NZS 3604 2011 and the New Zealand Building Code.

Building Consent Issue

Three Architecture



Chalmers Street Apartments 20 Chalmers Street Wanaka

Section J


1:25, 1:250 Scale @ A1 File No. R19015 9/06/2021 Date Revision


414

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Building Consent

Notes ·

2.1.3 Stahlton floor

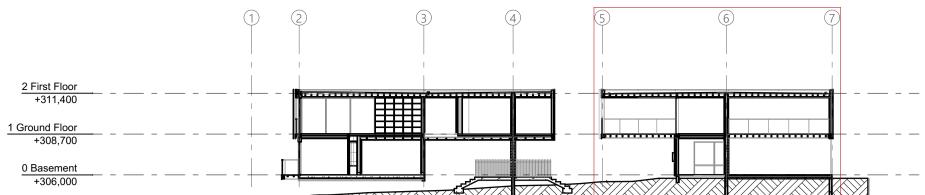2.2.3 SHS 89x89

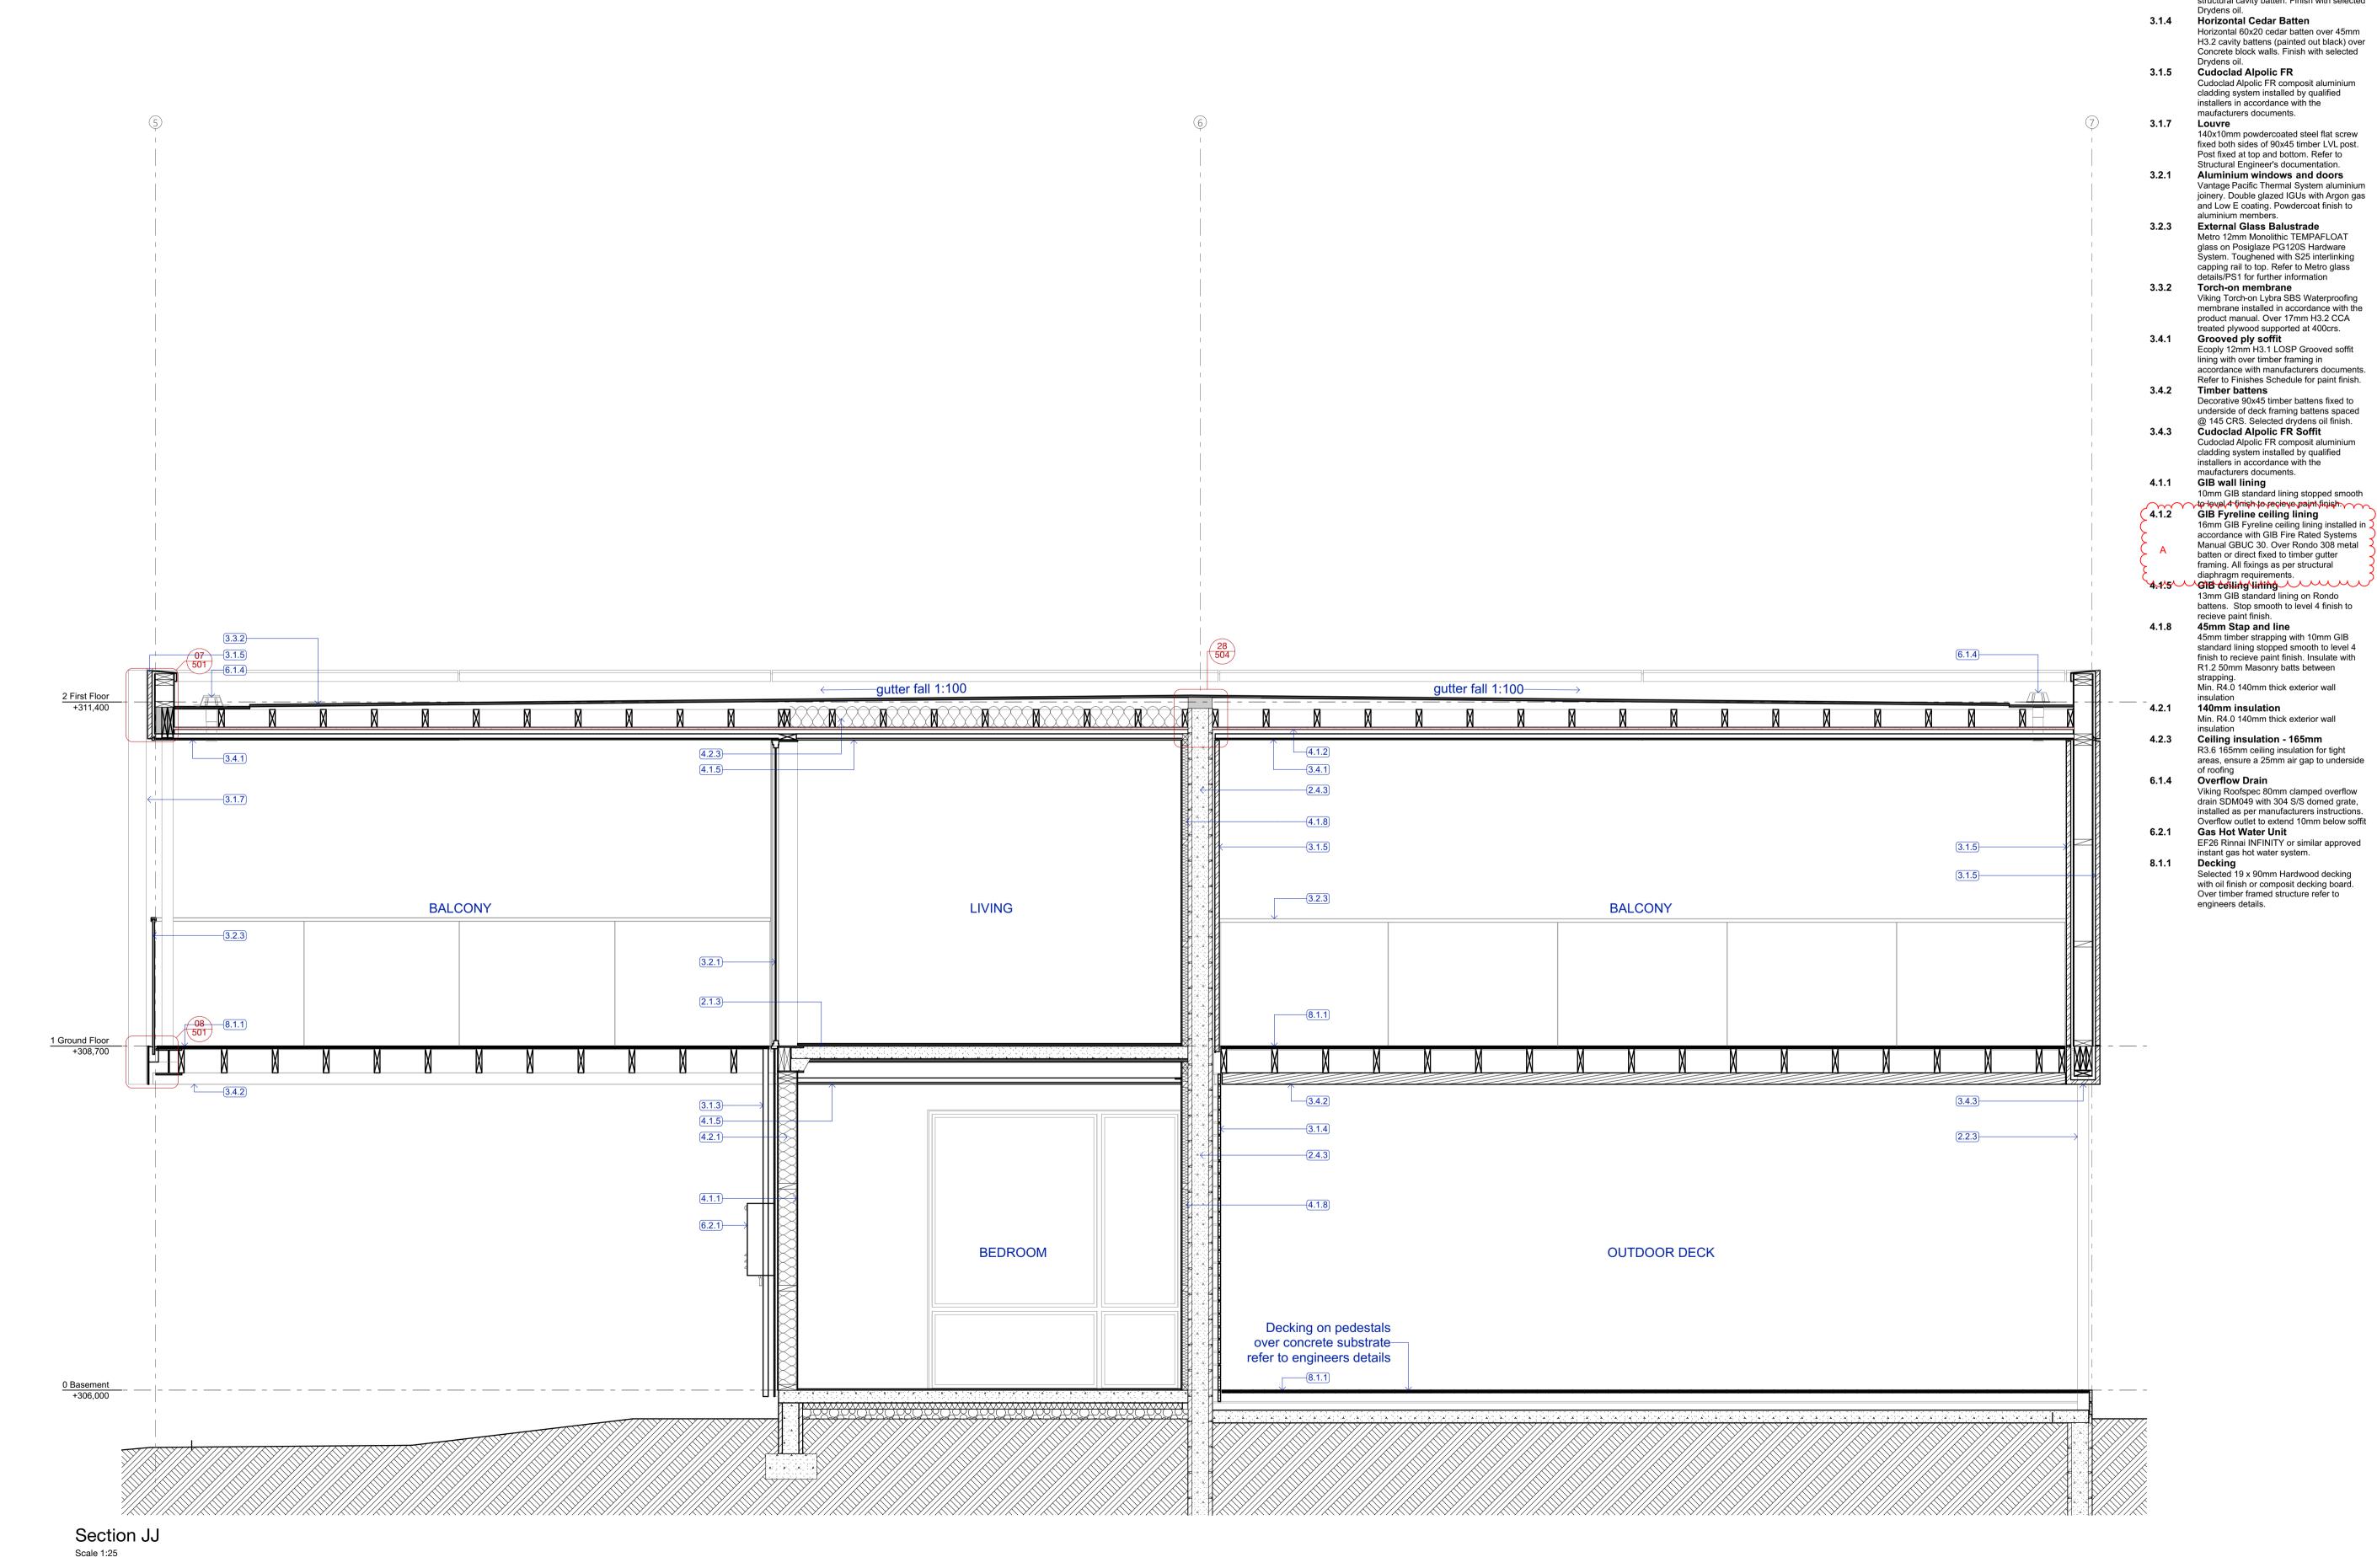Stahlton rib & infill with 125mm deep ribs

89x6 SHS. Refer to Structural Engineer's documentation. Refer to Specification for

paint finish where steelwork is exposed.

20 Series concrete block. Refer to Structural Engineer's documentation.

Ensure separation layer to timber where

Vertical 40x40 cedar batten rainscreen @ 100crs over 45mm H3.2 cavity battens (painted out black) over Titan Facade panel cladding system on 70x19mm CLD structural cavity batten. Finish with selected

Engineer's documentation.

packing proposed.

2.4.3 20 Series Concrete Block Wall

3.1.3 Vertical Cedar Batten

and 100mm thick topping. Refer Structural

All dimensions shall be verified on site by the contractor before starting any work or ordering any materials.
All work must comply with NZS 3604 2011 and the New Zealand Building Code.

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 Date:
 Issue:

 16/04/2021
 Building Consent Issue

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 9/06/2021
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Three Sixty Architecture



Chalmers Street
Apartments
20 Chalmers Street
Wanaka

Section J Continued

 Scale @ A1
 1:25, 1:250

 File No.
 R19015


 Date
 9/06/2021

 Revision
 A


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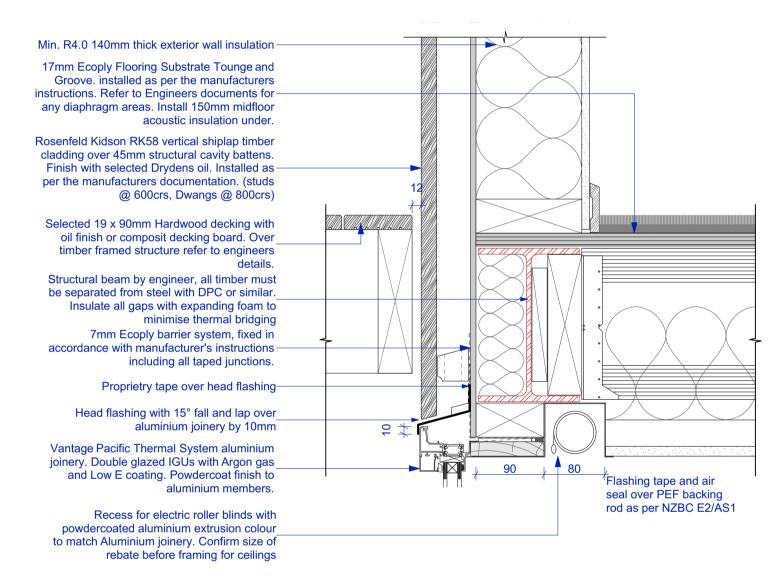
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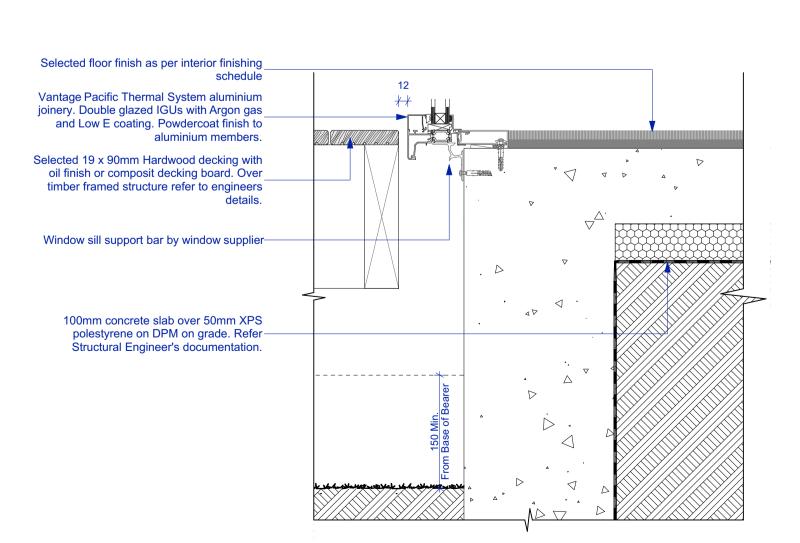
10 Steel Support Cladding Base
401 Scale 1:5



11 Vert. Shiplap to Soffit 401 Scale 1:5

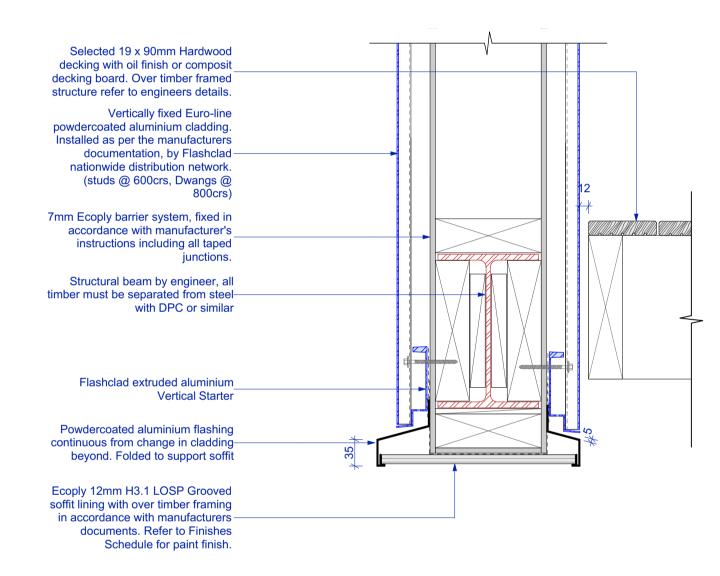


Deck to Inter-story Floor Scale 1:5

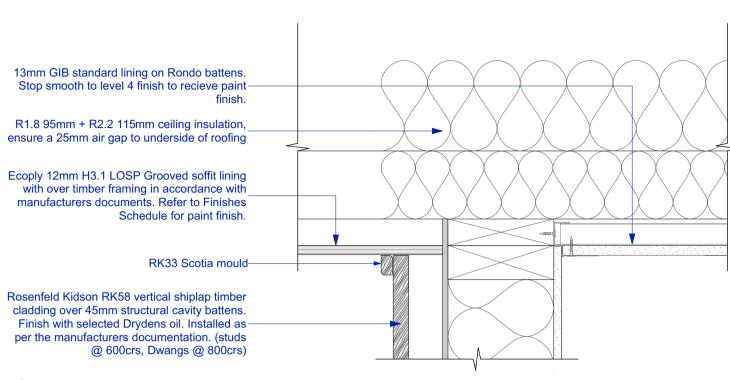

13 Deck to Window Base

401 Scale 1:5

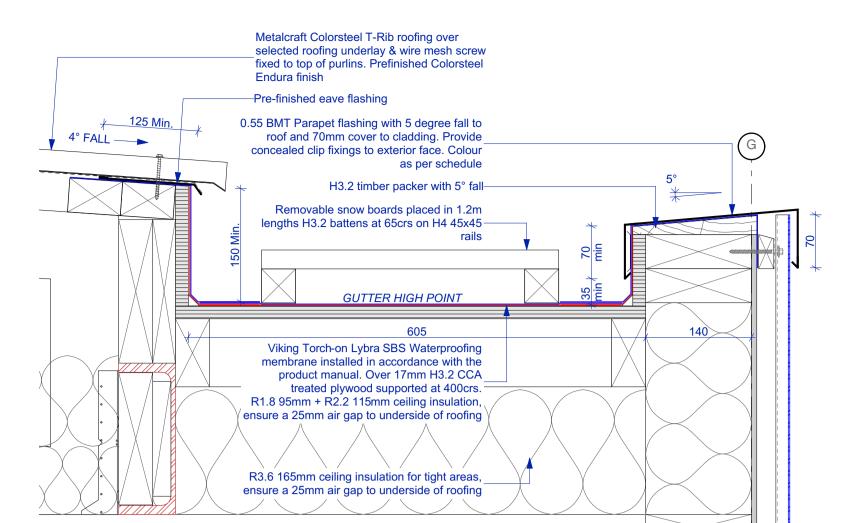

13mm GIB standard lining on Rondo battens. Stop smooth to level 4 finish to recieve paint-

Vertically fixed Euro-line powdercoated

aluminium cladding. Installed as per the


manufacturers documentation, by Flashclad

nationwide distribution network. (studs @


600crs, Dwangs @ 800crs)

14 Parapet/Internal gutter

401 / Scale 1:5

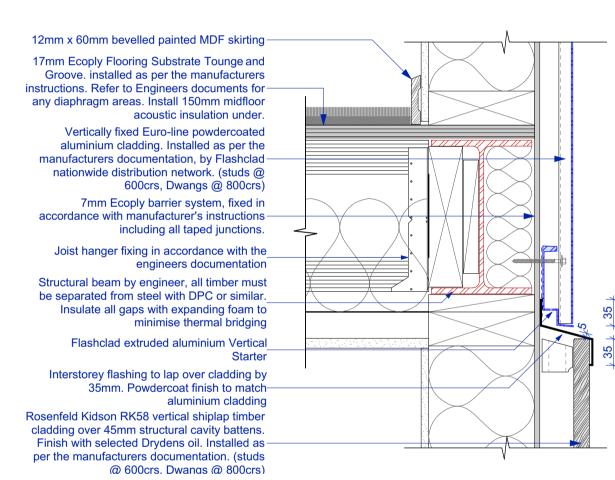

15 Vertical Cladding Change
401 Scale 1:5

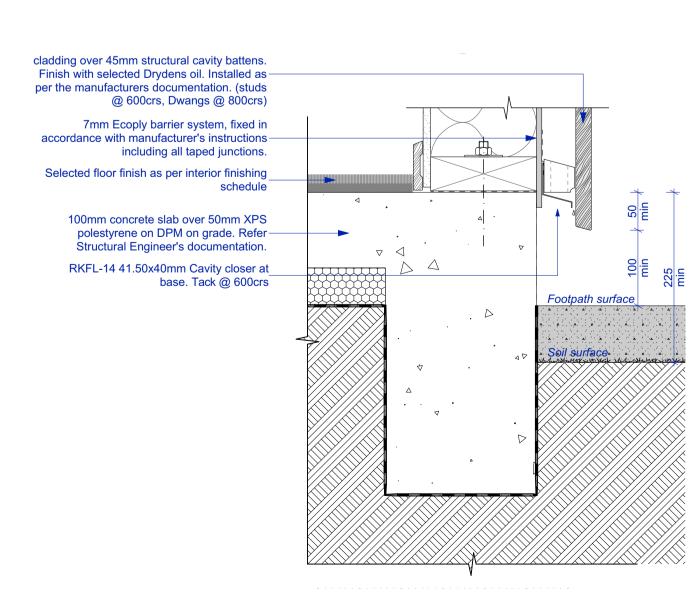

16 Vert. Shiplap Base 401 Scale 1:5

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All work must comply with NZS 3604 2011 and the New Zealand Building Code.

Building Consent Issue

Three Sixty **Architecture**



Chalmers Street Apartments 20 Chalmers Street Wanaka

Details


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502


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17 Parapet band to vert. shiplap




Schedule for paint finish.

Ecoply 12mm H3.1 LOSP Grooved soffit lining

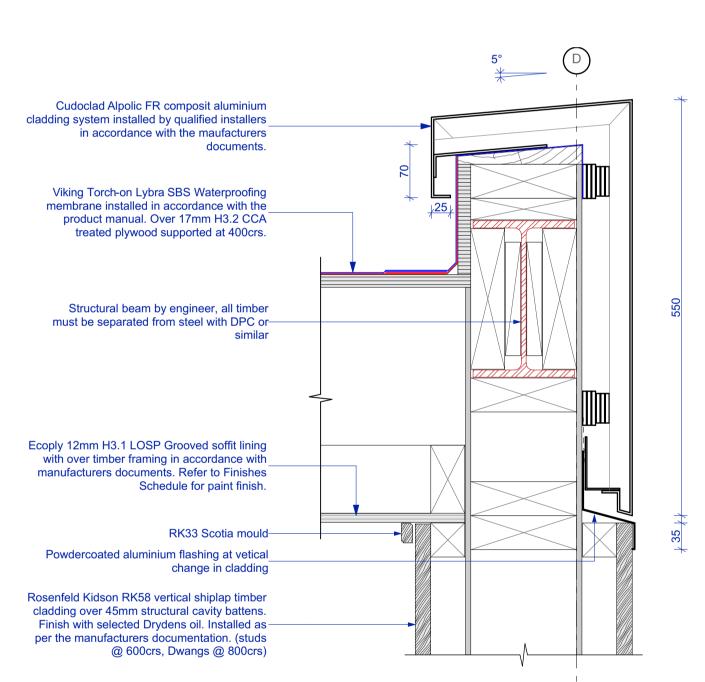
with over timber framing in accordance with

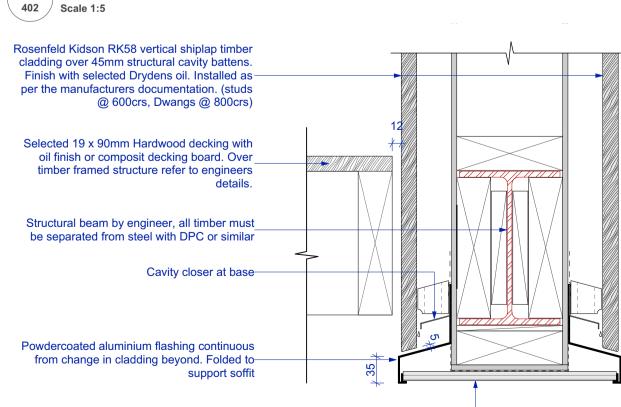manufacturers documents. Refer to Finishes


18 Steel Support Cladding Base 402 / Scale 1:5

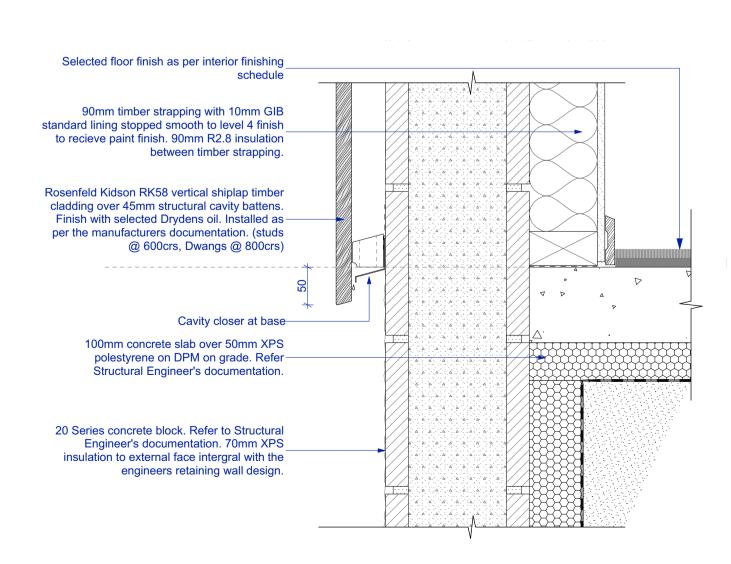


19 Vert. Shiplap over Block

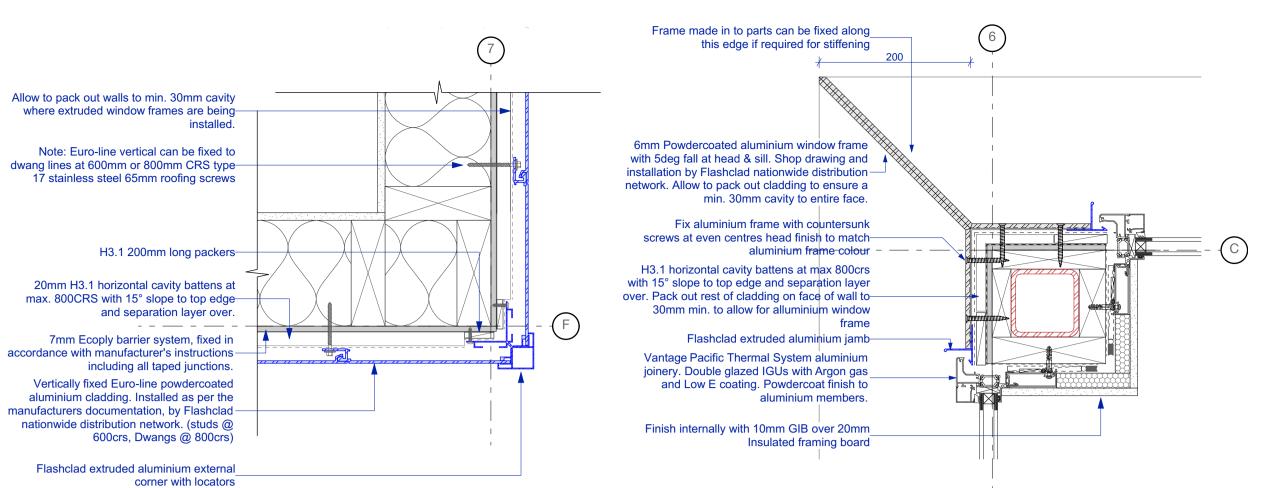


20 Flashclad External Corner 206 / Scale 1:5

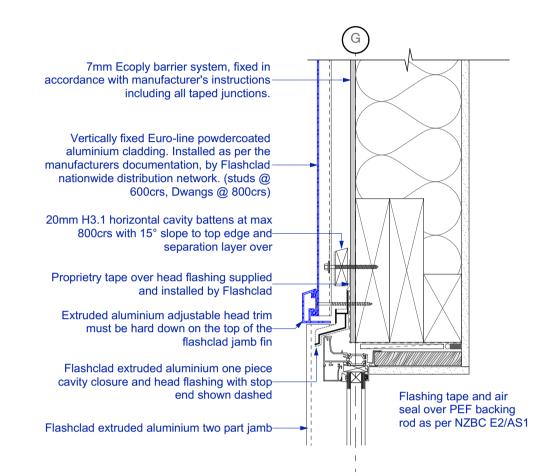

Flashclad Window Head

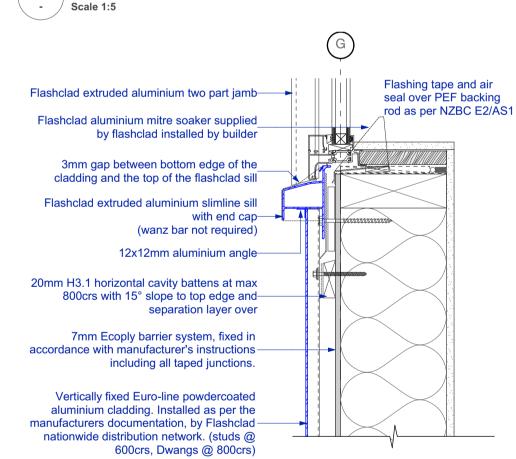


22 Flashclad Window Sill Scale 1:5

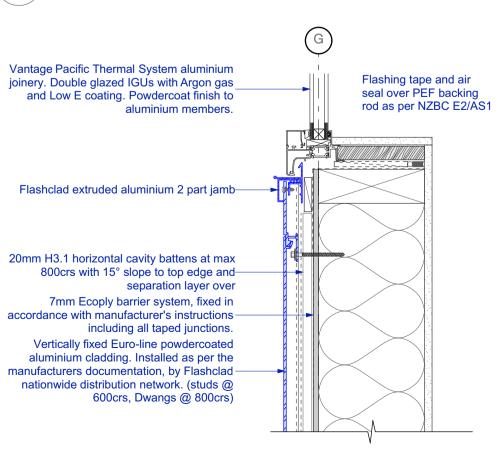


23 Flashclad Window Jamb

24 Flashclad Window Jamb with Corner Frame 206 / Scale 1:5

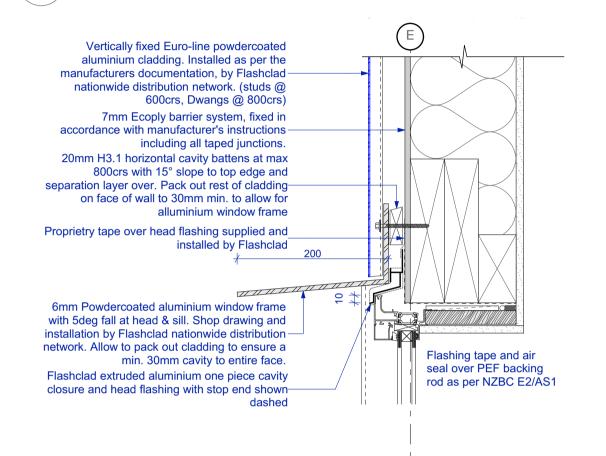


25 Flashclad Window Head with Frame

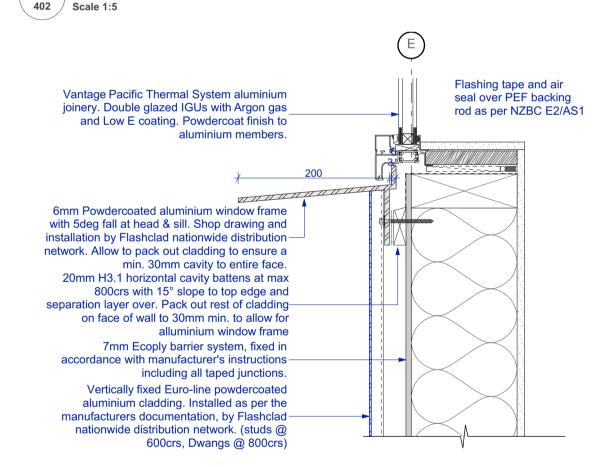

27 Flashclad Window Sill with Frame

402 / Scale 1:5

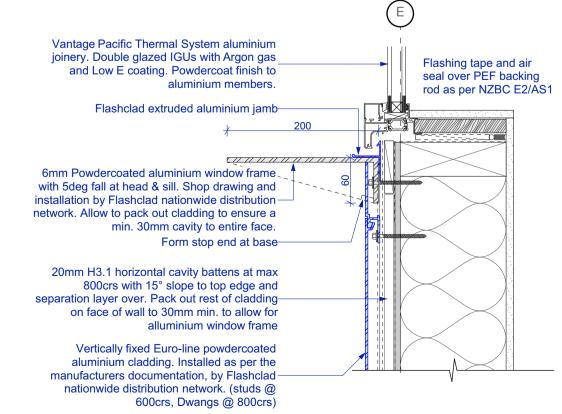

28 Flashclad Window Jamb with Frame

206 Scale 1:5

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All work must comply with NZS 3604 2011 and the New Zealand Building Code.

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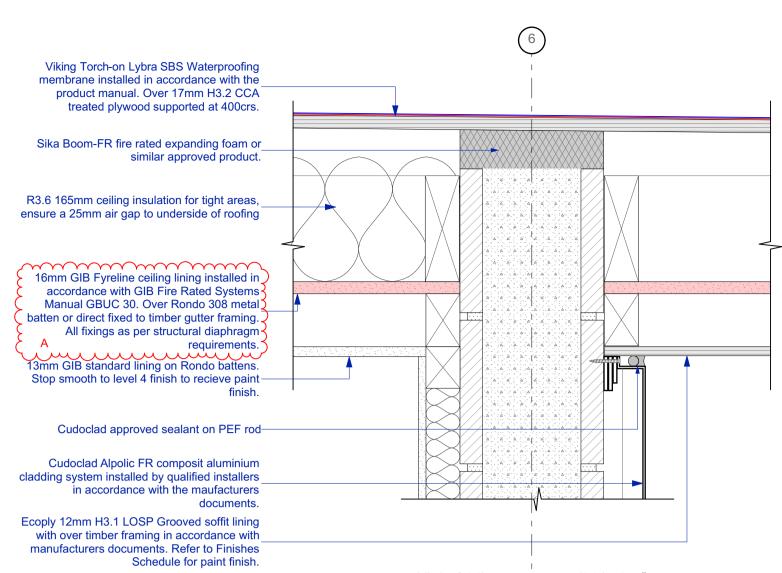
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Sheet No.	503
Revision	-
Date	9/06/2021
File No.	R19015
Scale @ A1	1:5

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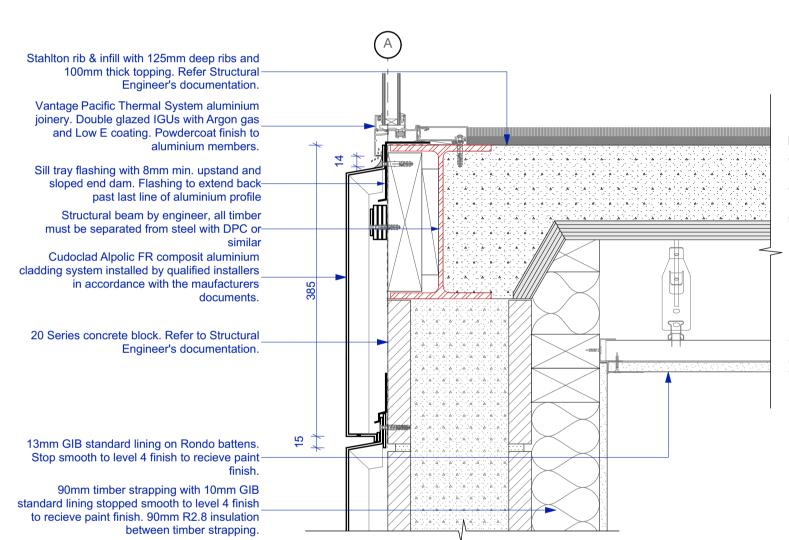
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28 Blockwall top sealant

415 Scale 1:5



Viking Roofspec 80mm clamped drain

as per manufacturers instructions

SDM049 with 304 S/S domed grate, installed

Viking Roofspec 80mm clamped overflow drain SDM049 with 304 S/S domed grate,

installed as per manufacturers instructions.

Overflow outlet to extend 10mm below soffit

Viking Torch-on Lybra SBS Waterproofing membrane installed in accordance with the

product manual. Over 17mm H3.2 CCA

treated plywood supported at 400crs.

Soffit flange to match downpipe

finishes schedule for colour.

80Ø Colorsteel DP with matching munzing ring standoff brackets at 1200mm crs. Refer to-

31 Roof drain and overflow

Viking Torch-on Lybra SBS Waterproofing membrane installed in accordance with the product manual. Over 17mm H3.2 CCA treated plywood supported at 400crs.

Metalcraft Colorsteel T-Rib roofing over

VB 20 ventilation batten fixed to top of

Extra 20mm required for fixings-

20mm min freeboard in addition to

air gap to underside of roofing

calculated gutter capacity in accordance-

R5 220mm ceiling insulation, ensure a 25mm

m

16mm GIB Fyreline ceiling lining installed in

batten or direct fixed to timber gutter framing.

requirements.

R3.6 165mm ceiling insulation for tight areas,

ensure a 25mm air gap to underside of roofing

403 Scale 1:5

accordance with GIB Fire Rated Systems

Manual GBUC 30. Over Rondo 308 metal

All fixings as per structural diaphragm

32 Colorsteel to membrane roof

Endura finish

timber purlins


with E2 Fig 52.

selected roofing underlay & wire mesh screw

fixed to top of purlins. Prefinished Colorsteel


410 / Scale 1:5

29 Composit Window Sill
403 Scale 1:5

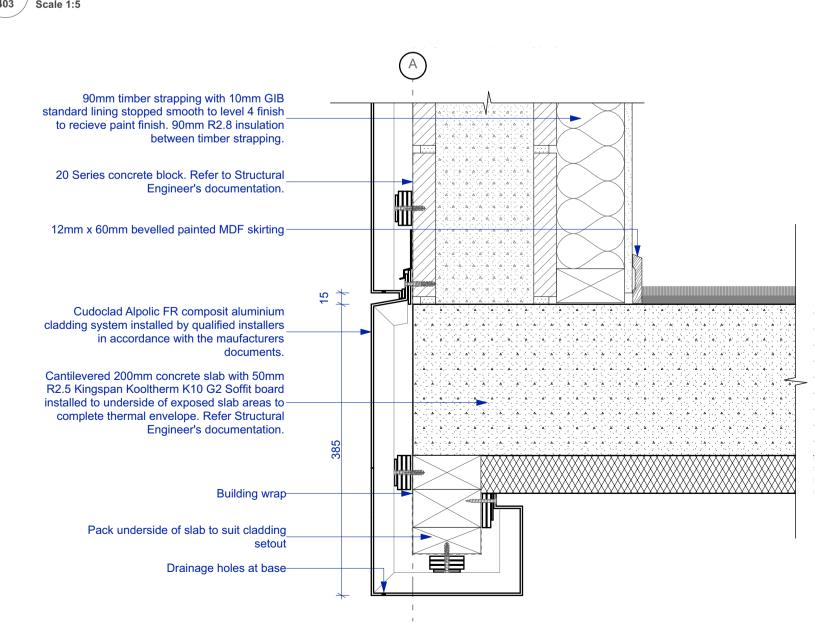


30 Exposed slab base

403 Scale 1:5

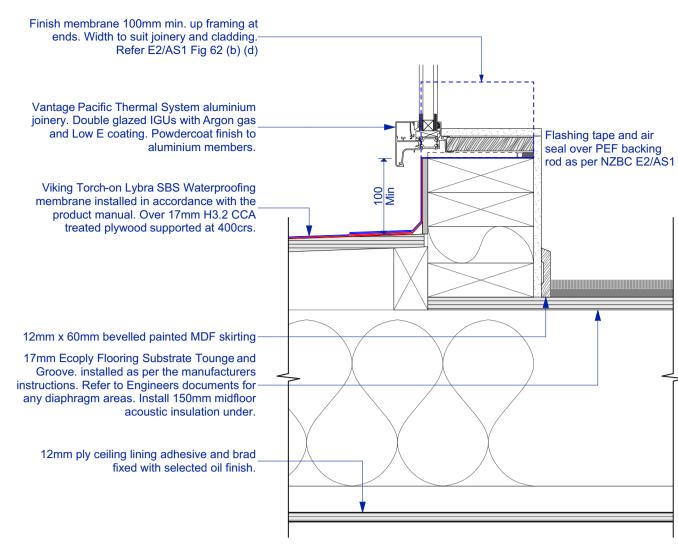


Window Sill to membrane roof Scale 1:5

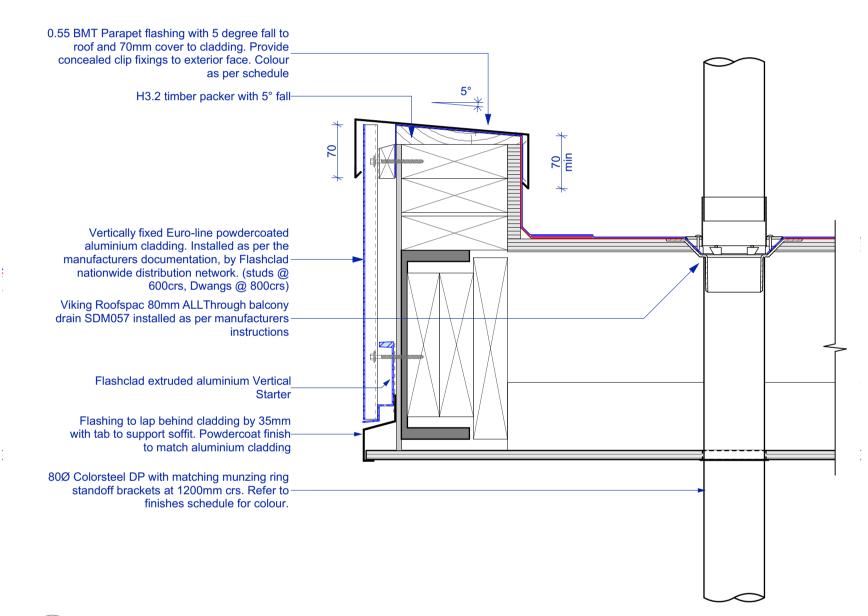

All through drain Scale 1:5

Flange width 230

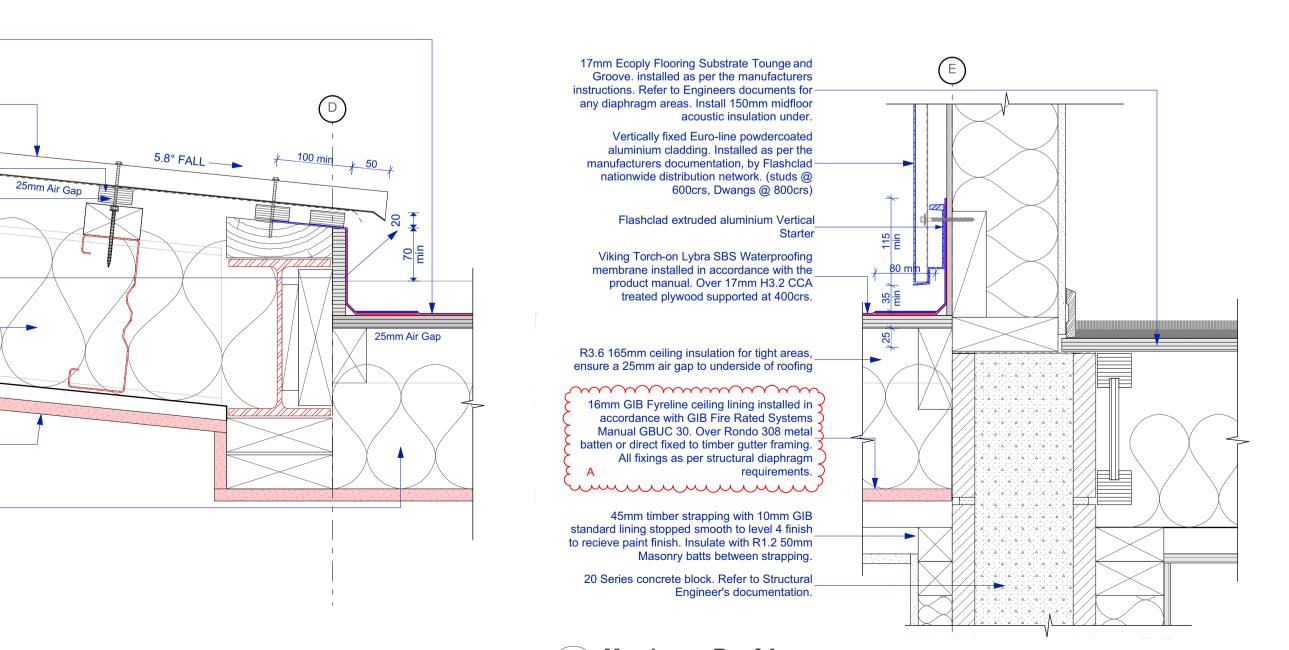

35 Membrane Roof Apron
403 Scale 1:5

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All work must comply with NZS 3604 2011 and the New Zealand Building Code.

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Chalmers Street
Apartments
20 Chalmers Street
Wanaka

Details


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Revision	Α
Date	9/06/2021
File No.	R19015
Scale @ A1	1:5

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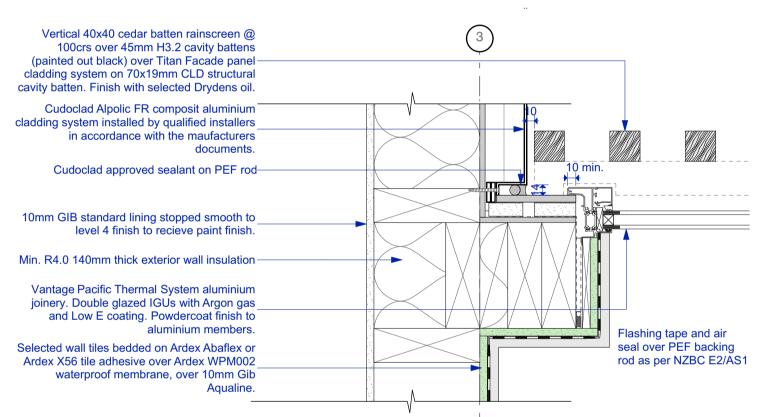
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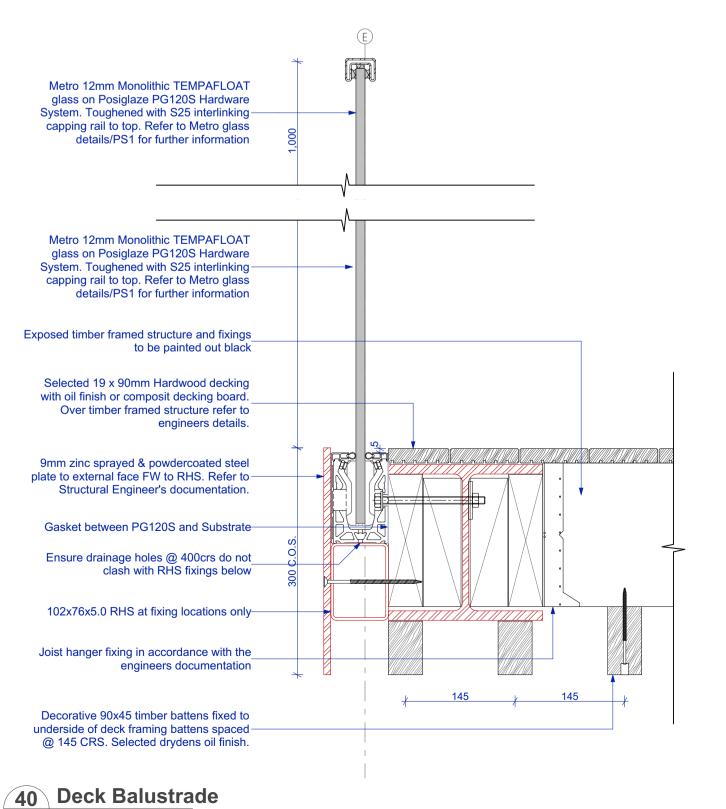
Building Consent Issue




38 Composit Aluminium Jamb External Corner 204 / Scale 1:5

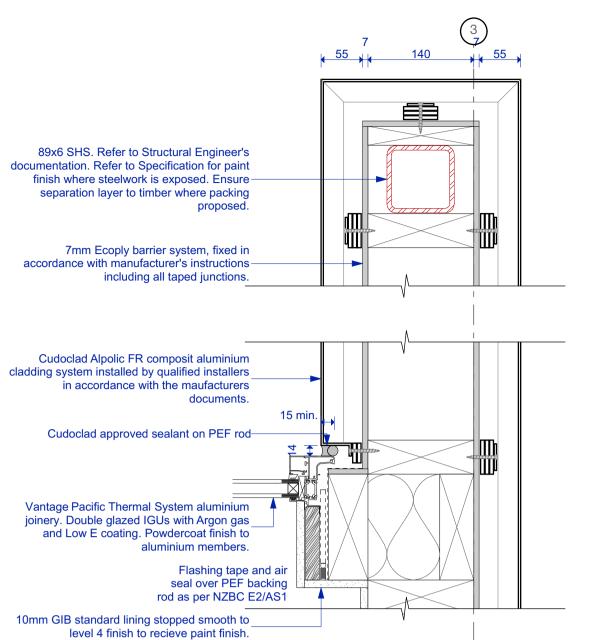


39 Composit Aluminium to Fibre Cement 204 / Scale 1:5




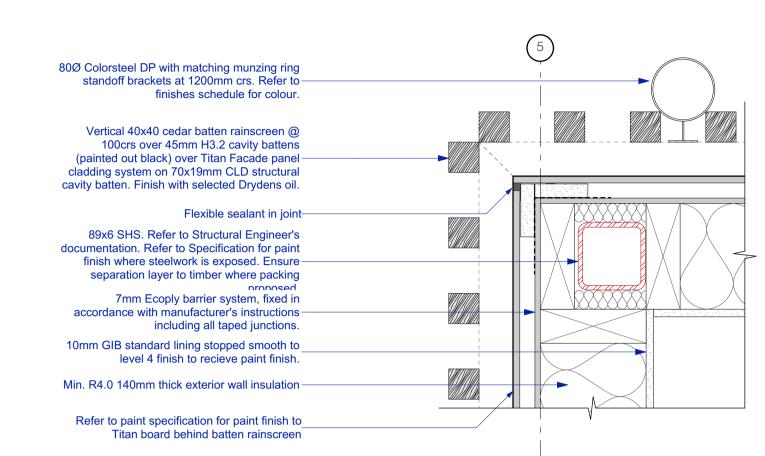

41 Vert Cedar Batten External Corner 204 / Scale 1:5

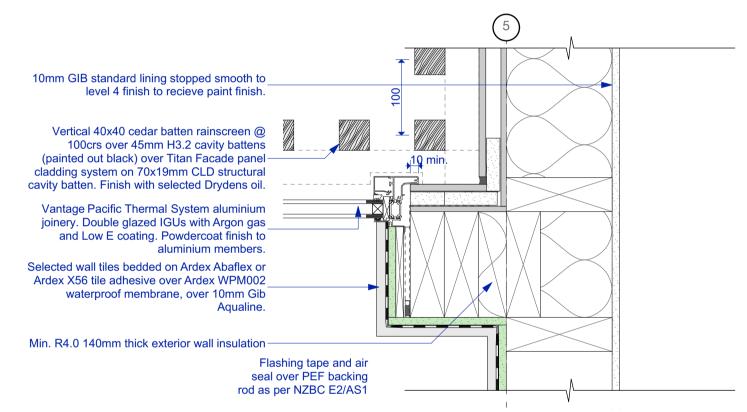

42 Vert Cedar Batten Internal Corner 204 / Scale 1:5

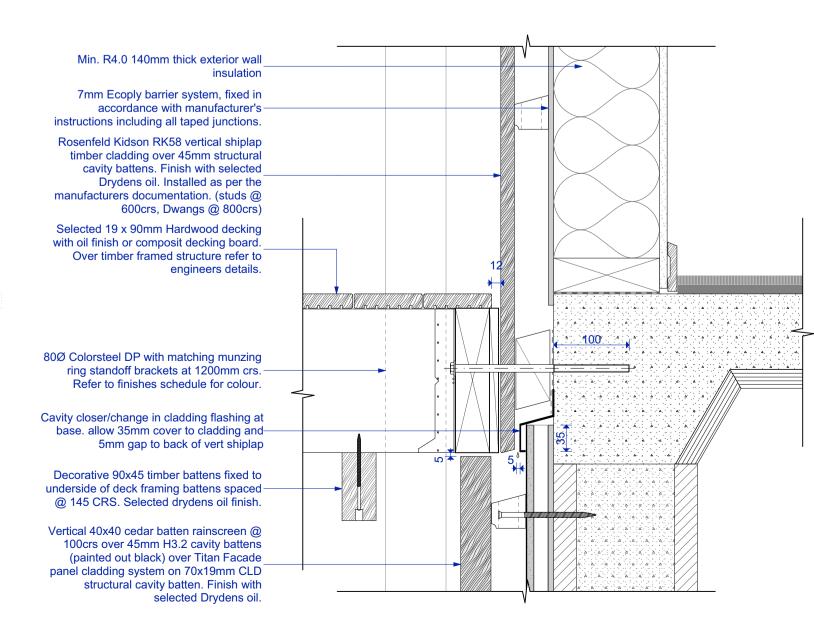

43 Deck to cladding 407 / Scale 1:5

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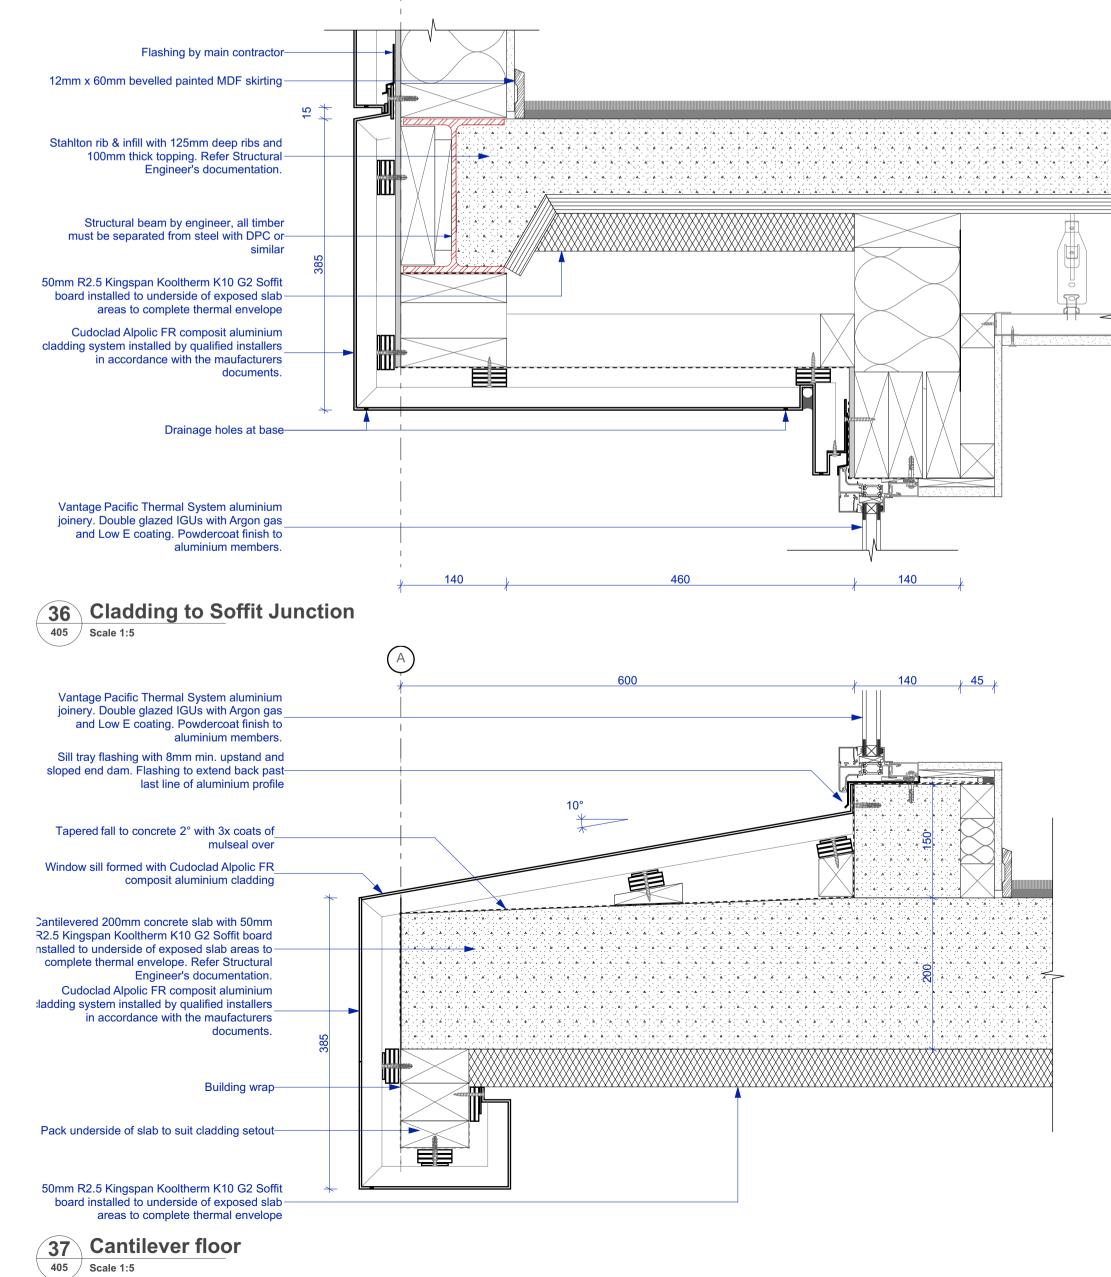
1:5 R19015 9/06/2021 505


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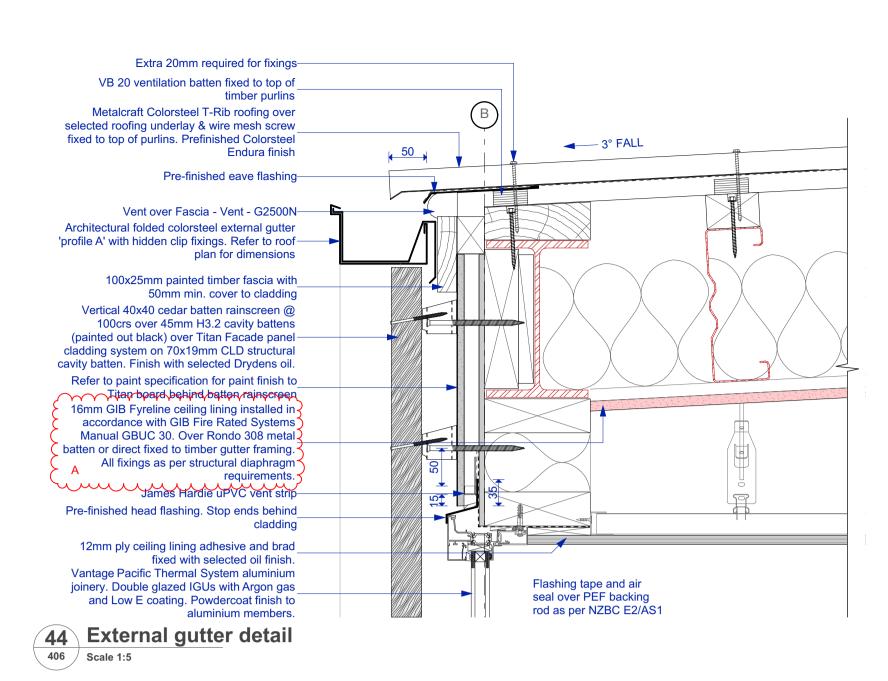
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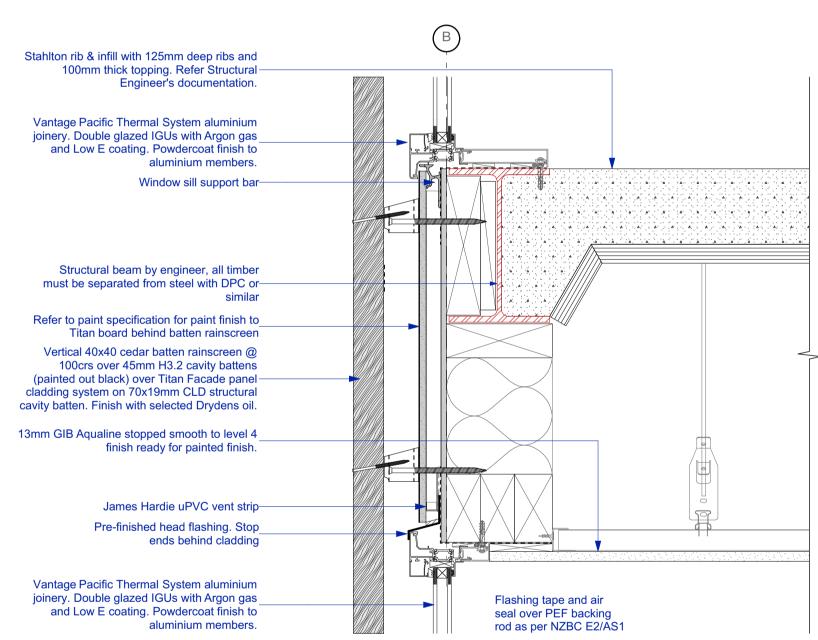
office@threesixtyarch.co.nz www.threesixtyarch.co.nz






407 Scale 1:5



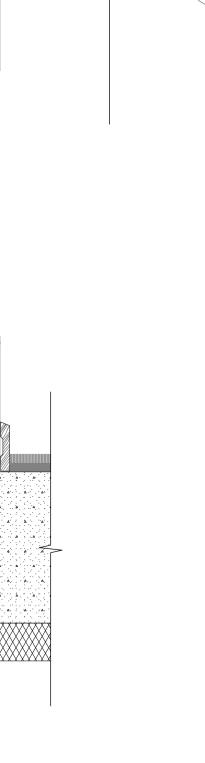


45 Window Sill cedar batten over


406 Scale 1:5

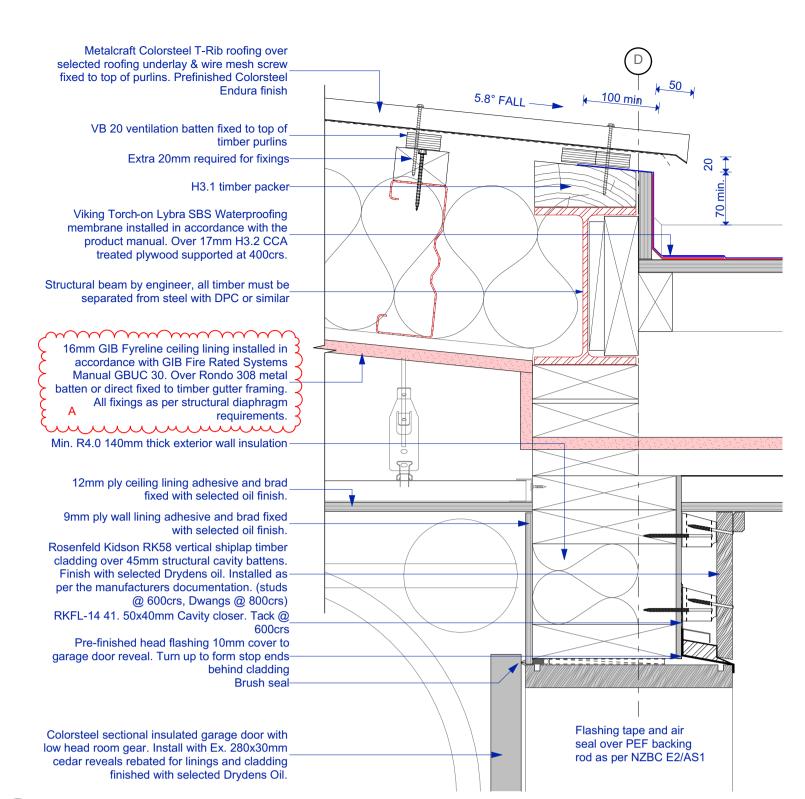



46 Garage Door Head 406 Scale 1:5

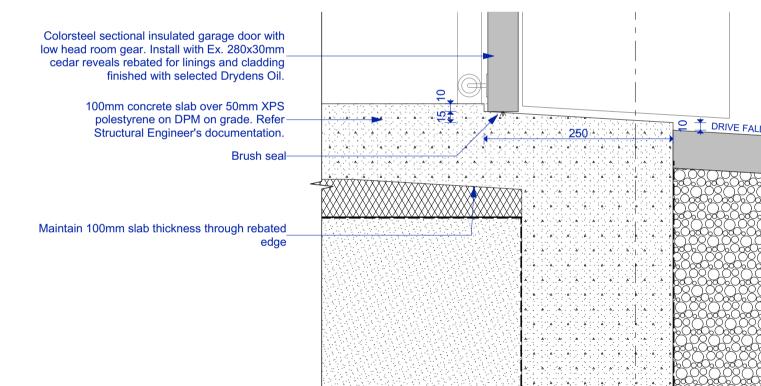

47 Garage Door Base 406 Scale 1:5

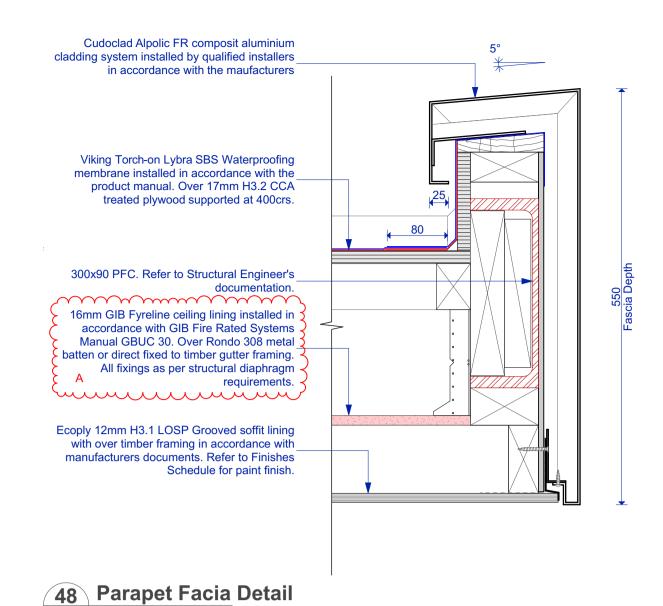

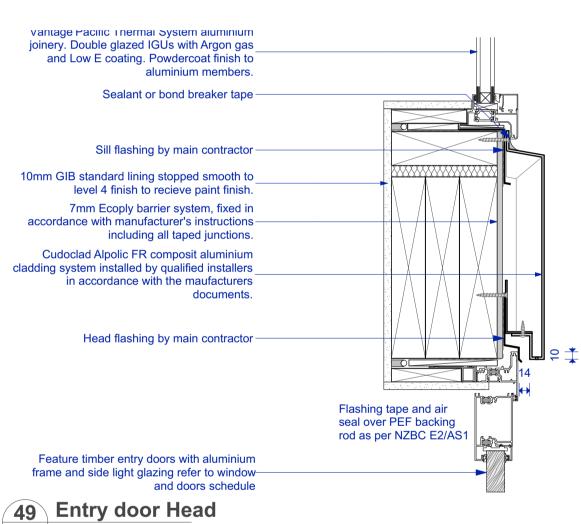

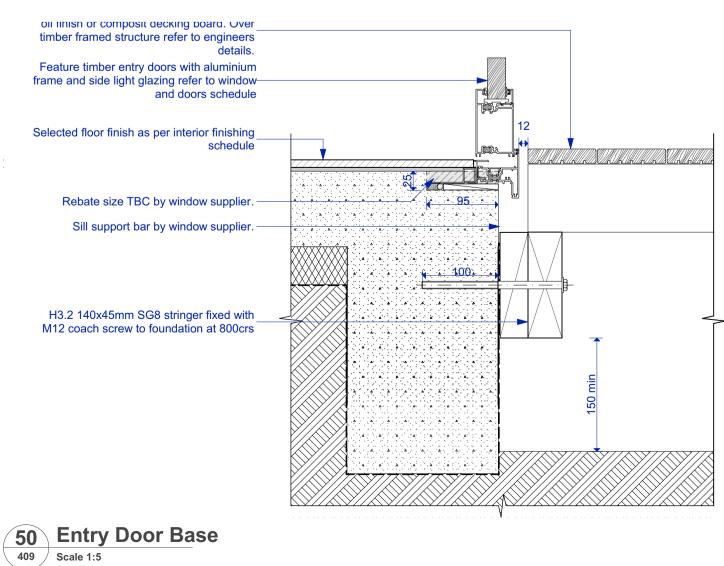

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All work must comply with NZS 3604 2011 and the New Zealand Building Code.

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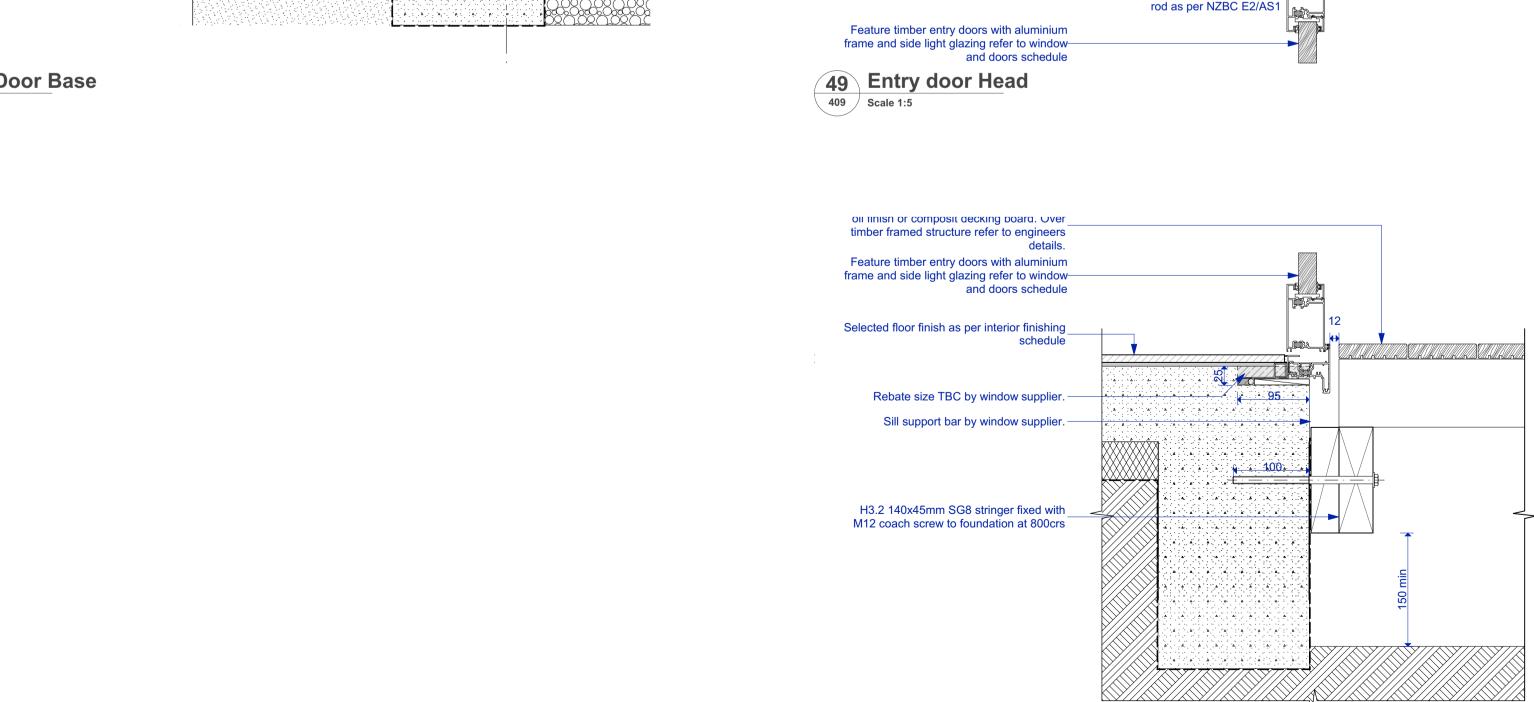
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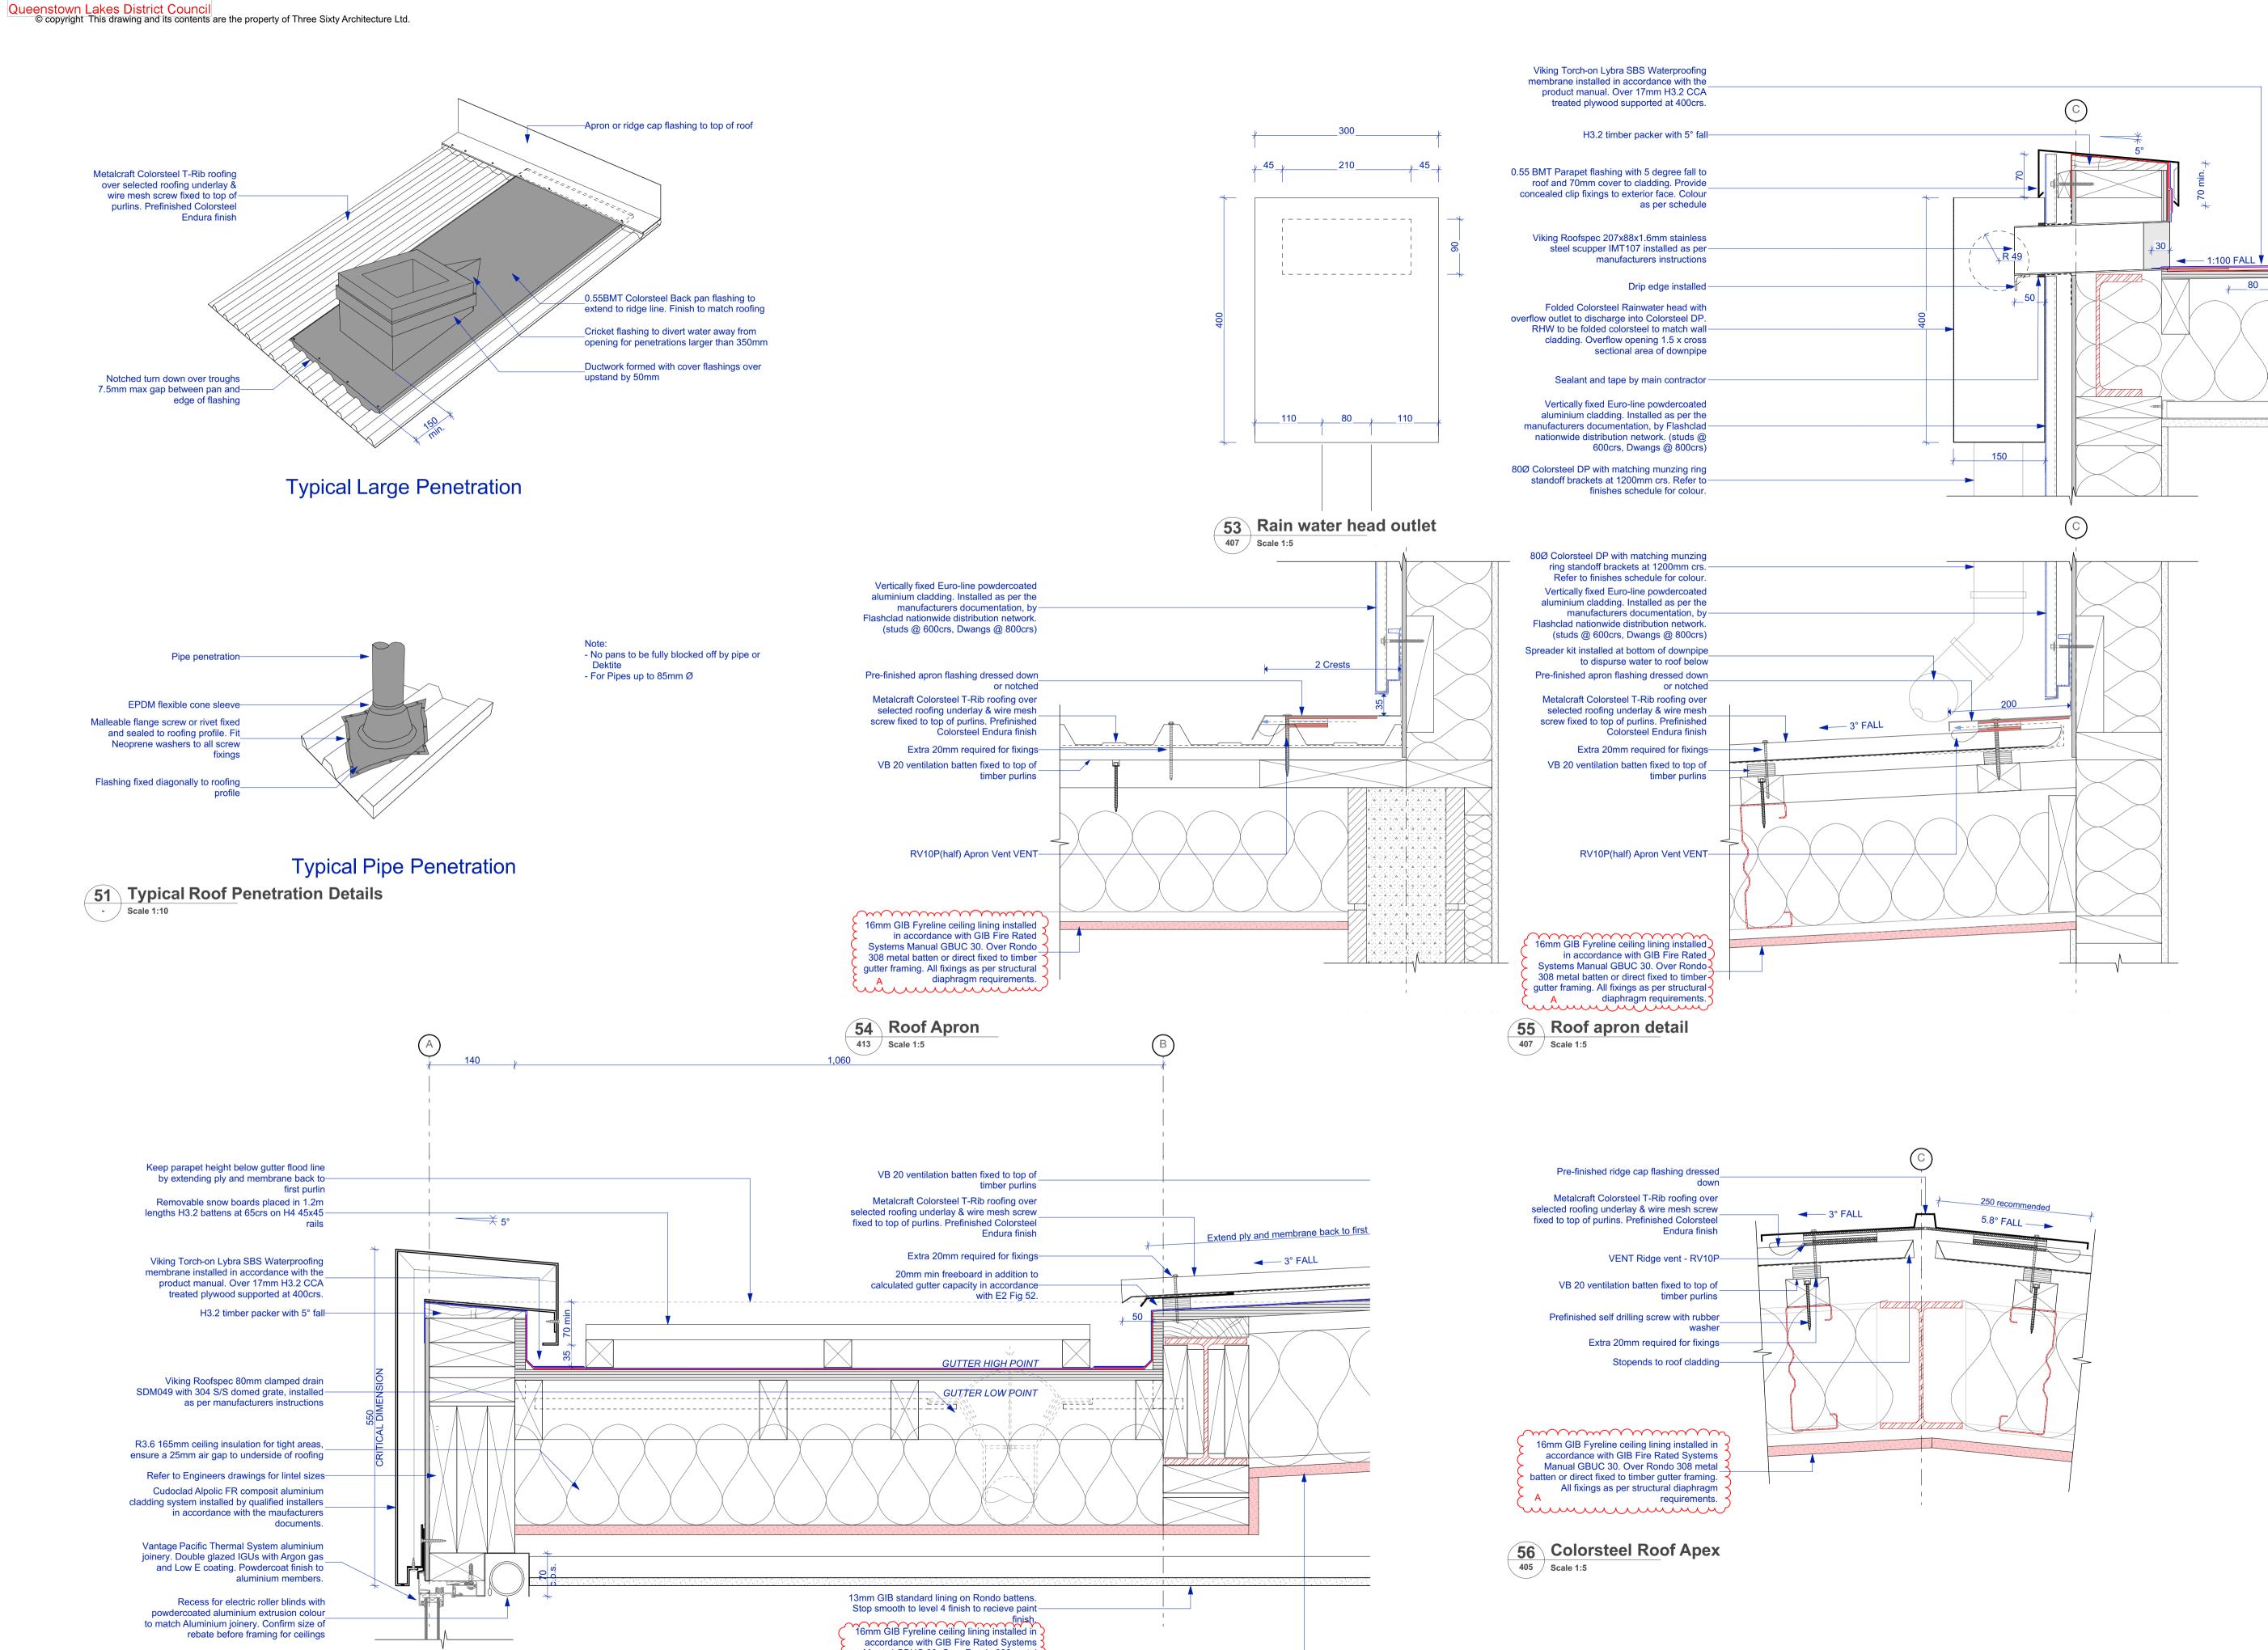
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1:5 Scale @ A1 File No. R19015 9/06/2021 Date Revision Sheet No **506**

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Manual GBUC 30. Over Rondo 308 metal

batten or direct fixed to timber gutter framing. All fixings as per structural diaphragm

Building Consent

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All work must comply with NZS 3604 2011 and the New Zealand Building Code.

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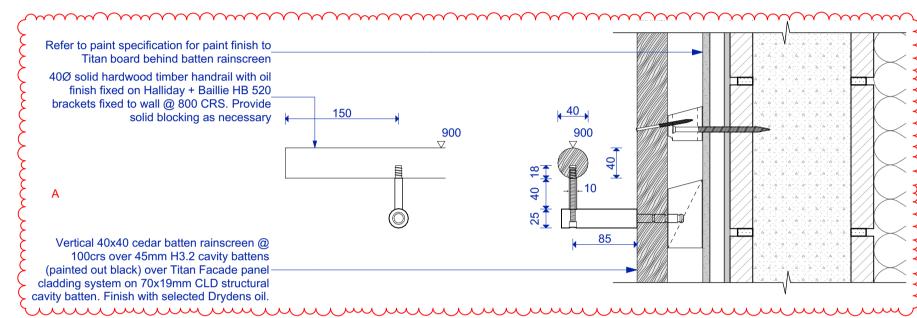
1:5, 1:10 Scale @ A1 File No. R19015 9/06/2021 Date Revision Sheet No 507

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t: 03 366 3349

58 Internal Stair Handrail 405 Scale 1:5



65 Exterior Stair Handrail

- Scale 1:5

_Stiffener wall bracket refer to

glass balustrade with stiffener bracket on

glass balustrade with stiffener bracket on

-Gasket between PG120S and Substrate

13mm GIB linings from ceiling to return up to

13mm GIB standard lining on Rondo battens.

Stop smooth to level 4 finish to recieve paint finish.

Metro glass details


—Selected floor finish

underside of channel




59 Timber fin top connection Posiglaze PG120S Hardware System. Refer to Metro glass details/PS1 for further information

413 / Scale 1:5

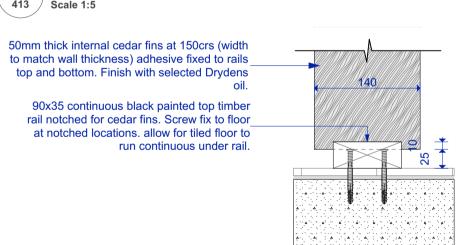

Timber fin base connection 413 Scale 1:5


57 Internal Glass Balustrade - Scale 1:5

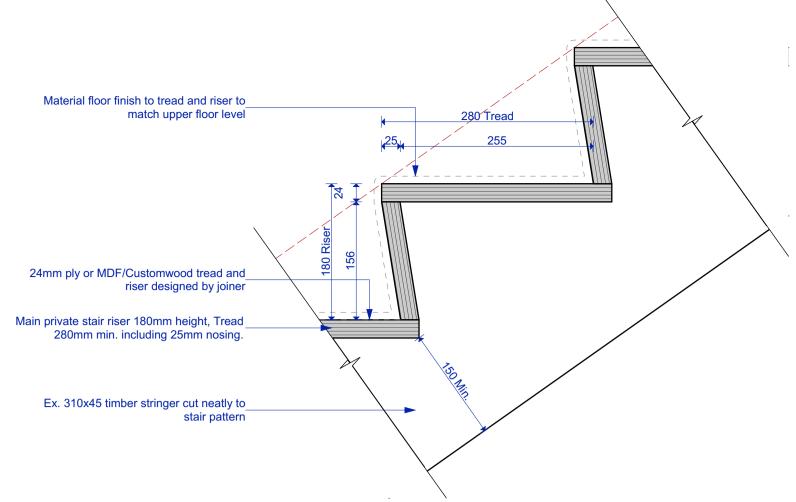

90


Stair Tread

407 / Scale 1:5

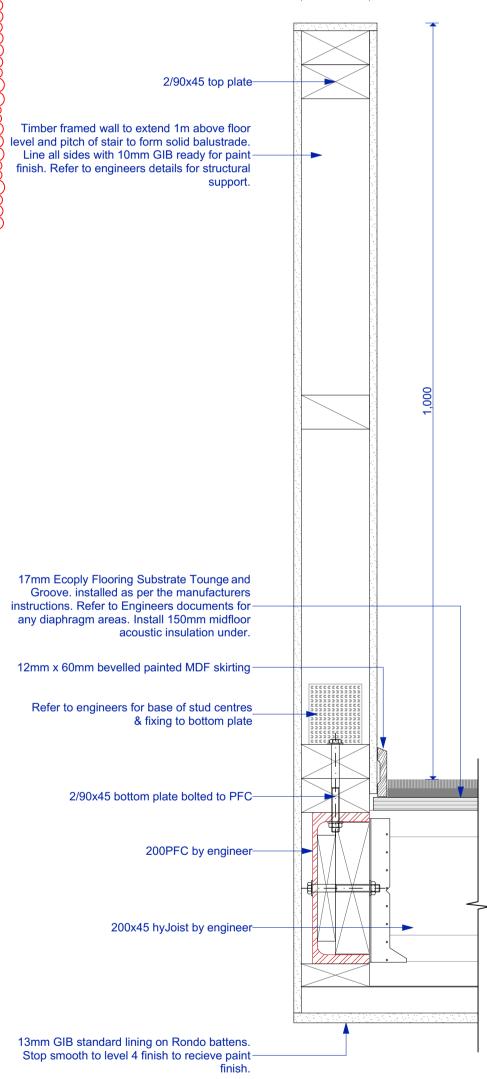

62 Timber balustrade

413 Scale 1:5

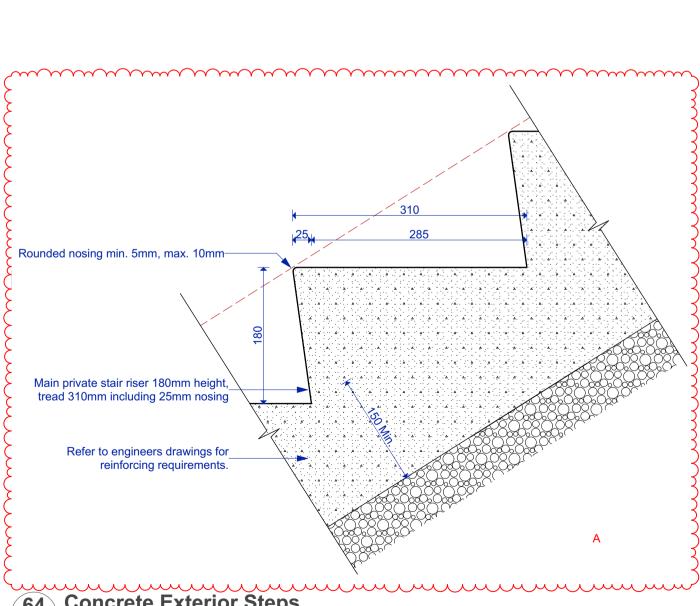

64 Concrete Exterior Steps

414 Scale 1:5

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All work must comply with NZS 3604 2011 and the New Zealand Building Code.

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Details


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File No.	R19015
Date	9/06/2021
Revision	Α

508


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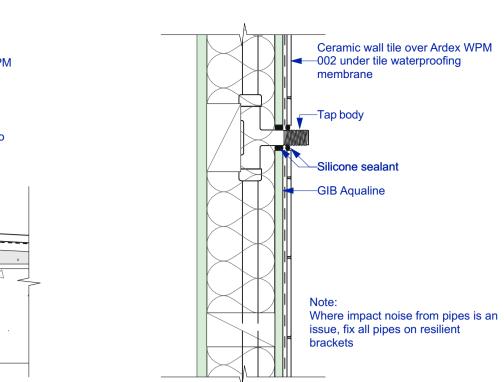


Shower tiled wall and floor

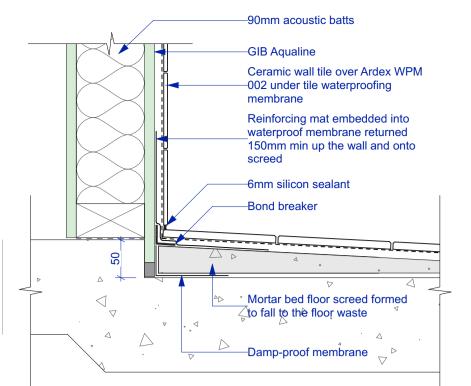



Plan - Shower tiled wall corner

63 Internal moisture details Scale 1:5

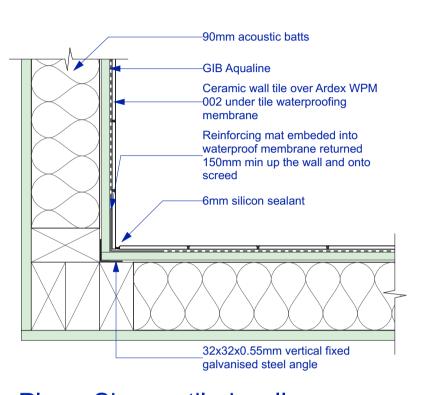

Mixer/tap penetration

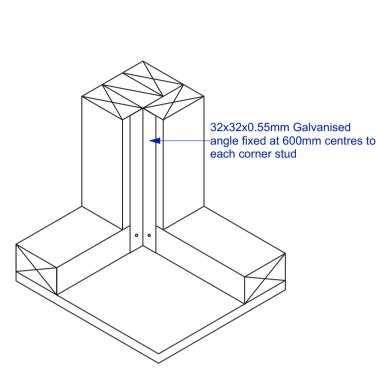

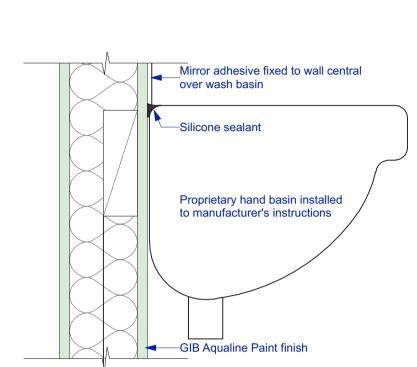

Ceramic wall tile over Ardex WPM

—002 under tile waterproofing

Fittings bedded on silicone


membrane

Rail fitting

—GIB Aqualine

Grab rail fixing


Basin/Mirror junction

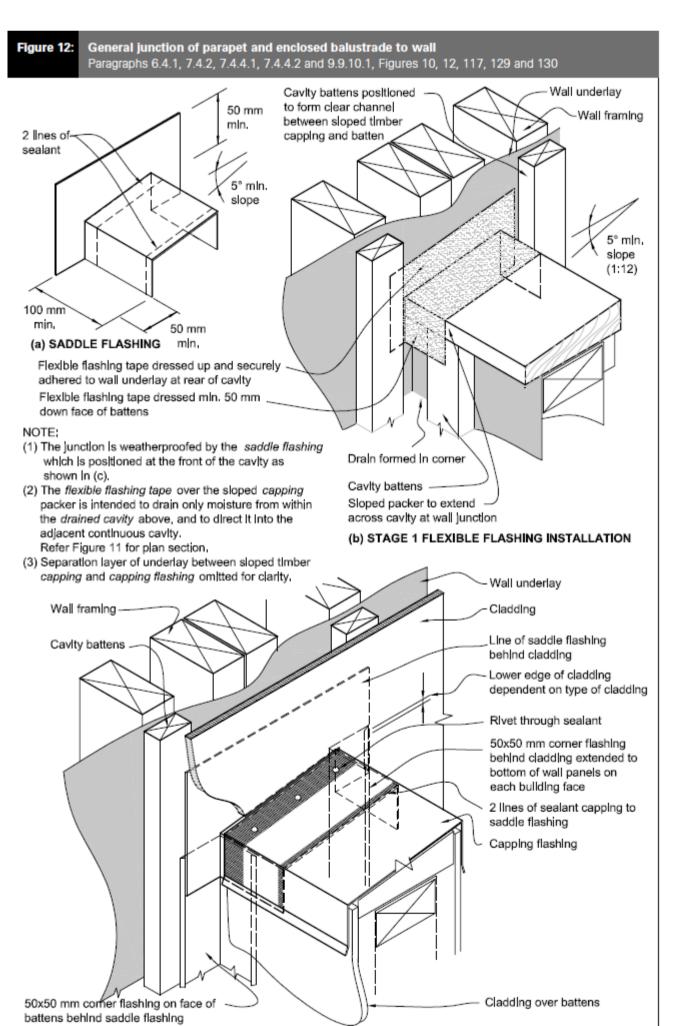


(c) STAGE 2 SADDLE FLASHING INSTALLATION

E2 Figure 12

Scale NTS

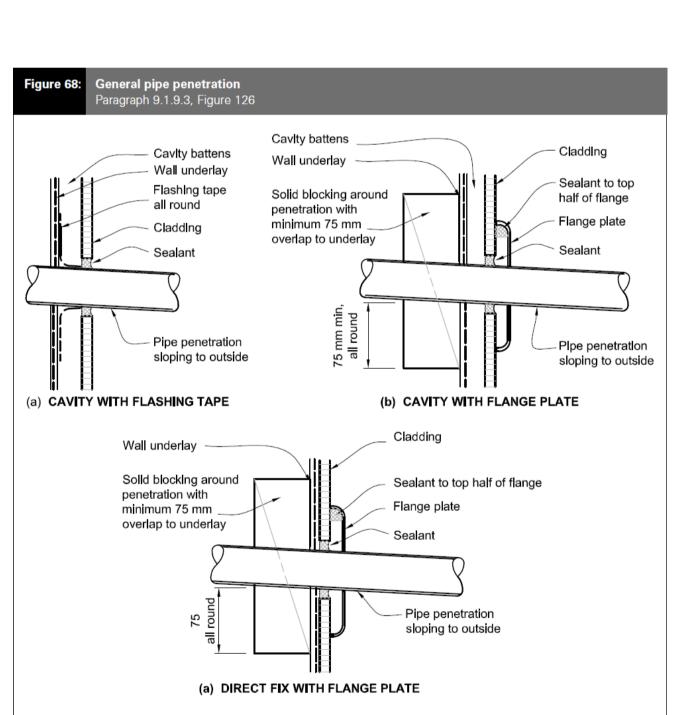


Pipe Penetration Scale NTS

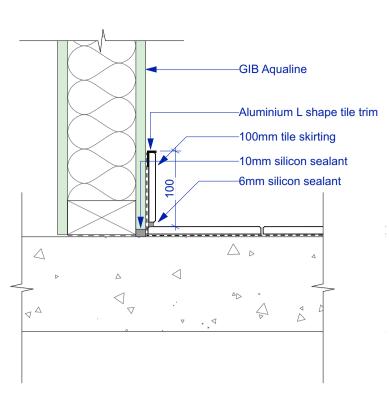

Tile skirting

66 Retaining Wall Waterproofing

403 Scale 1:10

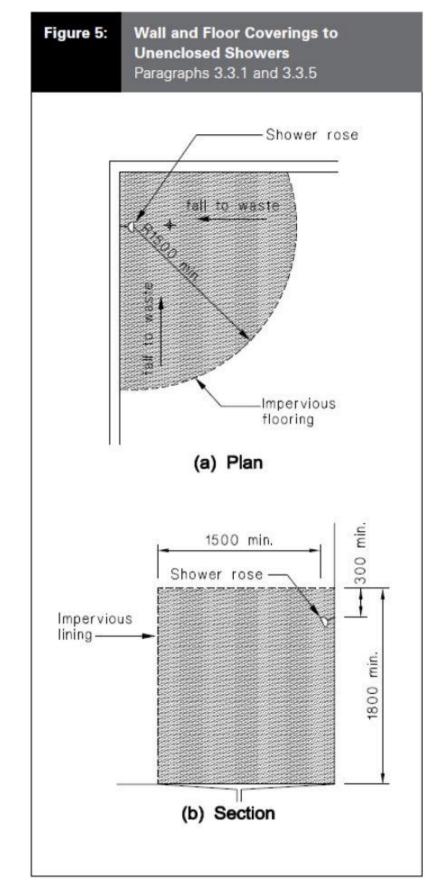

E3 Shower

Scale NTS

Stormwater and wastewater pipes to be installed outside of filter cloth and backfill 70mm XPS insulation to external face protecting tanking membrane Existing ground line BIDIM filter cloth shown dashed 20 series block wall. Refer to Structural Engineer'a documentation. Viking Mercury FC Torch-on tanking membrane installed onto block retaining wall structure with primer to block wall as per manufacturers documentation AP40 free draining back fill to be approved by structural engineer 100Ø perforated pipe field drain -- Pipe to lay on concrete to achieve falls - Pipe to be wrapping in filter cloth Viking Mercury FC Torch-on under-flashing with min. 100mm lap to Torch-on wall tanking. 100mm concrete slab over 50mm XPS polestyrene on DPM on grade. Refer

Structural Engineer's documentation.

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All work must comply with NZS 3604 2011 and the New Zealand Building Code.

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Chalmers Street Apartments 20 Chalmers Street Wanaka

Details

1:5, 1:10 Scale @ A1 File No. R19015 9/06/2021 509

Thee Sixty Architects Limited Level 1, The Yard 173 St Asaph Street Christchurch 8140

t: 03 366 3349

∤ 810 ∤

/ 760 /

D1.02

Cupboard

∤ 860 _∤

<u>∤</u> 810 _∤

D2.01

Door leaf Solid core - paint quality

60x18mm with paint

Lever handle and latch

Frame/Rev Architraves - Bevel

Type Interior - Hinged door

Wall Base

Door leaf Solid core - paint quality finish

60x18mm with paint

Lever handle and latch

Privacy lock set

Interior - Hinged door

Frame/Rev Architraves - Bevel

Hardware Door stop

<u>∤</u> 860 _∤

¥ 810


D3.01


Door leaf Solid core - paint quality finish


60x18mm with paint

Frame/Rev Architraves - Bevel

Hardware Door stop

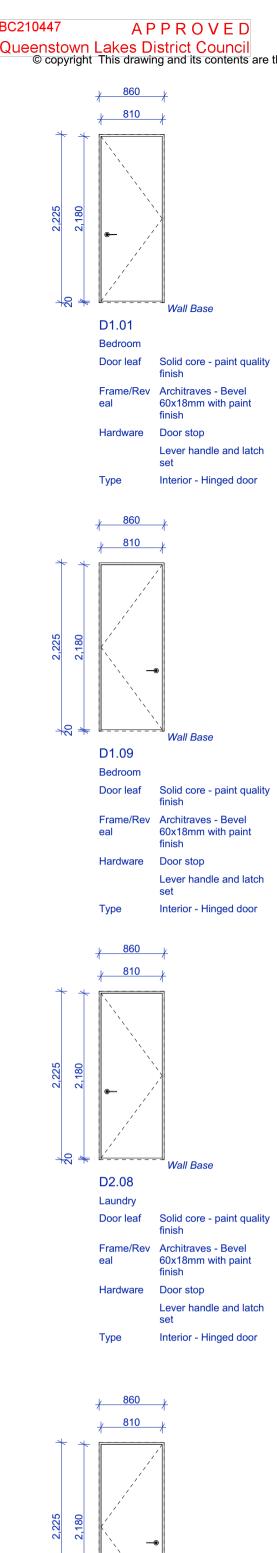

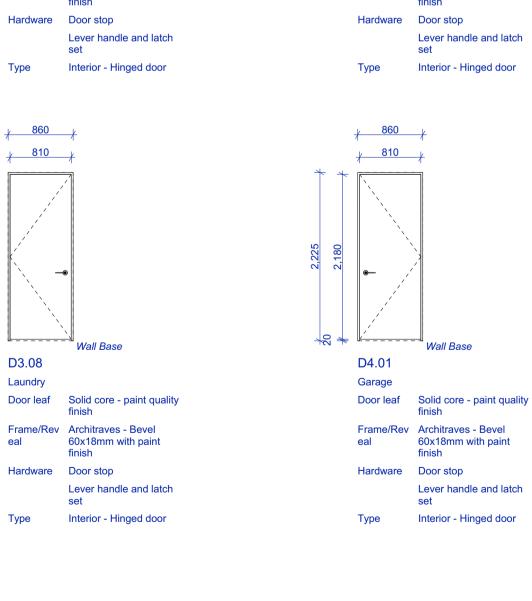

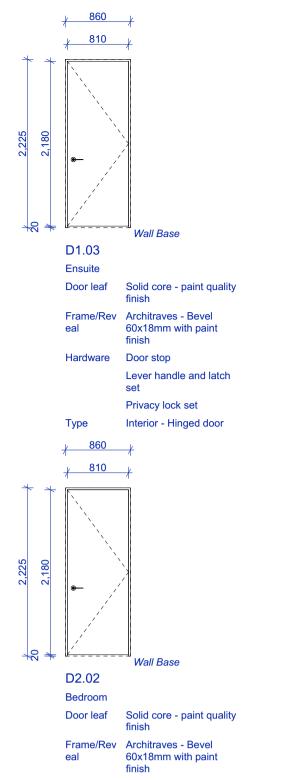

Wall Base

Door leaf Solid core - paint quality finish

60x18mm with paint finish

Privacy lock set

Interior - Hinged door


Lever handle and latch

Frame/Rev Architraves - Bevel

Hardware Door stop

D4.02

Bathroom

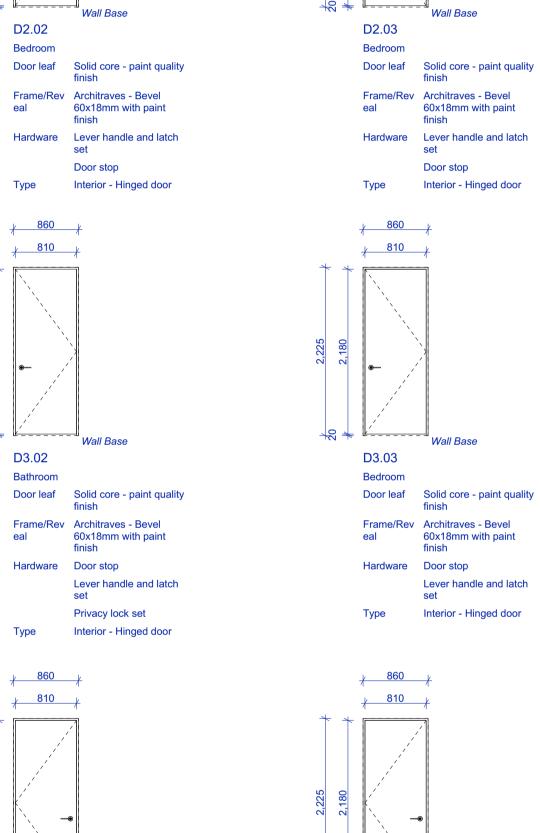

¥ 860 ¥

<u>∤</u> 810 _∤

D1.04

Laundry

Door leaf Solid core - paint quality

60x18mm with paint

Lever handle and latch

Frame/Rev Architraves - Bevel

Type Interior - Hinged door

Wall Base

60x18mm with paint finish

Frame/Rev Architraves - Bevel

Hardware Door stop


D4.03

Bedroom

Hardware Door stop

∤ 860 _∤

<u>∤ 810</u>

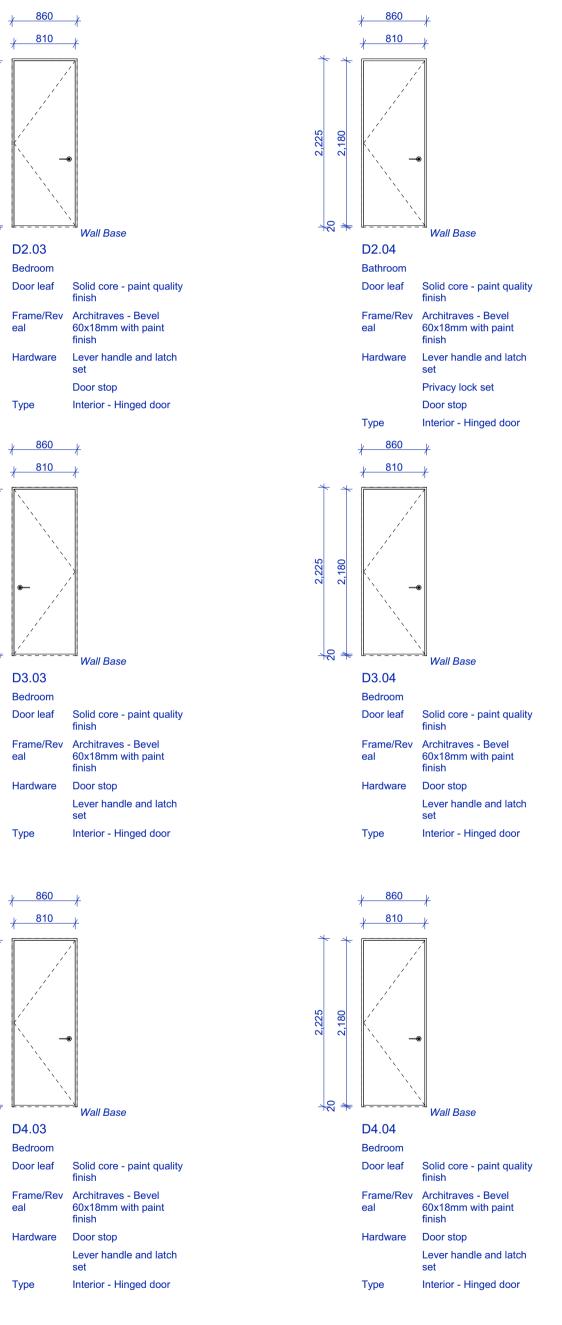

<u>∤ 860</u>


<u>∤</u> 810 _∤


D1.05

Guest WC

Hardware Door stop


Privacy lock set

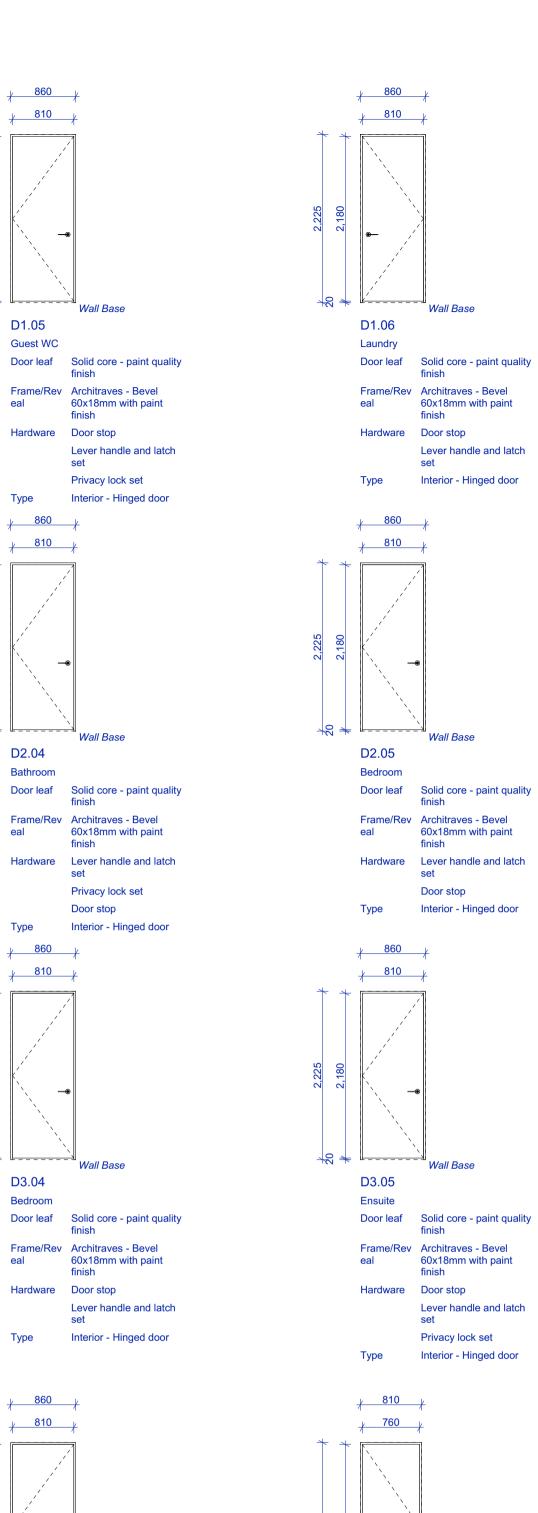

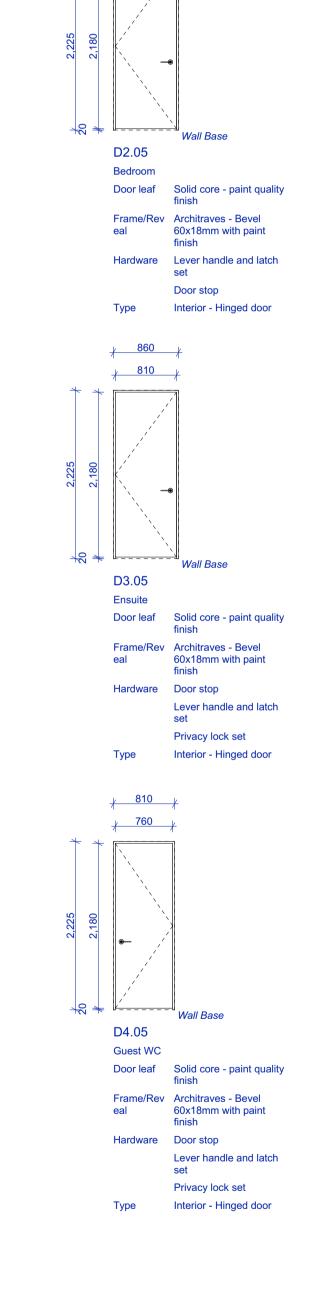

60x18mm with paint

Lever handle and latch

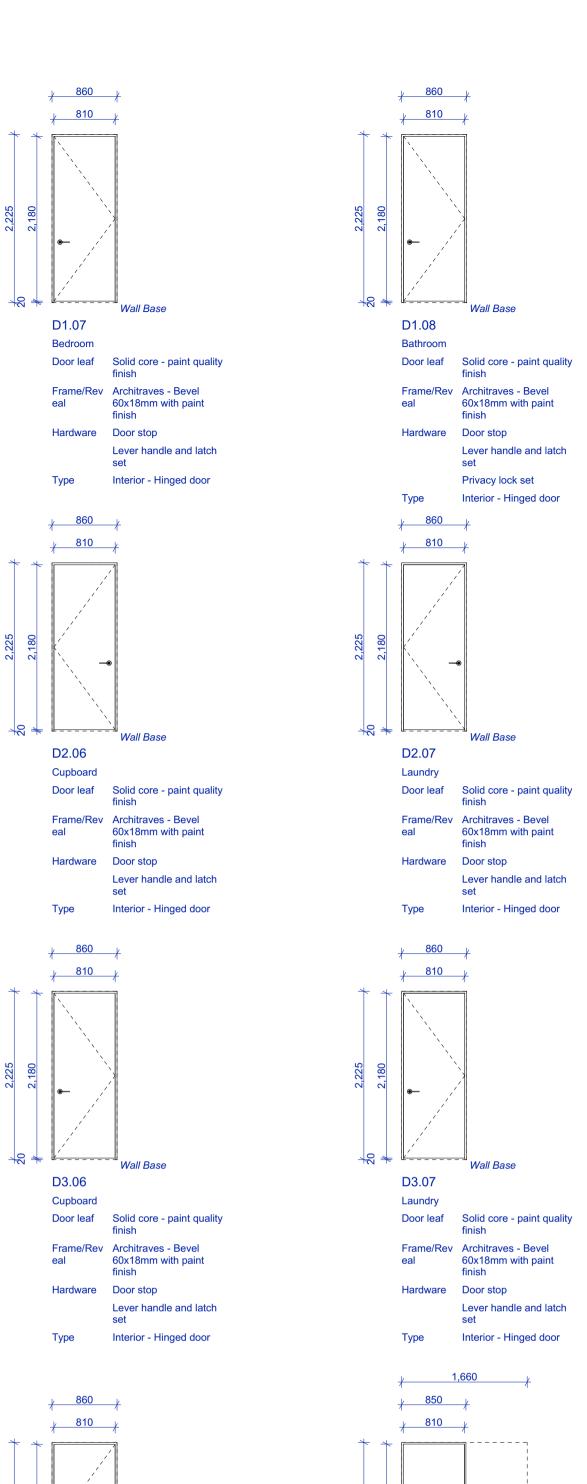

__`_

D4.07

Ensuite

Wall Base

Door leaf Solid core - paint quality finish

60x18mm with paint finish

Lever handle and latch

Frame/Rev Architraves - Bevel

Type Interior - Hinged door

Hardware Door stop

D4.06

Bedroom

Wall Base

Door leaf Solid core - paint quality finish

60x18mm with paint finish

Recessed pull handle

Interior - Cavity slider

Frame/Rev Architraves - Bevel

Hardware Privacy lock set



Building Consent

All dimensions shall be verified on site by the contractor before starting any work or ordering any materials.
All work must comply with NZS 3604 2011 and the New Zealand Building Code.

Issue: Building Consent Issue



Chalmers Street Apartments 20 Chalmers Street Wanaka

Sheet No.

Window & Door Schedule


Scale @ A1	
File No.	R19015
Date	9/06/2021
Revision	-

601

Thee Sixty Architects Limited Level 1, The Yard 173 St Asaph Street Christchurch 8140

t: 03 366 3349

Queenstown Lakes District Council
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Door leaf Entry feature timber

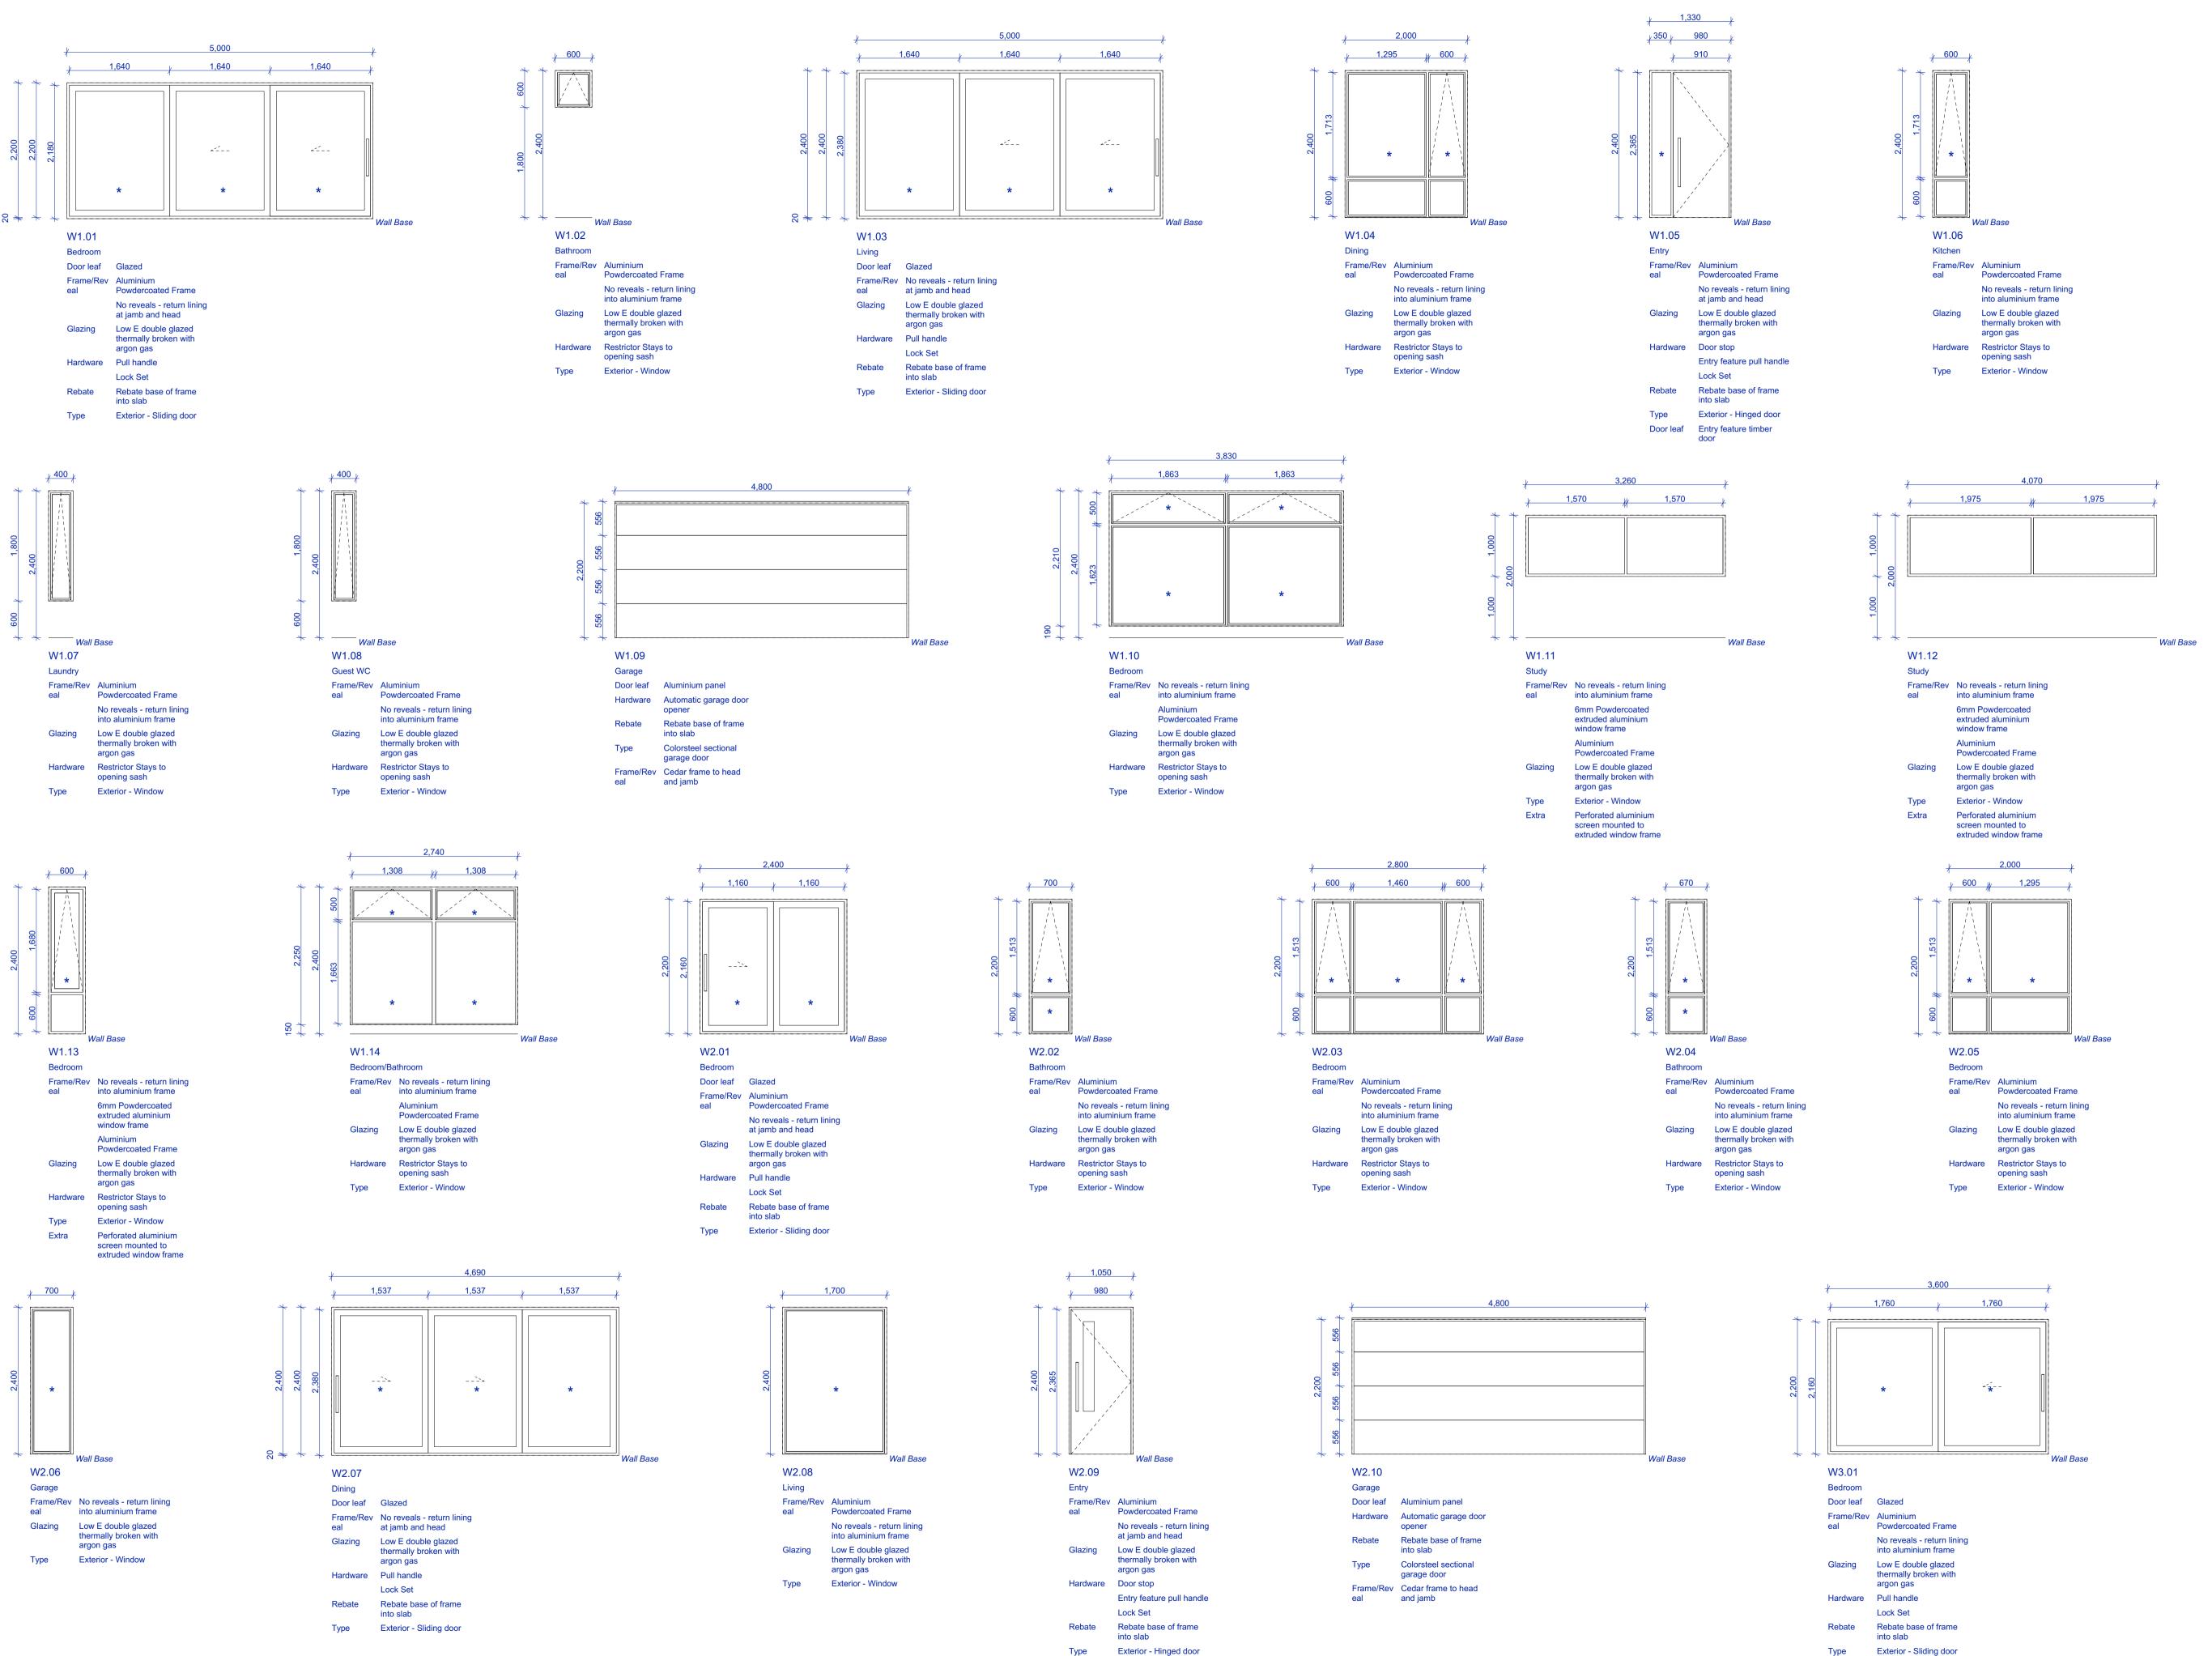Building Consent

Notes:

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All work must comply with NZS 3604 2011 and the New Zealand Building Code.

 Rev:
 Date:
 Issue:

 16/04/2021
 Building Consent Issue

Three Sixty Architecture



Chalmers Street
Apartments
20 Chalmers Street
Wanaka

Window & Door Schedule

 Scale @ A1

 File No.
 R19015

 Date
 9/06/2021


 Revision


Thee Sixty Architects Limited Level 1, The Yard 173 St Asaph Street


602


Christchurch 8140

t: 03 366 3349

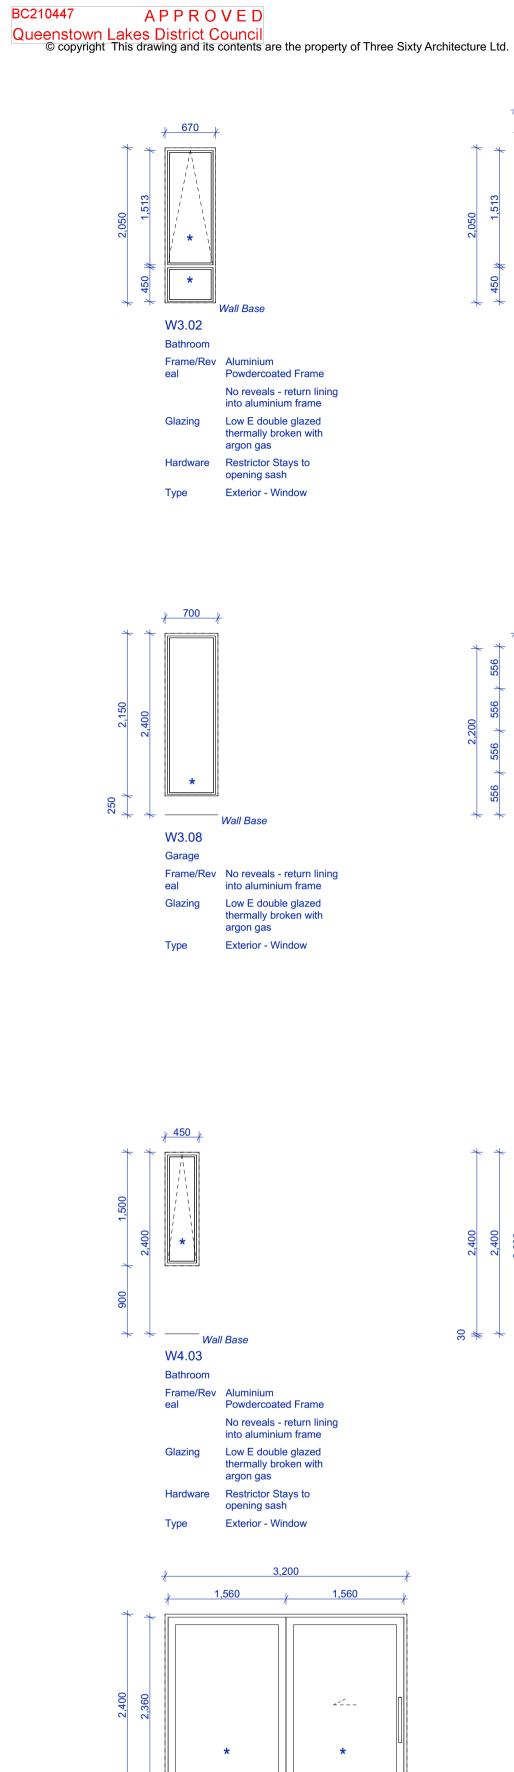

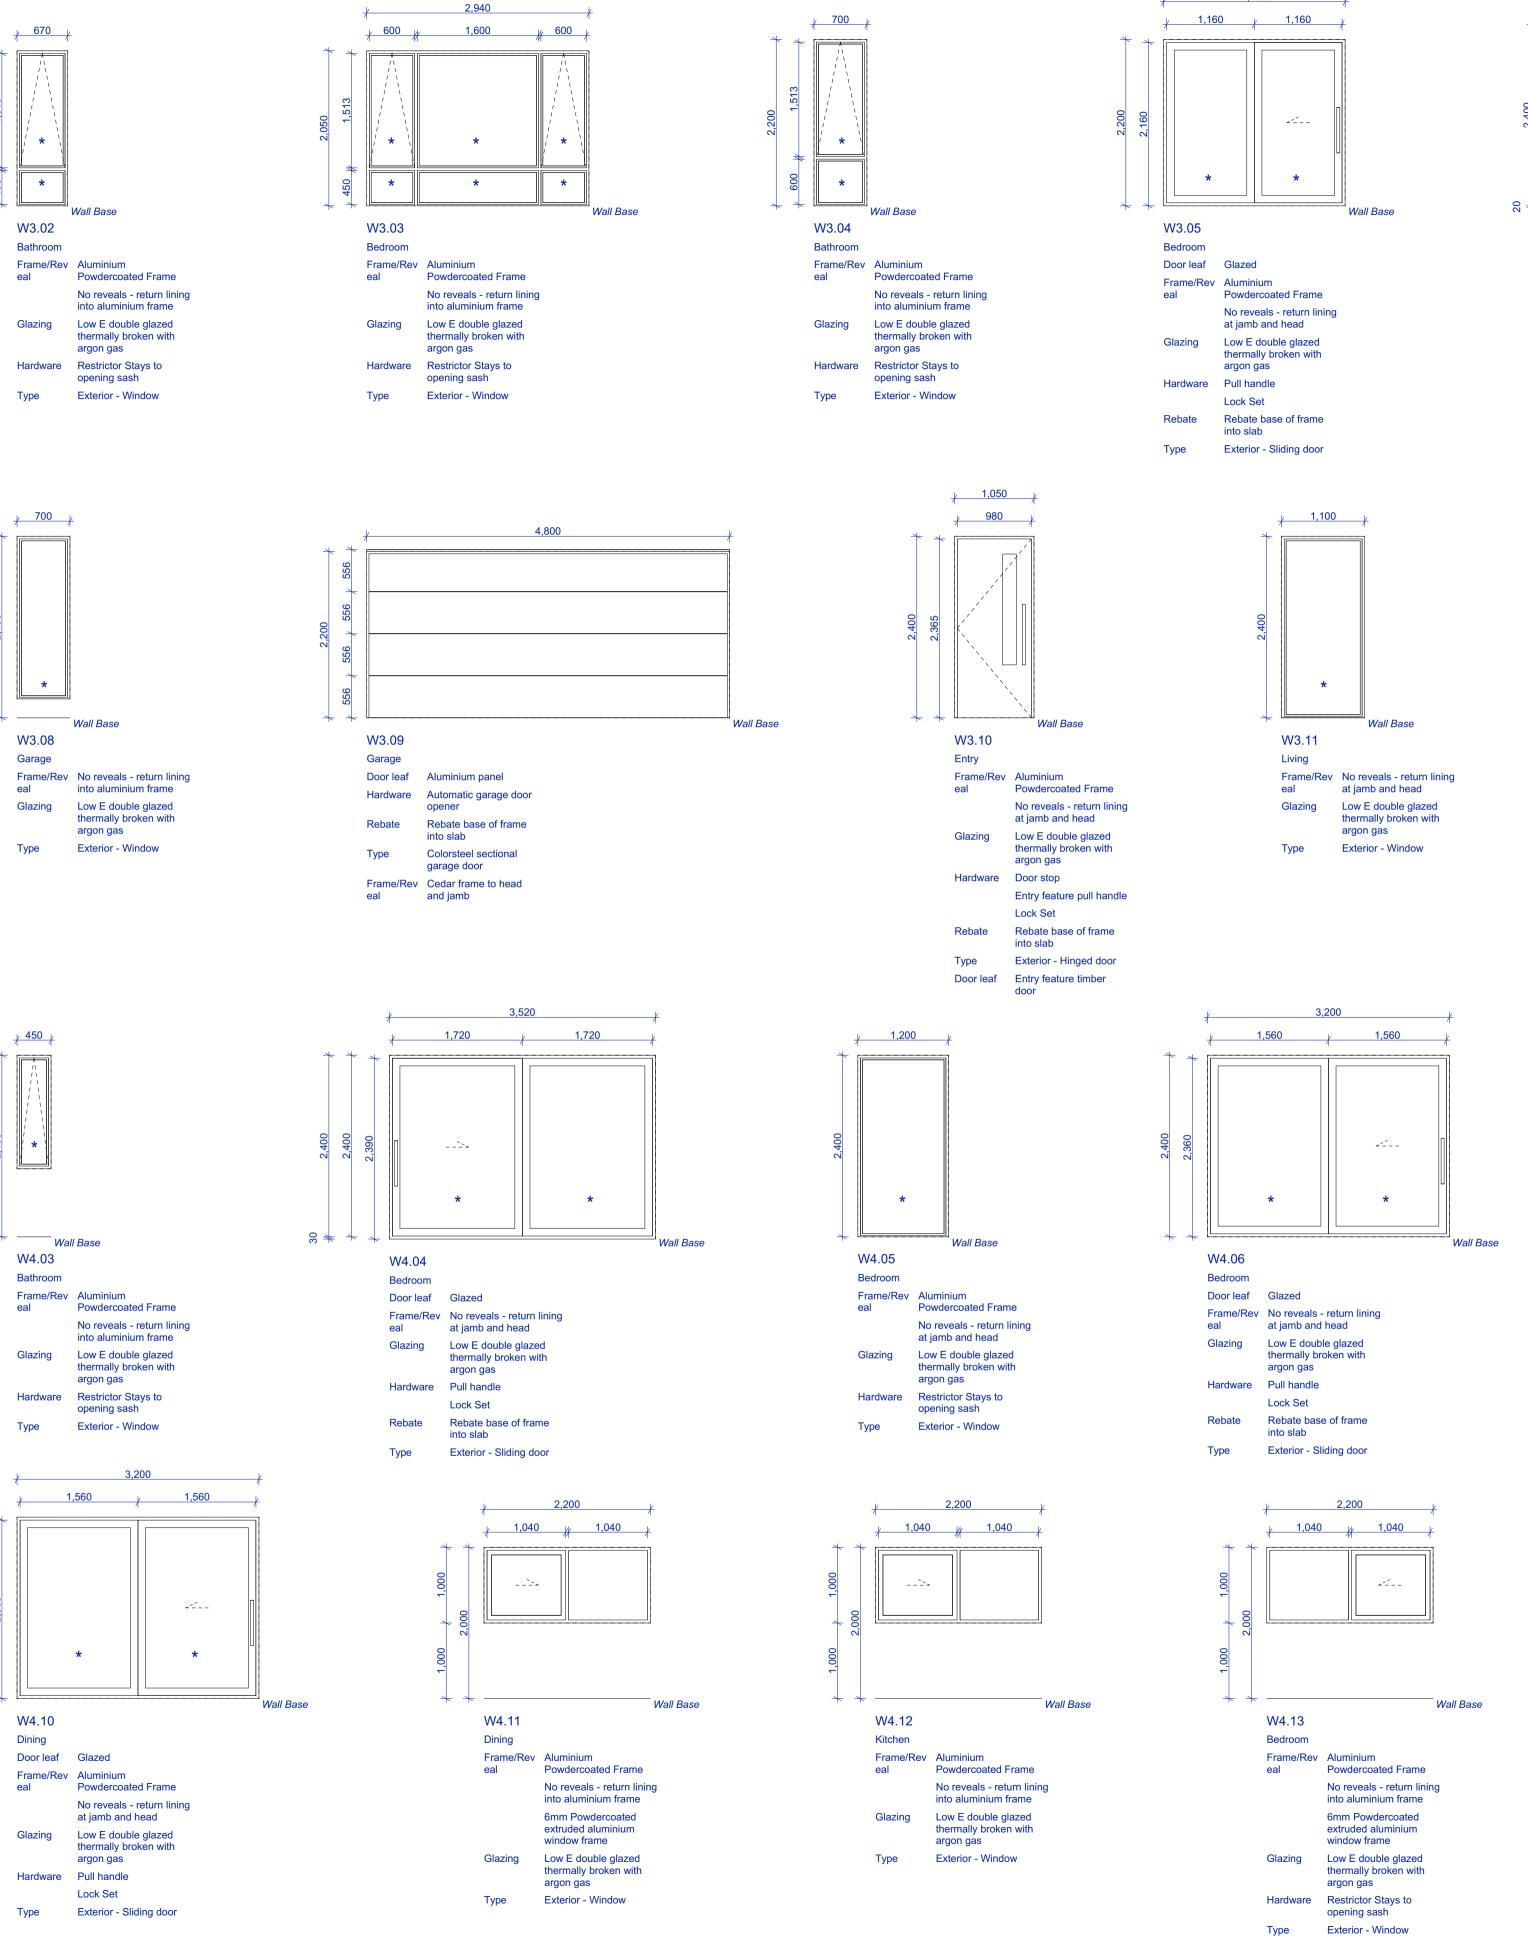

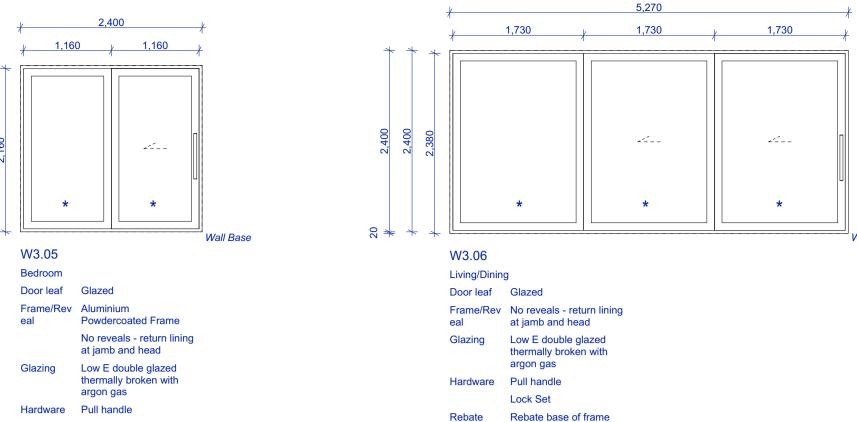

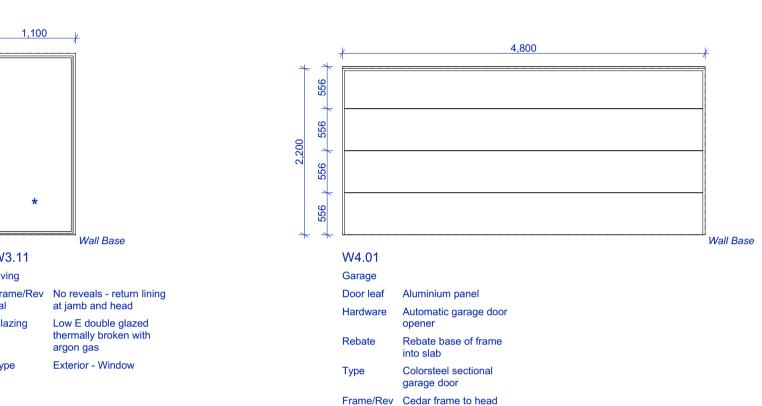

and jamb

∤ 600 ∤

W4.14

Ensuite

Extra

Wall Base

Powdercoated Frame

into aluminium frame

6mm Powdercoated

extruded aluminium

Low E double glazed

thermally broken with

window frame

argon gas

opening sash

Exterior - Window

screen mounted to extruded window frame

Perforated aluminium


Hardware Restrictor Stays to

No reveals - return lining

Frame/Rev Aluminium

into slab

Exterior - Sliding door

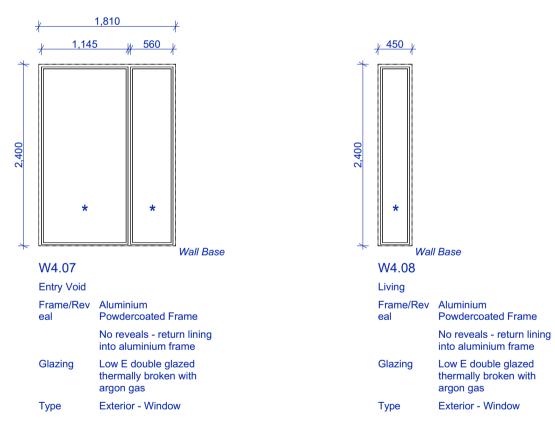

GENERAL NOTES:

back of the aluminium frame

blinds for size/details.

- This schedule is to be read in conjunction with the Architectural Specification

- All aluminium joinery to have interior linings returned into the jamb and head to the

- All interior doors to be installed with architraves - Bevel 60x18mm with paint finish

- Allow to form recess in ceiling for electric blackout roller blinds for all North facing


windows, all exterior sliding doors and bedroom windows. Contact Otago shutter &

- All exterior doors to be fitted with lockset and keyed alike to each unit.

- All opening windows to be installed with opening restrictor stays

denotes Grade A Safety glazing to table 3.1 NZS 4223: Part 3

- Aluminium joinery shown as viewed from the exterior

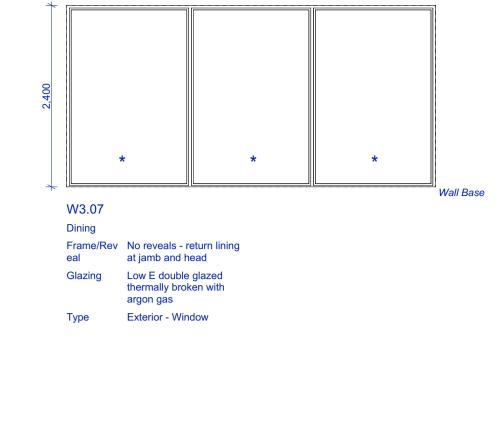

4,880





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before starting any work or ordering any materials.
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Issue: Building Consent Issue

Chalmers Street Apartments 20 Chalmers Street Wanaka

Window & Door Schedule


Sheet No.	000	
Revision	-	
Date	9/06/2021	
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Scale @ A1		

603

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office@threesixtyarch.co.nz www.threesixtyarch.co.nz



Hardware Pull handle

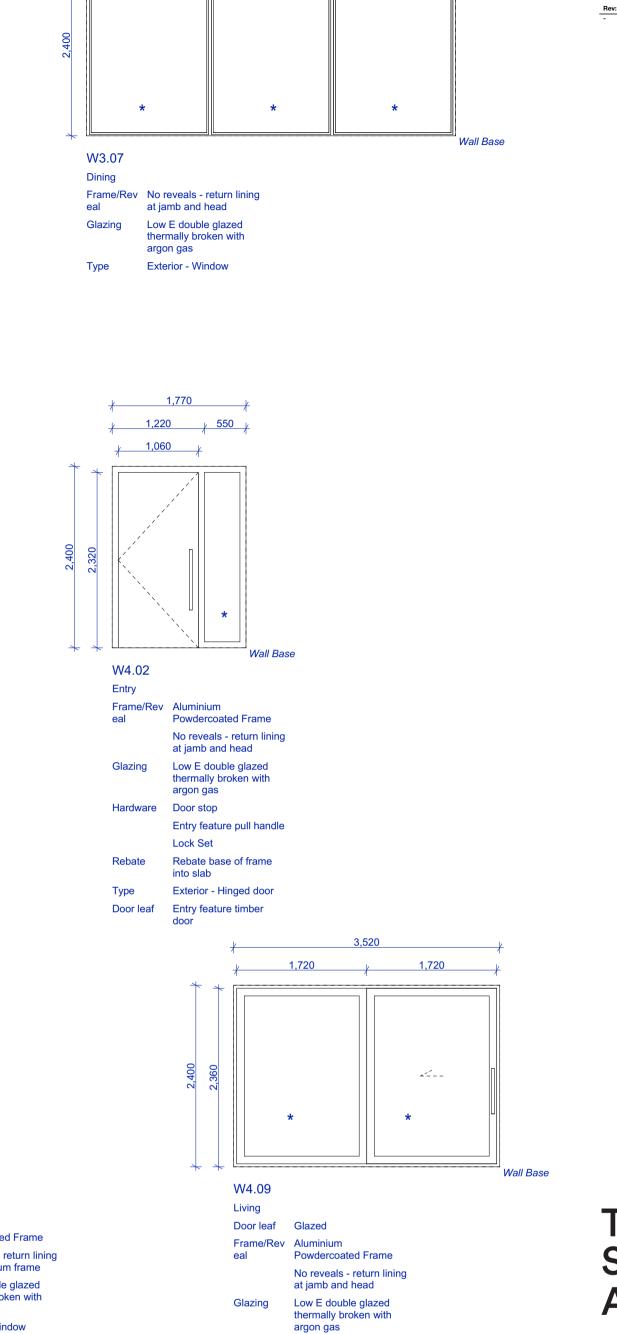Lock Set

Exterior - Sliding door